

DELEGATED REPORT

TO: COORDINATOR PLANNING & BUILDING
FROM: Supervisor Planning & Building **FILE:** OPW/25/0003
DATE: 19 August 2025

APPLICATION DETAILS

APPLICATION		PREMISES	
FILE NO:	OPW/25/0003	ADDRESS:	405 Chewko Road, Mareeba
APPLICANT:	BESTRACT	RPD:	Lot 71 on SP292140
LODGED BY:	BESTRACT	AREA:	28.73 hectares
DATE LODGED:	9 July 2025	OWNER:	Stelbay Pty Ltd
TYPE OF APPROVAL:	Development Permit		
PROPOSED DEVELOPMENT:	Operational Works (Internal/External Roadworks, Earthworks, Stormwater, Water Supply and On-site Carparking for Two Rivers Community School – Development Permit MCU/23/0012)		
PLANNING SCHEME:	Mareeba Shire Council Planning Scheme 2016		
ZONE:	Rural zone		
LEVEL OF ASSESSMENT:	Code Assessment		

PREVIOUS APPLICATIONS & APPROVALS

MCU/23/0012

DESCRIPTION OF PROPOSED DEVELOPMENT

- Operational Works (Internal/External Roadworks, Earthworks, Stormwater, Water Supply and On-site Carparking for Two Rivers Community School – Development Permit MCU/23/0012)

ASSESSMENT**State Planning Policy**

Separate assessment against the State Planning Policy (SPP) is not required because the Mareeba Shire Council Planning Scheme appropriately integrates all relevant aspects of the SPP.

Relevant Development Codes

The following Development Codes are considered to be applicable to the assessment of the application:

- 6.2.9 Rural zone code
- 9.4.4 Reconfiguring a lot code

9.4.5 Works, services and infrastructure code

The application did not include a planning report and assessment against the planning scheme. An officer assessment has found that the application satisfies the relevant acceptable solutions (or probable solutions/performance criteria where no acceptable solution applies) of the relevant codes set out below.

Relevant Codes	Comments
Rural zone code	The application can be conditioned to comply with the relevant acceptable outcomes contained within the code.
Reconfiguring a lot code	The application can be conditioned to comply with the relevant acceptable outcomes contained within the code.
Works, services and infrastructure code	The application can be conditioned to comply with the relevant acceptable outcomes contained within the code.

Compliance with conditions of earlier related approval

MCU/23/0012 – Material Change of Use – Educational Establishment

CONDITIONS

1. Development must be carried out generally in accordance with the approved plans and the facts and circumstances of the use as submitted with the application, subject to any alterations:
 - found necessary by Council's delegated officer at the time of examination of the engineering plans or during construction of the development because of particular engineering requirements; and
 - to ensure compliance with the following conditions of approval.
2. Timing of Effect
 - 2.1 The conditions of the development permit applicable to each stage must be complied with to the satisfaction of Council's delegated officer prior to the commencement of the relevant stage of the use except where specified otherwise in these conditions of approval.
 - 2.2 Prior to the commencement of each stage of the use, the applicant must notify Council that all the conditions of the development permit have been complied with, except where specified otherwise in these conditions of approval.
3. General
 - 3.1 The development approval would not have been issued if not for the conditions requiring the construction of infrastructure or the payment of infrastructure charges within the conditions of approval or the Adopted Infrastructure Charges Notice.
 - 3.2 The applicant/developer is responsible for the cost of necessary alterations to existing public utility mains, services or installations required by works in relation to the proposed development or any works required by condition(s) of this approval.

3.3 All payments or bonds required to be made to the Council pursuant to any condition of this approval must be made prior to commencement of the use and at the rate applicable at the time of payment.

3.4 All works must be designed, constructed and carried out in accordance with FNQROC Development Manual requirements (as amended) and to the satisfaction of Council's delegated officer.

3.5 Waste Management

3.5.1 On site refuge storage area/s must be provided and be screened from view from adjoining properties and road reserve by 1 metre wide landscaped screening buffer or 1.8m high solid fence or building.

3.5.2 Where bulk bins are used and are to be serviced on site, prior to the issue of a development permit for building works, Council's delegated officer must be satisfied that internal access is of adequate design and construction to allow waste collection/delivery vehicles to enter and exit the site in a forward gear only.

3.5.3 All waste storage areas must remain covered and no food scraps disposed of on-site so as to not encourage scavenging from wildlife and birdlife.

3.6 Noise Nuisance

Refrigeration equipment, pumps, compressors and mechanical ventilation systems must be located, designed, installed and maintained to achieve a maximum noise level of 3dB(A) above background levels as measured from noise sensitive locations and a maximum noise level of 8dB(A) above background levels as measured from commercial locations.

3.7 Air Conditioner & Building Plant Screening

The applicant/developer is required to install and maintain suitable screening to all air conditioning, lift motor rooms, plant and service facilities located at the top of or on the external face of the building. The screening structures must be constructed from materials that are consistent with materials used elsewhere on the facade of the building. There are to be no individual external unscreened air conditioning units attached to the exterior building facade.

3.8 Emissions

Emissions associated with the development must not cause an 'environmental nuisance' within the meaning of the Environmental Protection Act (1994) to any sensitive receptor.

3.9 Safety fencing

A child proof fence or physical barrier is provided to prevent unintended access to the following areas, directly from indoor or outdoor areas intended to accommodate children:

- (a) Vehicle manoeuvring and parking areas;
- (b) Refuse storage and servicing areas; and
- (c) Air conditioning, refrigeration plant and mechanical plant.

The location and extent of fencing shall be determined by the applicant/developer after carrying out a risk assessment.

3.10 Student Enrolments

The total number of enrolled students shall not exceed three hundred (300), unless prior approval is granted by Council for an expansion of the existing use.

3.11 Bushfire Management

3.11.1 A Bushfire Hazard Management Plan for the site, incorporating evacuation procedures, must be prepared to the satisfaction of Council's delegated officer. The approved use must comply with the requirements of the Bushfire Hazard Management Plan at all times.

3.11.2 An on-site water supply for firefighting purposes must be provided with a minimum capacity of 5,000 litres that must comprise either:

- (a) a stand-alone tank; or
- (b) a reserve section in the bottom part of the main water supply tank; or
- (c) a dam; or
- (d) a swimming pool.

Where tank water supply is provided, the outlet must be fitted with a 50mm ball valve with a camlock fitting for connection to firefighting appliances.

3.12 Biosecurity Management Plan

A Biosecurity Management Plan must be prepared and implemented for the site.

4. Infrastructure Services and Standards

4.1 Development Access

4.1.1 The access off Chewko Road must be designed and constructed in accordance with FNQROC Development Manual standard drawing for Rural Access S1105. The width and turn radius of the seal must be determined based on swept paths of the largest vehicle that would enter and exit the site.

- 4.1.2 The full length of the access road from Chewko Road to the property boundary must be upgraded/constructed to provide pavement and seal of a suitable standard to accommodate expected traffic volumes accessing the school.
- 4.1.3 The access road must be of a suitable width to accommodate two-way traffic including two buses passing each other. Turning paths confirming that vehicles can safely navigate the bends along the access road must be provided as part of the Operational Works application.
- 4.1.4 The railway level crossing must be upgraded in accordance with the State Assessment and Referral Agency response dated 30 May 2024.
- 4.1.5 The intersection of the existing access to the neighbouring properties to the south must be formalised from the new access road.

The works described above must be undertaken prior to commencement of use of Stage 1, at no cost to Council and will require approval under an Operational Works permit.

4.2 External Works

- 4.2.1 Design and construct the widening of Chewko Road pavement and seal on both approaches to the access intersection to provide trafficable shoulders of a width and length in accordance with Austroads Guide to Traffic Management Part 6 and Austroads Guide to Road Design Part 4A for a Rural Basic left and right turn treatment (BAL and BAR).

The works described above must be undertaken prior to commencement of use of Stage 1, at no cost to Council and will require approval under an Operational Works permit.

4.3 Revised Traffic Impact Assessment – Stage 6

- 4.3.1 A revised Traffic Impact Assessment (TIA) report must be submitted to Council prior to Stage 6 when all facilities constructed as part of Stage 1 to 5 is in operation. The TIA should analyse the impact that the development related traffic will have on Council's road network as a result of this stage and be based on actual traffic counts at the time.

Any external works determined to be required by Council following review of the revised assessment must be undertaken at no cost to Council and will require approval under an Operational Works permit.

4.4 Car Parking/Internal Driveways

- 4.4.1 The applicant/developer must ensure the development is provided with staged on-site car parking spaces generally in accordance with the approved plans, which are available solely for the parking of vehicles associated with the use of the premises.
- 4.4.2 All car parking spaces and internal driveways must be concrete, bitumen or asphalt sealed and appropriately drained prior to the commencement of the use and to the satisfaction of Council's delegated officer.
- 4.4.3 The car park must be designed in accordance with AS2890.1 Off-Street Car Parking including parking bay dimensions, aisle widths, speed control etc. The design is to be certified by an RPEQ that the car park provisions comply with Australian standards.
- 4.4.4 An internal traffic circulation design plan demonstrating swept paths must be submitted as part of the development application for Operational Works to demonstrate that adequate provision has been made for the manoeuvring of vehicles and buses.
- 4.4.5 All parking spaces and trafficable areas must be maintained in good order and safe repair for the life of the development, to the satisfaction of Council's delegated officer.

4.5 Stormwater Management

- 4.5.1 Prior to building or operational works commencing, the applicant/developer must submit a Stormwater Management Plan and Report prepared and certified by a suitably qualified design engineer (RPEQ) that meets or exceeds the standards of design and construction set out in the Queensland Urban Drainage Manual (QUDM) and the FNQROC Development Manual to the satisfaction of Council's delegated officer.

The Stormwater Management Plan must allow for the proposed staging of the development.
- 4.5.2 The Stormwater Management Plan must ensure a non-worsening effect on surrounding land as a consequence of the development, and must take all reasonable and practicable measures to ensure discharge occurs in compliance with the Queensland Urban Drainage Manual (QUDM) and the FNQROC Development Manual.
- 4.5.3 The applicant/developer must construct the stormwater drainage infrastructure for the development in accordance with the approved Stormwater Management Plan and Report.
- 4.5.4 All stormwater drainage must be collected from site and discharged to an approved legal point of discharge.

4.6 Landscaping and Fencing

- 4.6.1 Prior to the commencement of the use of the site, a landscape plan must be prepared and submitted to Council's delegated officer for consideration and approval.
- 4.6.2 The landscaping plan must incorporate the following:
 - (i) A minimum 10 metre wide vegetated landscape buffer for the full length of the buffer zone shown on the approved plans.
 - (ii) A minimum 10 metre wide vegetated landscape buffer for 115 metres along the common boundary with Lot 1 on RP708284, directly to the south of the sports field/running track.
 - (iii) A 1.8 metre high colorbond (neutral colour) solid screen fence must be established along the site's common boundary with Lot 1 on RP708284 for the full length of the vegetated landscape buffers required under (i) and (ii).
 - (iv) The planting of one (1) shade tree for every six (6) parking spaces.
- 4.6.3 Landscaping associated with 4.6.2 (i) and (ii) must include ground cover, shrubs and trees that will grow to form an effective buffer of no less than four (4) metres in height.
- 4.6.4 Plant species are to be generally selected from the Plant Schedule in Planning Scheme Policy 6 - Landscaping and preferred plant species.
- 4.6.5 The landscaping of the site must be carried out in accordance with the endorsed landscape plan/s, and prior to the commencement of the use, and mulched, irrigated and maintained to the satisfaction of Council's delegated officer.
- 4.6.6 All landscaping must be maintained for the life of the development.

4.7 Lighting

Where installed, external lighting must be designed and installed in accordance with AS4282 – *Control of the obtrusive effects of outdoor lighting* so as not to cause nuisance to residents or obstruct or distract pedestrian or vehicular traffic.

4.8 Non-Reticulated Water Supply

The development must be provided with a potable water supply that can satisfy the standards for drinking water set by the Australian Drinking Water Guidelines 2004 (National Health and Medical Research Council and the National Resource Management Ministerial Council). All non-potable sources of water must be sign posted "non-potable water supply".

4.9 On-Site Wastewater Management

All on site effluent disposal associated with the approved use must be in compliance with the latest version of On-Site Domestic Wastewater Management Standard (AS/NZ1547) to the satisfaction of the Council's delegated officer.

Note: Any on-site wastewater treatment system with a total daily peak design capacity of at least 21 equivalent persons (EP) is an Environmentally Relevant Activity (ERA 63 - Sewerage Treatment) and an Environmental Authority is required.

4.10 Electricity Supply

The development must be connected to the electricity supply network.

4.11 Telecommunications Infrastructure

The development must be provided with a connection to the national broadband network or telecommunication services.

FNQROC Regional Development Manual Checklist

Section	Assessment
DP1 - Development Principles	Complies
AP1 - Application Procedures	Complies
D1 - Road Geometry	Conditioned to Comply
D2 - Site Regrading	Complies
D3 - Road Pavements	Conditioned to Comply
D4 - Stormwater Drainage	Complies
D5 - Stormwater Quality Management	Complies
D6 - Water Reticulation	N/A
D7 - Sewerage System	N/A
D8 - Utilities	Complies
D9 - Landscaping	N/A

REFERRALS

Nil

Internal/External Consultation

Technical Services

OFFICER'S RECOMMENDATION

- That in relation to this operational works development application:

APPLICATION		PREMISES	
APPLICANT:	BESTRUCT	ADDRESS:	405 Chewko Road, Mareeba
DATE LODGED	9 July 2025	RPD:	Lot 71 on SP292140
TYPE OF APPROVAL	Development Permit		
PROPOSED DEVELOPMENT	Operational Works (Internal/External Roadworks, Earthworks, Stormwater, Water Supply and On-site Carparking for Two Rivers Community School – Development Permit MCU/23/0012)		

and in accordance with the Planning Act 2016, as amended, the applicant be notified that the application for operational works:

Approved subject to the following assessment manager conditions:

(A) APPROVED DEVELOPMENT: Development Permit for Operational Works (Internal/External Roadworks, Earthworks, Stormwater, Water Supply and On-site Carparking for Two Rivers Community School – Development Permit MCU/23/0012)

(B) APPROVED PLANS:

Plan/Document Number	Plan/Document Title	Prepared by	Dated
External Works			
LU23112-1-CD-100	COVER SHEET, LOCALITY & DRAWING SCHEDULES	Lekker Urban	13/05/2025
LU23112-1-CD-101	CONSTRUCTION NOTES	Lekker Urban	13/05/2025
LU23112-1-CD-102	EROSION & SEDIMENT CONTROL NOTES & DETAILS	Lekker Urban	13/05/2025
LU23112-1-CD-200	EROSION & SEDIMENT CONTROL PLAN	Lekker Urban	13/05/2025
LU23112-1-CD-201	CLEARING & DEMOLITION PLAN	Lekker Urban	13/05/2025
LU23112-1-CD-202	CIVIL SITE WORKS LAYOUT PLAN	Lekker Urban	13/05/2025
LU23112-1-CD-203	SIGNAGE & LINEMAKRING LAYOUT PLAN	Lekker Urban	13/05/2025
LU23112-1-CD-300	ROAD LONGITUDINAL SECTION - CHEWKO ROAD	Lekker Urban	13/05/2025
LU23112-1-CD-301	ROAD LONGITUDINAL SECTION - NEW ACCESS ROAD	Lekker Urban	13/05/2025
LU23112-1-CD-400	TYPICAL SECTIONS & DETAILS	Lekker Urban	13/05/2025
LU23112-1-CD-401	CROSS SECTIONS - CHEWKO ROAD - SHEET 1 OF 6	Lekker Urban	13/05/2025
LU23112-1-CD-402	CROSS SECTIONS - CHEWKO ROAD - SHEET 2 OF 6	Lekker Urban	13/05/2025
LU23112-1-CD-403	CROSS SECTIONS - CHEWKO ROAD - SHEET 3 OF 6	Lekker Urban	13/05/2025
LU23112-1-CD-404	CROSS SECTIONS - CHEWKO ROAD - SHEET 4 OF 6	Lekker Urban	13/05/2025
LU23112-1-CD-405	CROSS SECTIONS - CHEWKO ROAD - SHEET 5 OF 6	Lekker Urban	13/05/2025
LU23112-1-CD-406	CROSS SECTIONS - CHEWKO ROAD - SHEET 6 OF 6	Lekker Urban	13/05/2025

LU23112-1-CD-407	CROSS SECTIONS - NEW ACCESS ROAD - SHEET 1 OF 6	Lekker Urban	13/05/2025
LU23112-1-CD-408	CROSS SECTIONS - NEW ACCESS ROAD - SHEET 2 OF 6	Lekker Urban	13/05/2025
LU23112-1-CD-409	CROSS SECTIONS - NEW ACCESS ROAD - SHEET 3 OF 6	Lekker Urban	13/05/2025
LU23112-1-CD-410	CROSS SECTIONS - NEW ACCESS ROAD - SHEET 4 OF 6	Lekker Urban	13/05/2025
LU23112-1-CD-411	CROSS SECTIONS - NEW ACCESS ROAD - SHEET 5 OF 6	Lekker Urban	13/05/2025
LU23112-1-CD-412	CROSS SECTIONS - NEW ACCESS ROAD - SHEET 6 OF 6	Lekker Urban	13/05/2025
LU23112-1-CD-500	INTERSECTION DETAIL PLAN & KERB RETURNS SECTIONS	Lekker Urban	13/05/2025
LU23112-1-CD-501	RAIL CROSSING DETAIL PLAN	Lekker Urban	13/05/2025
LU23112-1-CD-600	DRAINAGE LONGITUDINAL SECTIONS	Lekker Urban	13/05/2025
LU23112-1-CD-601	DRAINAGE PIT SCHEDULES	Lekker Urban	13/05/2025
LU23112-1-CD-700	TYPICAL CONSTRUCTION DETAILS	Lekker Urban	13/05/2025
LU23112-1-CD-800	VEHICLE TURN MOVEMENT LAYOUT PLAN - SHEET 1 OF 2	Lekker Urban	13/05/2025
LU23112-1-CD-801	VEHICLE TURN MOVEMENT LAYOUT PLAN - SHEET 2 OF 2	Lekker Urban	13/05/2025
Internal Works			
CD-100	COVER SHEET, LOCALITY & DRAWING SCHEDULES	Lekker Urban	29/04/2025
CD-101	CONSTRUCTION NOTES	Lekker Urban	29/04/2025
CD-102	CONCEPT EROSION & SEDIMENT CONTROL NOTES	Lekker Urban	29/04/2025
CD-200	OVERALL GENERAL ARRANGEMENT LAYOUT PLAN	Lekker Urban	29/04/2025
CD-201	CONCEPT EROSION & SEDIMENT CONTROL LAYOUT PLAN	Lekker Urban	29/04/2025
CD-202	CLEARING & DEMOLITION LAYOUT PLAN	Lekker Urban	29/04/2025
CD-203	BULK EARTHWORKS LAYOUT PLAN	Lekker Urban	29/04/2025
CD-204	CIVIL SITE WORKS LAYOUT PLAN	Lekker Urban	29/04/2025
CD-300	ROAD LONGITUDINAL SECTIONS	Lekker Urban	29/04/2025
CD-301	ROAD LONGITUDINAL SECTIONS	Lekker Urban	29/04/2025
CD-302	ROAD LONGITUDINAL SECTIONS	Lekker Urban	29/04/2025
CD-400	TYPICAL ROAD SECTIONS	Lekker Urban	29/04/2025
CD-401	ROAD CROSS SECTIONS	Lekker Urban	29/04/2025
CD-402	ROAD CROSS SECTIONS	Lekker Urban	29/04/2025
CD-403	ROAD CROSS SECTIONS	Lekker Urban	29/04/2025
CD-404	ROAD CROSS SECTIONS	Lekker Urban	29/04/2025
CD-405	ROAD CROSS SECTIONS	Lekker Urban	29/04/2025
CD-406	ROAD CROSS SECTIONS	Lekker Urban	29/04/2025
CD-407	ROAD CROSS SECTIONS	Lekker Urban	29/04/2025
CD-408	ROAD CROSS SECTIONS	Lekker Urban	29/04/2025
CD-409	ROAD CROSS SECTIONS	Lekker Urban	29/04/2025
CD-410	ROAD CROSS SECTIONS	Lekker Urban	29/04/2025
CD-500	DETAIL LAYOUT PLAN	Lekker Urban	29/04/2025
CD-501	DETAIL LAYOUT PLAN	Lekker Urban	29/04/2025
CD-502	DETAIL LAYOUT PLAN	Lekker Urban	29/04/2025
CD-503	DETAIL LAYOUT PLAN	Lekker Urban	29/04/2025

CD-600	STORMWATER CATCHMENT LAYOUT PLAN	Lekker Urban	29/04/2025
CD-601	DRAINAGE LONGITUDINAL SECTIONS	Lekker Urban	29/04/2025
CD-602	DRAINAGE LONGITUDINAL SECTIONS	Lekker Urban	29/04/2025
CD-603	DRAINAGE PIT SCHEDULES & SETOUT	Lekker Urban	29/04/2025
CD-604	DETAIL LAYOUT PLAN & SECTIONS	Lekker Urban	29/04/2025
CD-605	DETAIL LAYOUT PLAN & SECTIONS	Lekker Urban	29/04/2025
CD-700	TYPICAL CONSTRUCTION DETAILS	Lekker Urban	29/04/2025
CD-701	TYPICAL CONSTRUCTION DETAILS	Lekker Urban	29/04/2025

(C) ASSESSMENT MANAGER'S CONDITIONS (COUNCIL)

1. General

- 1.1 Development must be carried out substantially in accordance with the approved plans and the facts and circumstances of the use as submitted with the application, and subject to any alterations:
 - found necessary by the Council's Delegated Officer at the time of examination of the engineering plans or during construction of the development because of particular engineering requirements;
 - to ensure the works comply in all respects with the requirements and procedures of the FNQROC Development Manual, Queensland Urban Drainage Manual and good engineering practice; and
 - to ensure compliance with the following conditions of approval.
- 1.2 All operational works must be designed and constructed in accordance with the design guidelines and procedures as set out in the FNQROC Development Manual, prior to works acceptance.
- 1.3 Plan Amendments

The following plan amendments must be made to the 'for construction' plans and submitted to Council for review prior to prestart meeting occurring:

 - The notation on plan no. LU23112-1-CD-202 must be amended to reference LU23112-1-CD-203 and not LU23112-1-CD-204.
 - *A notation must be added to plan no. LU23112-2-CD-203 stating that owners consent must be obtained from the owners of Lot 1 on RP708284 prior to any earthworks occurring that may impact on this allotment.*
- 1.4 Deep lift asphalt shall be provided over culvert 1.A-1.B in order to achieve adequate coverage. The 'for construction' plans must be amended to reflect this prior to prestart meeting occurring.
- 1.5 'For Construction' Engineering Drawings, inclusive of any amendments required by Conditions of this Permit, must be certified as approved by a suitably qualified RPEQ Engineer and a copy submitted to Council, prior to Commencement of Work.

1.6 Where any part of Council's existing infrastructure or land is damaged as a result of construction activities occurring on the land, including but not limited to; mobilisation of heavy construction equipment, stripping, grubbing and vegetation damage, notify Council immediately of the affected infrastructure or land and have it repaired, replaced or reinstated at no cost to Council, prior to Works Acceptance.

1.7 Runoff Generally

All reasonable and practicable measures must be taken to prevent pollution entering existing creeks, waterways or drainage lines, as a result of silt run-off, oil and grease spills from any machinery. Wastewater as a result of cleaning equipment must not be discharged directly or in-directly to any watercourses, stormwater systems or private properties (in accordance with the requirements of the Environmental Protection Act (1994), the FNQROC Development Manual and Best Practice Erosion & Sediment Control – IECA Australasia).

1.8 Earthworks Construction

All earthworks must be constructed in accordance with AS 3798: Guidelines on earthworks for commercial and residential developments. At the completion of works, RPEQ Certification of the works and test results are required to be provided to Council, prior to Works Acceptance.

1.9 Stormwater Drainage

Stormwater drainage as shown on the Approved Plan(s), must be constructed in accordance with the relevant design and specifications sections of the FNQROC Development Manual and the Queensland Urban Drainage Manual, prior to Works Acceptance.

All stormwater from the land must be directed to a lawful point of discharge as per the Approved Plan(s) such that it does not adversely affect surrounding properties or properties downstream from the development, in accordance with the Queensland Urban Drainage Manual.

1.10 Council's examination of the documents should not be taken to mean that the documents have been checked in detail and Council takes no responsibility for their accuracy. If during construction, inadequacies of the design are discovered, it is the responsibility of the Principal Consulting Engineer to resubmit amended plans to Council for approval and rectify works accordingly.

2. Pre-start Meeting

2.1 In addition to the requirements of Clause CP1.07 and CP1.08 of the FNQROC Development Manual; after documentation has been approved by Council, a pre-start meeting is to be held on site prior to the commencement of work. Part 1 of the **attached** pre-start meeting pro-forma is to be completed and returned prior to the meeting including clause 1.u 'Request for Meeting' together with the prescribed Construction Monitoring Fee as set out in Council's Schedule of Fees.

3. Inspections

- 3.1 Inspections are to be carried out as detailed in the FNQROC Manual unless advised otherwise at the pre-start meeting.

4. Construction Security Bond and Defects Liability Bond

- 4.1 In addition to Clauses CP1.06 and CP1.20 of the FNQROC Development Manual; the Construction Security Bond and Defects Liability Bond shall each be a minimum of \$1000 and Bank Guarantees shall have no termination date.
- 4.2 During the Defects Liability period, it is the responsibility of the developer to rectify any works found to be defective due to design faults and or found to exhibit faults attributed to the performance of the construction activities in terms of quality and conformance with design and specifications. The bond will be returned on satisfactory correction of any defective work and after expiration of the maintenance period. Failure to comply with a Council issued instruction to correct defective work may result in the call up of the bond to have the work completed.

5. Hours of Work

- 5.1 Work involving the operation of construction plant and equipment of any description, shall only be carried out on site during the following times:
- 7.00am to 6.00pm, Monday to Friday;
 - 7.00am to 1.00pm Saturdays;
 - No work is permitted on Sundays or Public Holidays.
- 5.2 No variation to the above working hours is allowed unless otherwise agreed in writing by Council.

6. Transportation of Soil

- 6.1 All soil transported to or from the site must be covered to prevent dust or spillage during transport. If soil is tracked or spilt onto the road pavement from works on the subject land, it must be removed no later than at the end of each working day. Sediment must not enter Council's stormwater drainage network.

(D) RELEVANT PERIOD

When approval lapses if development not started (s.85)

- Two (2) years (starting the day the approval takes effect).

(E) OTHER NECESSARY DEVELOPMENT PERMITS AND/OR COMPLIANCE PERMITS

- Nil

DECISION BY DELEGATE

DECISION

Having considered the Officers report detailed above, I approve, as delegate of Council, the application subject to the conditions listed in the report.

Dated the 19th day of AUGUST 2025



BRIAN MILLARD
COORDINATOR PLANNING & BUILDING

MAREEBA SHIRE
AS DELEGATE OF THE COUNCIL

ATTACHMENT 1

ON BEHALF OF TWO RIVERS COMMUNITY SCHOOL

STAGE 1 & 2 - EXTERNAL CIVIL WORKS

CHEWKO ROAD & 267 MCIVER ROAD, MAREEBA QLD

TWO RIVERS COMMUNITY SCHOOL

CIVIL ENGINEERING DRAWING LIST

DRAWING NUMBER	SHEET TITLE	REVISION
LU23112-1-CD-100	COVER SHEET, LOCALITY & DRAWING SCHEDULES	A
LU23112-1-CD-101	CONSTRUCTION NOTES	A
LU23112-1-CD-102	EROSION & SEDIMENT CONTROL NOTES & DETAILS	A
LU23112-1-CD-200	EROSION & SEDIMENT CONTROL PLAN	A
LU23112-1-CD-201	CLEARING & DEMOLITION PLAN	A
LU23112-1-CD-202	CIVIL SITE WORKS LAYOUT PLAN	A
LU23112-1-CD-203	SIGNAGE & LINEMARKING LAYOUT PLAN	A
LU23112-1-CD-300	ROAD LONGITUDINAL SECTION - CHEWKO ROAD	A
LU23112-1-CD-301	ROAD LONGITUDINAL SECTION - NEW ACCESS ROAD	A
LU23112-1-CD-400	TYPICAL SECTIONS & DETAILS	A
LU23112-1-CD-401	CROSS SECTIONS - CHEWKO ROAD - SHEET 1 OF 6	A
LU23112-1-CD-405	CROSS SECTIONS - CHEWKO ROAD - SHEET 2 OF 6	A
LU23112-1-CD-406	CROSS SECTIONS - CHEWKO ROAD - SHEET 3 OF 6	A
LU23112-1-CD-407	CROSS SECTIONS - CHEWKO ROAD - SHEET 4 OF 6	A
LU23112-1-CD-408	CROSS SECTIONS - CHEWKO ROAD - SHEET 5 OF 6	A
LU23112-1-CD-409	CROSS SECTIONS - CHEWKO ROAD - SHEET 6 OF 6	A
LU23112-1-CD-410	CROSS SECTIONS - NEW ACCESS ROAD - SHEET 1 OF 6	A
LU23112-1-CD-411	CROSS SECTIONS - NEW ACCESS ROAD - SHEET 2 OF 6	A
LU23112-1-CD-412	CROSS SECTIONS - NEW ACCESS ROAD - SHEET 3 OF 6	A
LU23112-1-CD-500	CROSS SECTIONS - NEW ACCESS ROAD - SHEET 4 OF 6	A
LU23112-1-CD-501	CROSS SECTIONS - NEW ACCESS ROAD - SHEET 5 OF 6	A
LU23112-1-CD-600	CROSS SECTIONS - NEW ACCESS ROAD - SHEET 6 OF 6	A
LU23112-1-CD-601	DRAINAGE PIT SCHEDULES	A
LU23112-1-CD-700	VEHICLE TURN MOVEMENT LAYOUT PLAN - SHEET 1 OF 2	A
LU23112-1-CD-801	VEHICLE TURN MOVEMENT LAYOUT PLAN - SHEET 2 OF 2	A

REFER TO DRAWING LU23112-2-CD-100 FOR THE INTERNAL WORKS DETAILS

PROJECT ISSUES MANAGEMENT	
Project Issues	
C.H.M.L.	RISKS, DESIGN ISSUES, DISCUSSIONS
H	WORKS WITHIN THE ROAD RESERVE ON THE WICKINGA ROAD AND THE CONSTRUCTION OF THE NEW ACCESSED ROAD ARE WITHIN THE DIRECT VICINITY OF OVERHEADED POWER LINES
M	WORKS WITHIN THE RAIL CORRIDOR
H	WORKS TO THE EXISTING RAIL
H	WORKS TO THE EXISTING RAIL CROSSING WITHIN THE ROAD RESERVE EXCETO THE LIMITS OF THE RAIL CORRIDOR. THE WORKS ARE RECOMMENDED TO BE CONDUCTED OUTSIDE THE BOUNDARY OF THE RAIL CORRIDOR.

RECOMMENDATION

CONTRACTOR TO ENSURE ALL RELEVANT MEASURES ARE IN PLACE TO UNDERTAKE THE WORKS SAFELY
IF PHYSICAL ACCESS TO AND CONTROLLED BY CHEWKO ROAD IS REQUIRED FOR ANY REASON, A LICENCE AGREEMENT WILL NEED TO BE EXECUTED BETWEEN THE THIRD PARTY AND QUEENSLAND RAIL. SIMILARLY IF WORKS ARE OCCURRING ADJACENT TO THE RAIL CORRIDOR AND HAVE THE POTENTIAL TO DISTURB OR DAMAGE THE EXISTING RAIL INFRASTRUCTURE, QUEENSLAND RAIL MUST BE CONNECTED TO A DIFFERENT CONTRACTOR IF A LICENSE IS REQUIRED.
ONCE THE EXISTING RAIL IS GUARDED, THE PROJECT TEAM WILL INSTALL THE CONCRETE CROSSING IN ACCORDANCE WITH THE LEVEL OF THE EXISTING RAIL LINE AND INSTALL STATION STANDARD DRAWING 881 - PON CONCRETE CROSSINGS.
CHEWKO ROAD IS OWNED AND MAINTAINED BY QUEENSLAND GOVERNMENT DEPARTMENT OF HIGHWAYS STATION STANDARD DRAWING 881 - PON CONCRETE CROSSINGS.
CLIENT/PROJECT MANAGER/ENGINEER AND RAIL TO CONFIRM THAT WORKS CAN ENCROACH THE BOUNDARIES PRIOR TO COMMENCING WORKS AND OBTAIN WORKERS CONSENT TO BE PROMPTED BY CHIRIN FOR WRITTEN APPROVAL.

REVISION

Amendment

Date

10/06/2025

Approved

J.L.A.

10/06/2025

Drawn

10/06/2025

Checked

10/06/2025

Supervised

10/06/2025

Approved

10/06/2025

Drawn

10/06/2025

Checked

10/06/2025

Supervised

10/06/2025

EROSION AND SEDIMENT CONTROL PLANS

- ## 1. MINIMISE EXTENT AND DURATION OF DISTURBANCE

1.3. MINIMIZE DISTURBANCE OF VEGETATION ALONG THE ROAD VERGE WITH SPECIAL EMPHASIS ON PLANTINGS STRATEGICALLY LOCATED TO MITIGATE EROSION AND STABILIZE SLOPES. CONSTRUCTION ACTIVITIES ADJACENT TO WATERCOURSES (E.G. MAINTAIN GRASSY BUFFER WHERE POSSIBLE).

- 1.2. WHERE POSSIBLE,**
MINIMIZE EXTENT OF DISTURBANCE WITHIN CONSTRUCTION SITE AT ANY ONE TIME BY STAGING THE WORKS (E.G. RIP, MOVING DITCHES AND SECTIONS MOVING ON TO NEW SECTIONS FOLLOWING COMPLETION OF PREVIOUS STAGED CONSTRUCTION ACTIVITIES) ADDED TO WATER CONSESSES AS A WIN-WIN-GROW-GROW-GROW IN MANAGEMENT OF CONSTRUCTION ACTIVITIES.

1.3. CONSTRUCTION ACTIVITIES ADDED TO WATER CONSESSES AS A WIN-WIN-GROW-GROW-GROW IN MANAGEMENT OF CONSTRUCTION ACTIVITIES.

2. CONTROL STORMWATER RUNOFF THROUGH AND FROM THE SITE

2.1. SEPARATE CLEAN RUNOFF WATER FROM DIRTY (E.G. TURBID CONSTRUCTION AREA RUNOFF) MAINTAIN CLEAN WATER PASSAGE THROUGH COVEY CROSSINGS THROUGHOUT CONSTRUCTION WORKS).

2.2. CONSTRUCT PERMANENT DRINKABLE STRUCTURES EARLY IN THE PROJECT INCLUDING:

3 | USE EBOSSON CONTROLS MEASURES TO PREVENT ON SITE DAMAGE

- 3.1. THE INSTALLATION OF ALL EROSION AND SEDIMENT CONTROLS TO OCCUR IMMEDIATELY POST CLEARING AND STRIPPING.**
 - 3.2. SITE STOCKPILES OF SOIL MATERIAL IN LOW-HAZARD AREAS CLEAR OF WATERCOURSES; ADDITIONAL PROTECTION TO BE PROVIDED FOR HIGH HAZARD AREA STOCKPILES.**
 - 3.3. CONSTRUCT A RANGE OF EROSION CONTROL MEASURES AS RECOMMENDED IN THE EROSION CONTROL DESIGN GUIDE TO COMPLY WITH THE REQUIREMENTS OF THIS SECTION.**

4. USE SEDIMENT CONTROL MEASURES TO

- 4.1. THE INSTALLATION OF ALL EROSION AND SEDIMENT CONTROLS TO OCCUR IMMEDIATELY POST CLEARING AND STRIPPING.
 - 4.2. CONSTRUCT CONTROL MEASURES AS CLOSE TO THE POTENTIAL SOURCE OF SEDIMENT AS POSSIBLE.
 - 4.3. CONTROL THE DEPOSITION OF MUD AND SOIL MATERIAL ONTO LOCAL ROADS.

5.1. ALL BATTER STABILISATION AND REINSTATEMENT WORKS ADJACENT TO AS SOON AS POSSIBLE AFTER COMPLETION OF CONSTRUCTION WORKS


- 5.2 ALL DISTURBED VERTICES AND TILL BATTERS TO BE STABILIZED BY REVEGETATION WITH APPROPRIATE SPECIES (E.G. ANNUAL GRASS SEED SUCH AS ANNUAL RYegrass OR JAPANESE MILLET, OR TURF) AS SOON AS PRACTICAL AFTER REUSEMENT OF IMPORTED QUALITY TOPSOIL TO A 5>0 DEGREE SLOPE OF A SANDY LOAM, FREE FROM NUT GRASS
5.3 ENSURE THE SUCCESS OF THE LATER REVEGETATION PROGRAM BY UTILIZING A GOOD TOPSOIL MANAGEMENT PROGRAM

6. INSPECT AND MAINTAIN CONTROL MEASURES

- 6.1.** ENSURE THE PROGRESSIVE AND CONTINUAL IMPLEMENTATION AND MAINTENANCE OF SEDIMENT CONTROLS (E.G. SEDIMENT FENCES, DIVERSIONS, BANKS, ETC.).
6.2. INITIATE A PROGRAM TO ENSURE REGULAR MAINTENANCE OF ALL EROSION CONTROL STRUCTURES (E.G. SCRAPE AWAY ACCUMULATED SEDIMENT, CLEANED FROM STRUCTURES (E.G. SCRAPER/REPAIR AS NECESSARY) TO MAINTAIN FUNCTIONALITY.

6.4. EVENTS TO MONITOR THE FUNCTIONING OF CONTROLS, ALL EROSION AND SEDIMENT CONTROLS TO BE MAINTAINED IN PLACE (CONTINUED)

21/8/2025

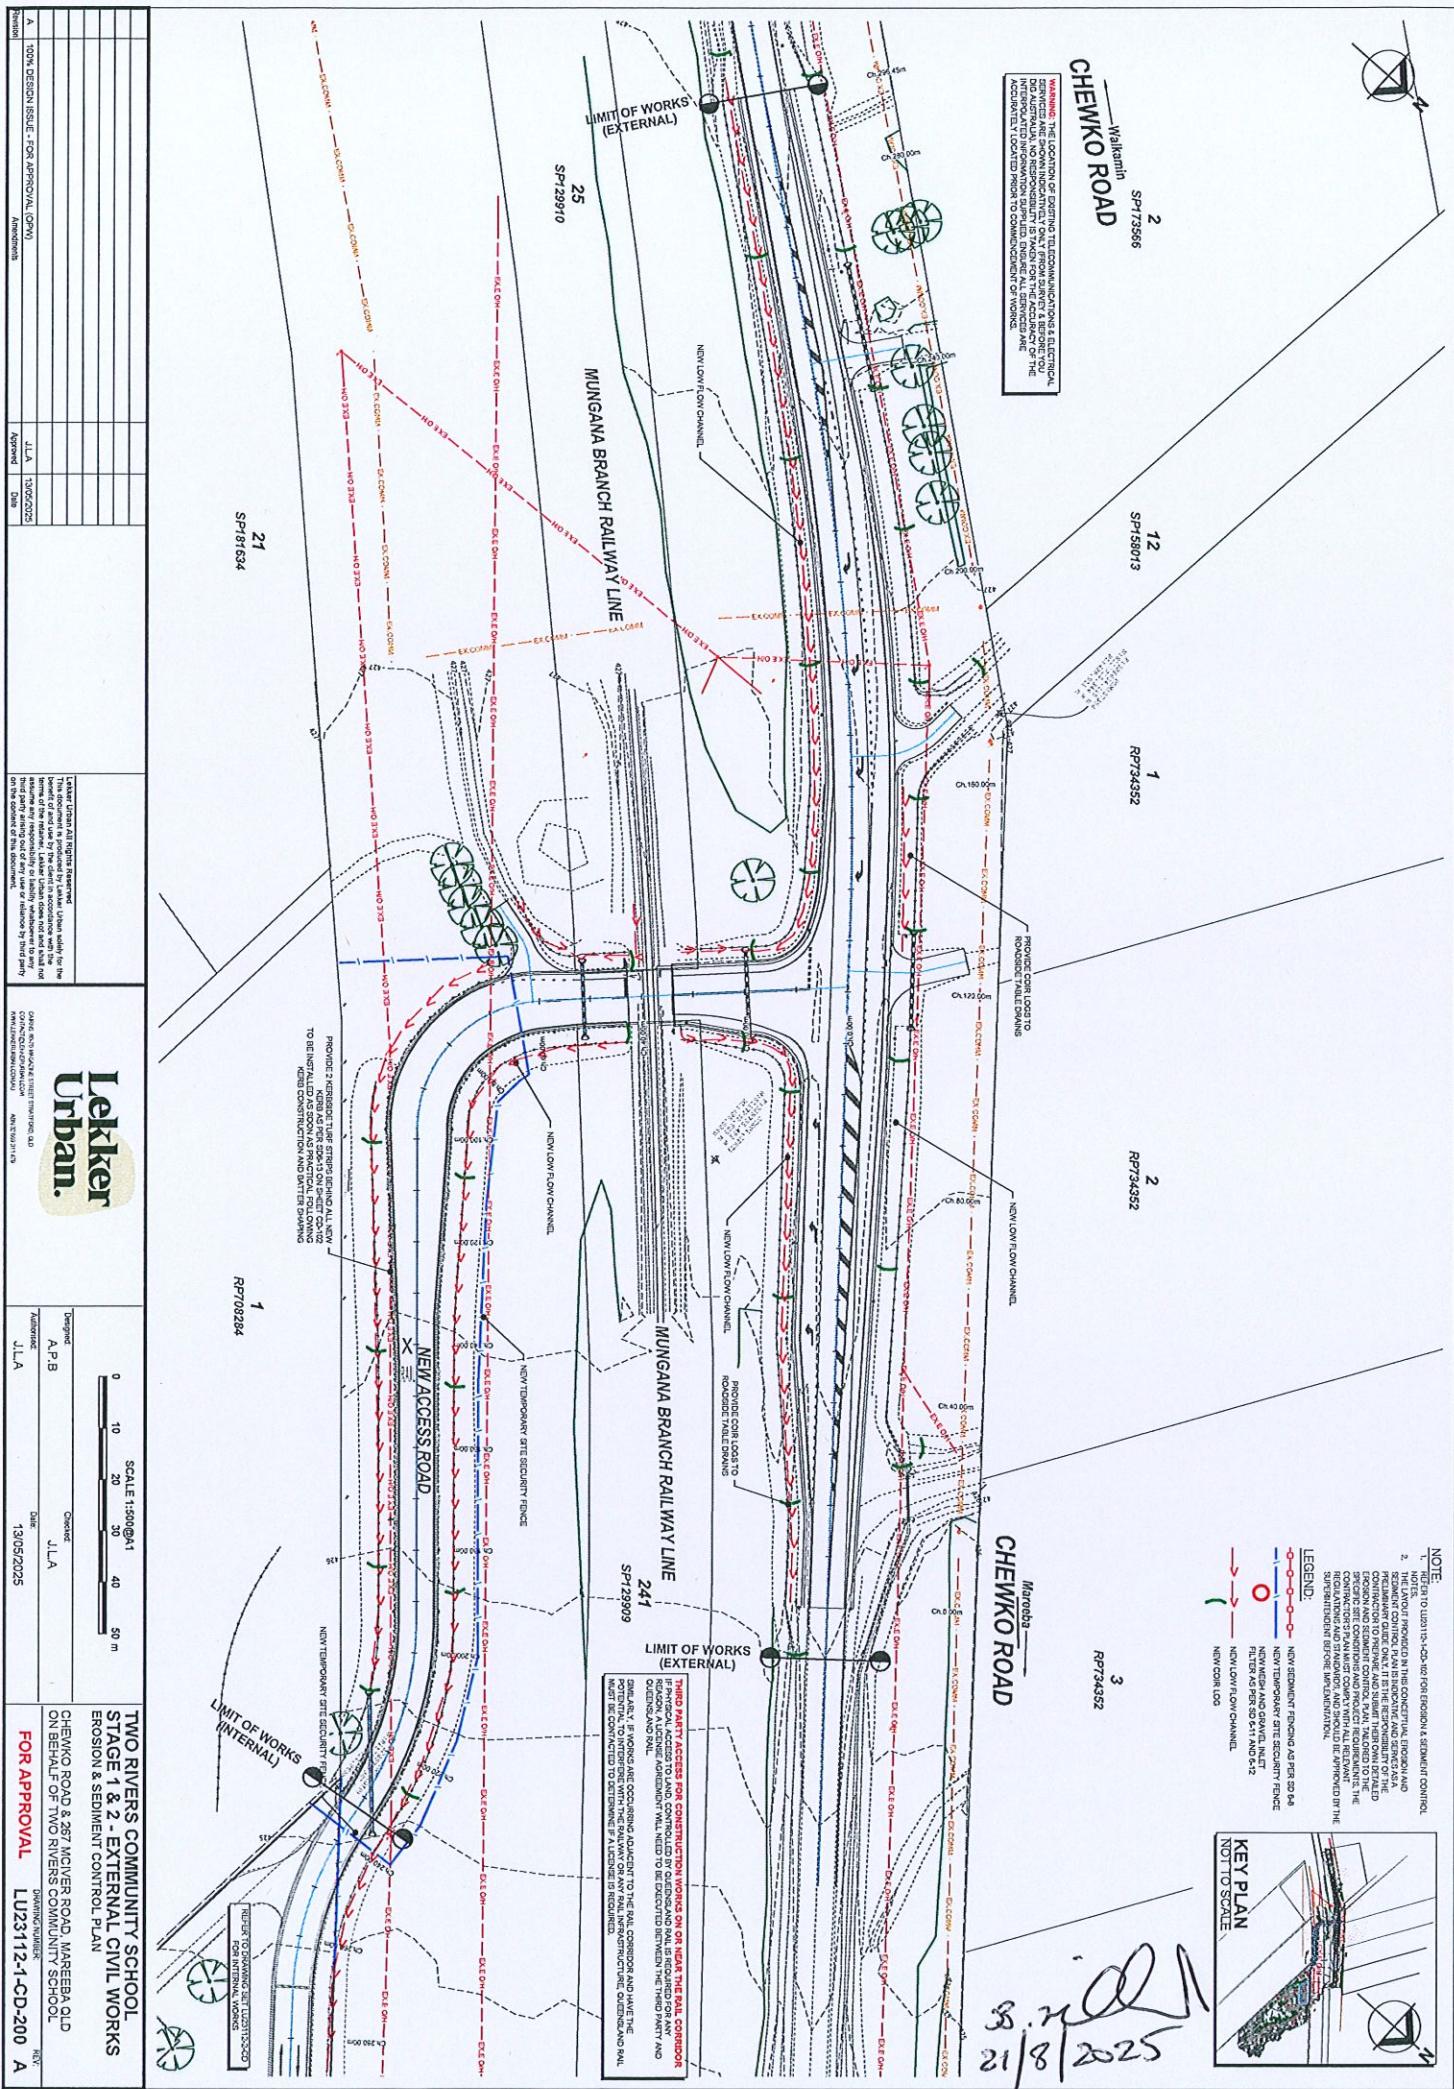

NOTE:
TO COORDINATE SURVEY HAS BEEN UNDERTAKEN BY THE SURVEYING
ON SITE DOCUMENTATION FOR WORKS ON THE INTERNAL
SURVEY DOCUMENTATION FOR WORKS ON THE INTERNAL
ACCURACY OF THE SURVEY

LEGEND:

— DASHED — DUSTING CONTOURS @ 5m INTERVAL

X (LINE) DUSTING LEVEL

— DASHED — DUSTING CONTOURS @ 5m INTERVAL

— DASHED — DUSTING DRAGGAGE

— DASHED — DUSTING ELECTRICAL, OVERHEAD

— DASHED — DUSTING ELECTRICAL, UNDERGROUND

— DASHED — DUSTING TREE TO BE REMOVED

— DASHED — DUSTING TREE TO BE REMAIN

— DASHED — DUSTING TRENCH TO BE REMOVED

— DASHED — TITLE BOUNDARY

— DASHED — PAYMENT STRUCTURE TO BE REMOVED

& DISPOSED AT AN APPROVED SITE

TO BE FILLED WITH 5mm

REMOVED EXISTING OR DUSTING PAYMENT

NOT TO SCALE

KEY PLAN

REV. A

CHEWKO ROAD

SP173586

Willatmin

SP158013

RPT34332

2

CHEWKO ROAD

RPT34332

Maresso

3

Maresso

2

Maresso

1

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WARNING: THE LOCATION OF EXISTING TELECOMMUNICATIONS & ELECTRICAL SERVICES ARE SHOWN INDICATIVELY ONLY FROM SURVEY & BEFORE YOU DIG A DITCH, AND NO RESPONSIBILITY IS TAKEN FOR THE ACCURACY OF THE INTERPOLATED INFORMATION SUPPLIED. ENSURE ALL SERVICES ARE ACCURATELY LOCATED PRIOR TO COMMENCEMENT OF WORKS.

SP173566

SP158013 12

RPT34352

RPT34352 2

EXISTING FEATURES WITHIN THE
MAJOR CONTOURS: 1m INTERVAL
MINOR CONTOURS: 0.5m INTERVAL


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TITLE BONANZIA
HOLLAND
NEW BOLDARD REFER TO SHEET CO-7070

TE.
TOPOGRAPHIC SURVEY WAS
ON 20TH NOVEMBER 2024 AT
NOTTOSCALE

LEGEND:

	DURING CONSTRUCTION (5' INTEGRAL)	DRIVERS PROPOSED NOT RECOMMENDED
	EXISTING CONSTRUCTION (5' INTERVAL)	DRIVERS PROPOSED NOT RECOMMENDED
	X (5') NEW DRAINSAGE PIPE, PIT & STRUCTURE NO.	DRIVERS PROPOSED RURAL PROPERTY ACCESS PER STOKE ST 51620
	DOCTING REMOVAL	DRIVERS PROPOSED NOT RECOMMENDED
	NEW SURFACE DRAINAGE LINE	DRIVERS PROPOSED NOT RECOMMENDED

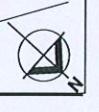

CHEWKO ROAD

Wilkamain

2

SPP75956


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RPT734352

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RPT734352

LINE MARKING LEGEND:	
EDGE LINE:	EL1 —————— 10mm
CONTINUITY LINE:	CL1 —————— 10mm
OUTLINE WARNING:	OL1 —————— 10mm
DOUBLE ONE WAY PARTER LINE:	BL1 —————— 10mm (only)
SINGLE TWO WAY PARTER LINE:	BL2 —————— 10mm
STOP LINE:	SL —————— 40mm
OUTLINE WARNING:	OL2 —————— 10mm
NEW TRAFFIC SIGN:	NTS —————— 10mm
NEW ROAD EDGE SUPPORT:	NRES —————— 10mm



NOT TO SCALE
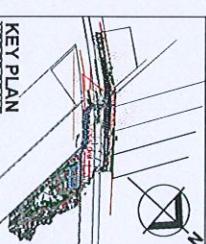
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CHEWKO ROAD

Wilkamain

2

SPP75956

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RPT734352

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CHEWKO ROAD

Mareeba

2

SPP75956

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LIMIT OF WORKS (EXTERNAL)

SP129910

25

SP129910

SIGNAGE AND LINE MARKING NOTES


- CHEWKO ROAD DESIGN: 100m TYPICAL POSTED + 10m
- PAVEMENT MARKINGS SHALL BE IN ACCORDANCE WITH THE AUSTRALIAN STANDARD AS 1742
- MANUAL OF UNIFORM TRAFFIC CONTROL, SERVICES (AUSTRALIA)
- THE QUEENSLAND MANUAL OF UNIFORM TRAFFIC CONTROL, SERVICES (QUEENSLAND BUTCO)
- PROCESSES ONLY REQUIREMENTS AND RECOMMENDATIONS SPECIFIC TO QUEENSLAND, EXCEPT WHERE THE AUSTRALIAN STANDARD SPECIFIES A DIFFERENT REQUIREMENT
- EDGE LINE RETROREFLECTIVE PAVEMENT MARKERS (REFPINS) SHALL BE INSTALLED 50mm FROM THE BOTTOM OF THE TRAFFIC LANE SIDE, THE RIGHT HAND SIDE OF THE TRAFFIC LANE (EDGE LINE).
- THE BOTTOM OF ALL UNPAVED SIGN POSTS SHALL BE FLATTENED PRIOR TO THE INSTALLATION OF THE SIGN POST.
- ALL SIGN POSTS SHALL BE USED ON ALL REMAINING SIGNAGE.
- STREET NAME SIGNS SHALL BE INSTALLED IN ACCORDANCE WITH PAVEMENT STANDARD DRAWING SIGN STREET NAME SIGNS.
- ALL SIGNS ARE TO BE POSITIONED AND INSTALLED IN ACCORDANCE WITH PAVEMENT STANDARD DRAWING SIGN TRAFFIC CONTROL DEVICES.
- WHERE THE AUSTRALIAN STANDARD SPECIFIES A DIFFERENT REQUIREMENT, THE AUSTRALIAN STANDARD SHALL NOT BE CONSIDERED.
- GUIDE POSTS SHALL CONFORM TO AND BE INSTALLED INSTALLED IN ACCORDANCE THE AUSTRALIAN STANDARD FOR CHEVRON MARKING DETAILS REFER TO FIGURE 24(b) - PAINTED ISLAND (AT CHANNELLED RIGHT TURN) OF AS 1742-2000 FOR ADDITIONAL DETAILS.
- PAINT USED SHALL BE WATERBORNE, ROAD MARKING PAINT CONFORMING TO THE APPROVED SOIL METALS AND SPECIFICATION AS PER AS/NZS 2870.1.
- TWO COATS OF PAINT AND GLASS BEADS SHALL BE APPLIED ON LONGITUDINAL LINES TO NEW SURFACES.
- REFLECTIVE GLASS BEADS SHALL BE TYPE B, C, D GLASS BEADS AS DESCRIBED IN AS 2000.

MUNGANA BRANCH RAILWAY LINE

SP129910

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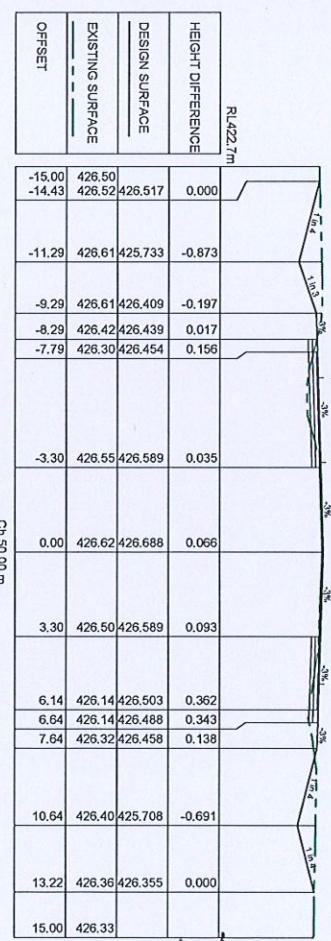
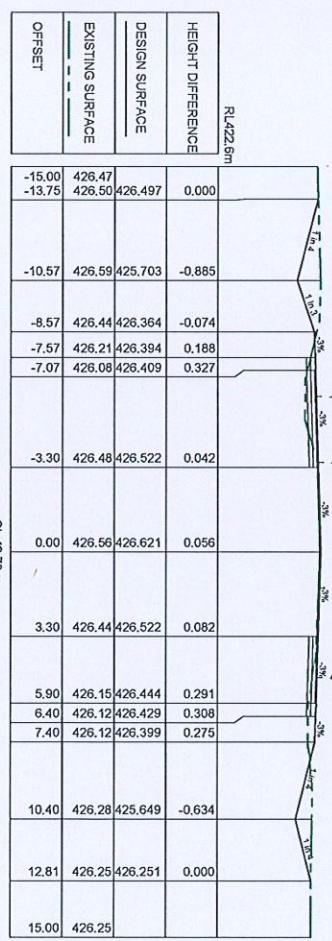
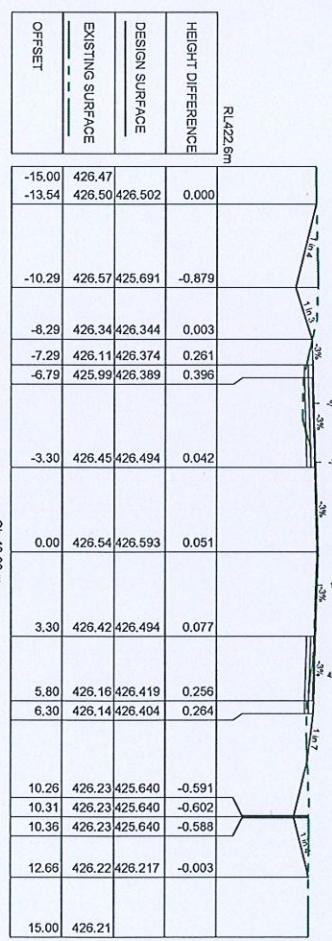
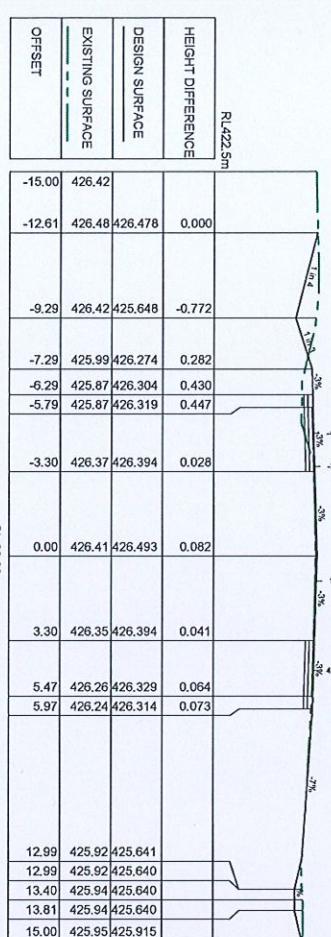
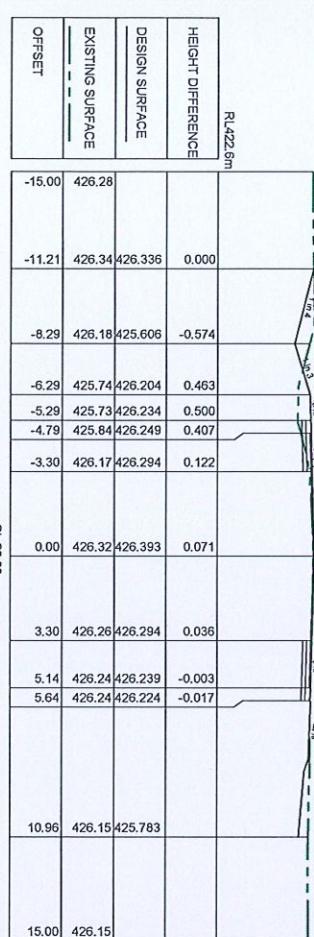
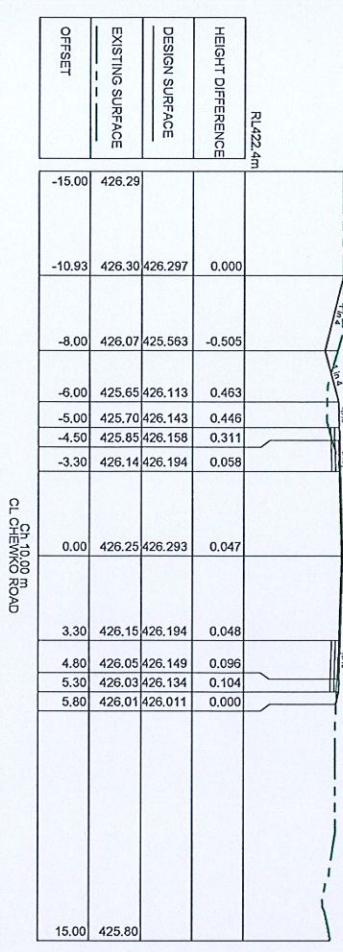
SP12

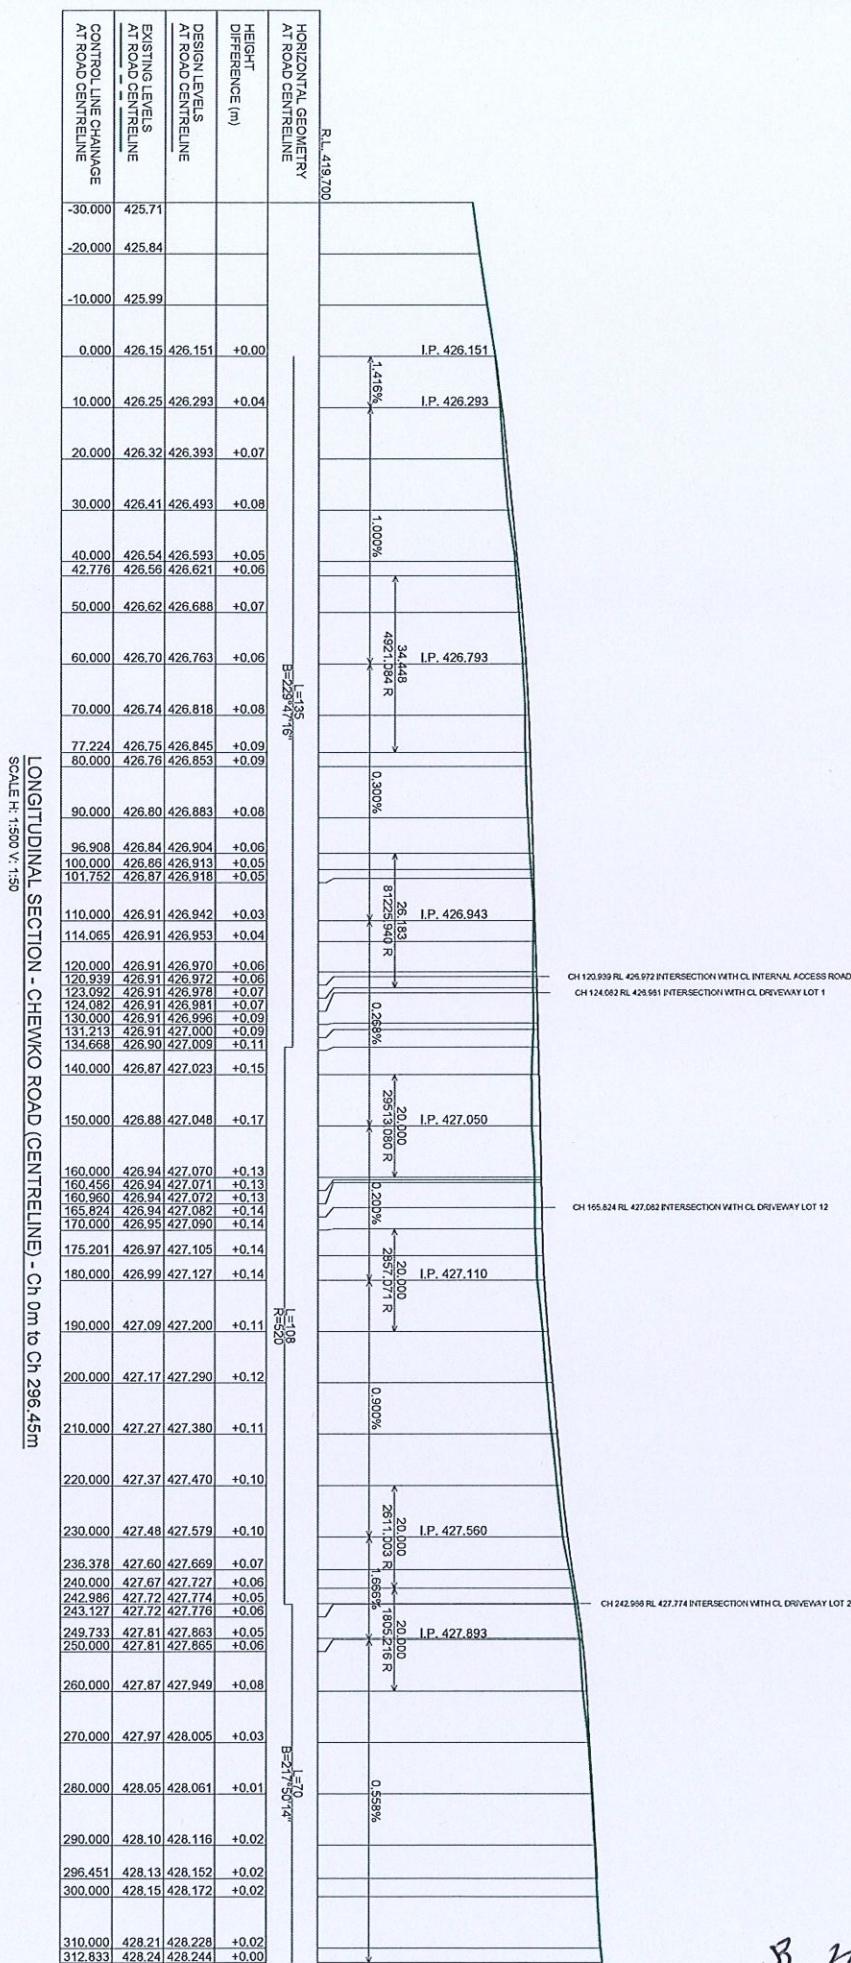

B. N. D.

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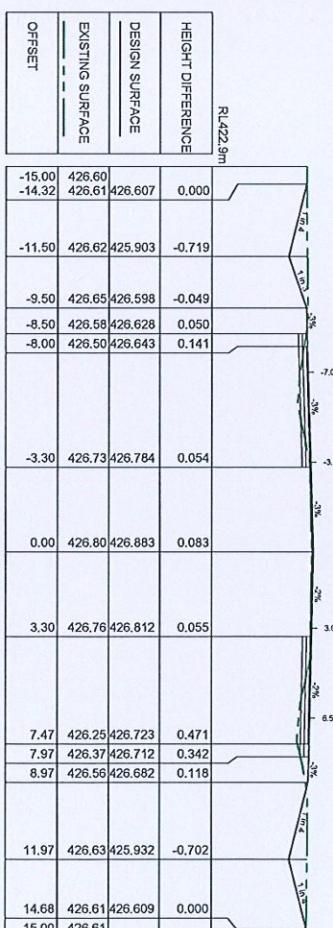
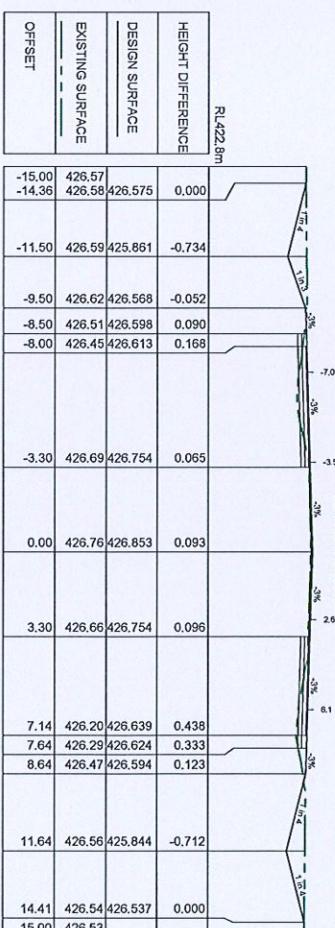
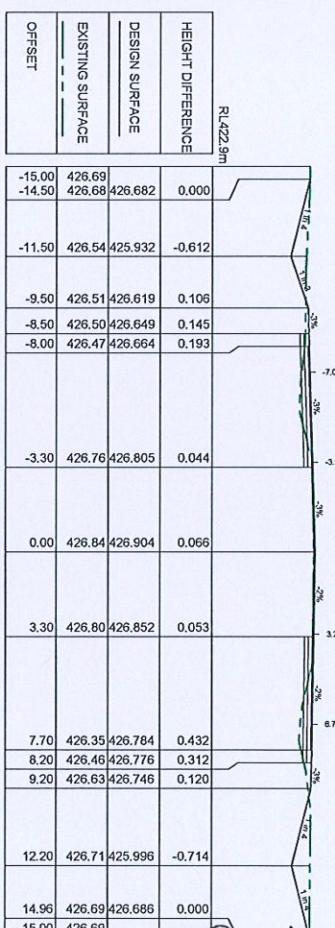
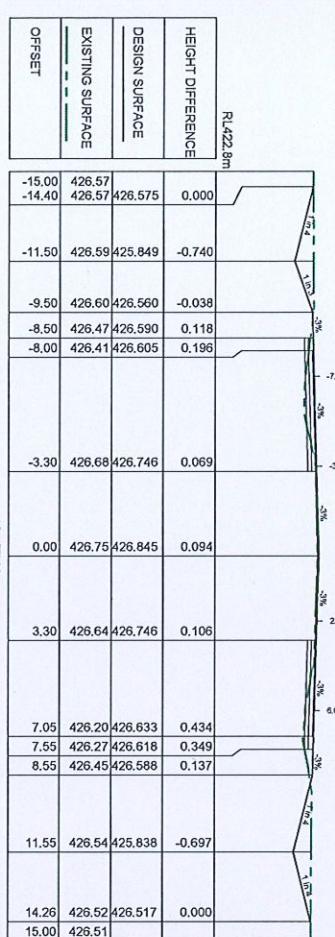
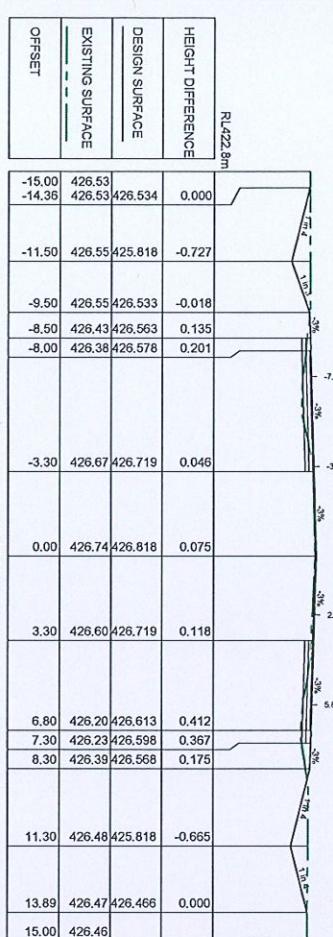
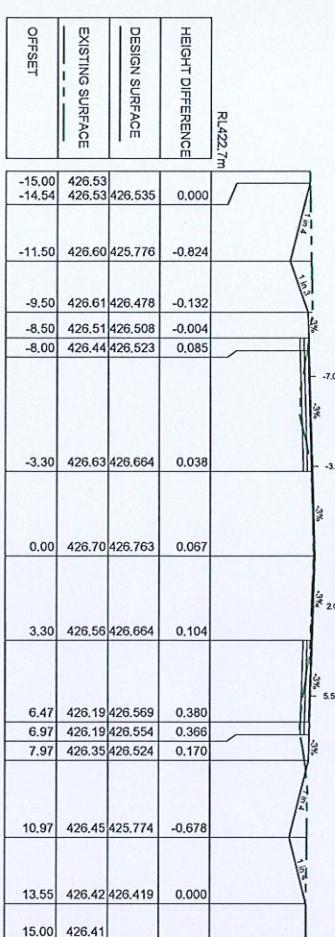
A	100% DESIGN ISSUE FOR APPROVAL (DWV)	Approved
	Annotations	Date



Lekker Urban.	
Design:	J.L.A
Approved:	J.L.A
Date:	13/05/2025
CL CHEWKO ROAD	
SCALE 1:100 @ A1	
0 2 4 6 8 10 m	
TWO RIVERS COMMUNITY SCHOOL STAGE 1 & 2 - EXTERNAL CIVIL WORKS CROSS SECTIONS - 1&2 - CHEWKO ROAD - SHEET 1 OF 6	
CHEWKO ROAD & 267 MOVER ROAD, MAREERA, OLD ON BEHALF OF TWO RIVERS COMMUNITY SCHOOL	
FOR APPROVAL	
L.U.23112-1-CD-401 A	

21/8/2025
28.2.2025

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Annotations	Date	13/05/2025

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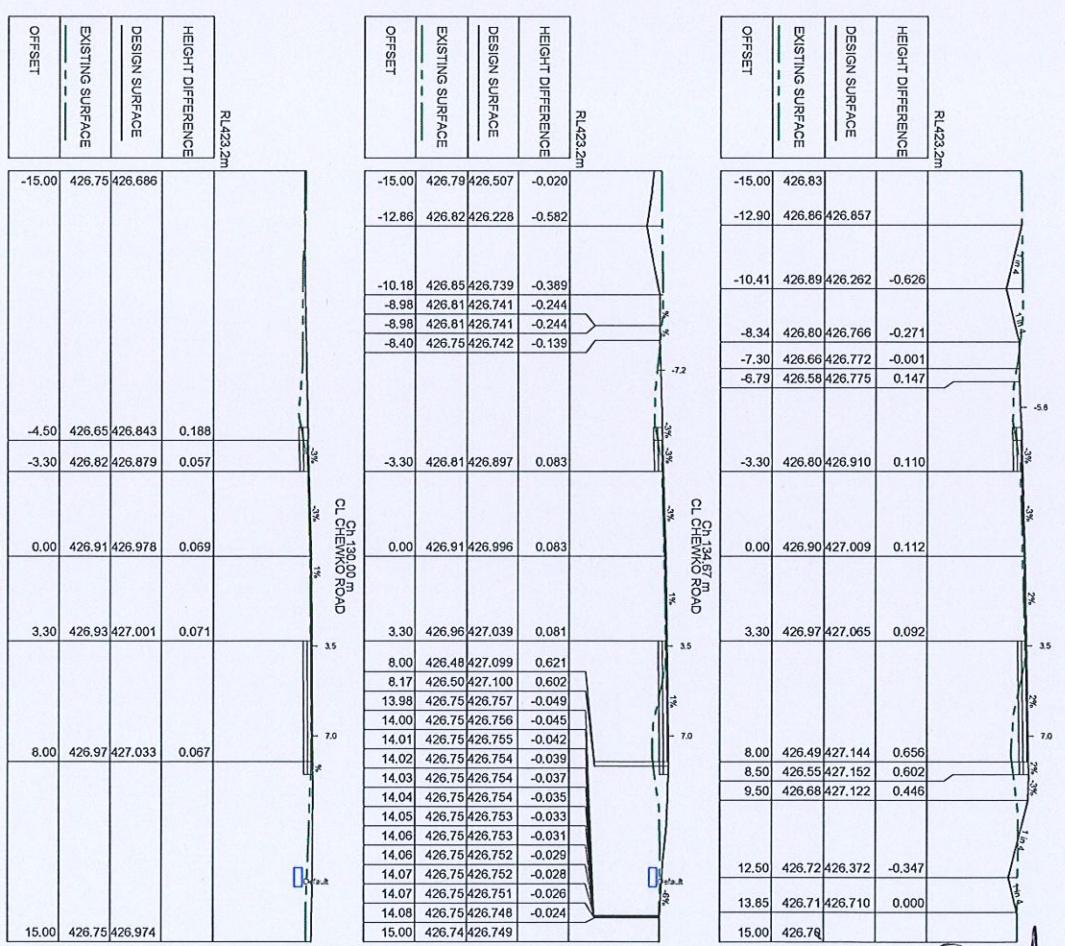
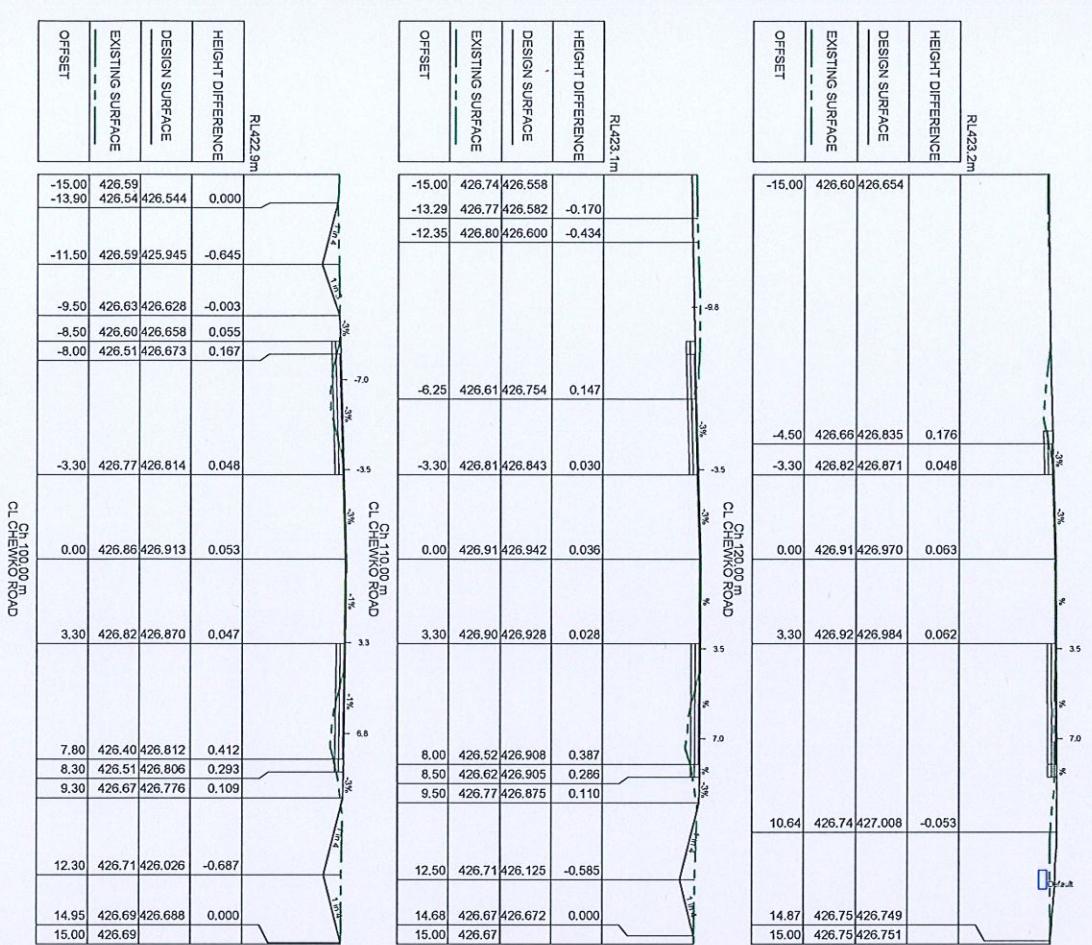
Tempor... Owner: J.L.A Date: 13/05/2025

FOR APPROVAL

LU23112-1-CD-402

Two Rivers Community School Stage 1 & 2 - External Civil Works Cross Sections - CHEWKO ROAD - SHEET 2 OF 6 CHEWKO ROAD & 267 MOVER ROAD, MARENGA, ON BEHALF OF TWO RIVERS COMMUNITY SCHOOL, DOING BUSINESS AS CHEWKO ROAD & 267 MOVER ROAD, MARENGA, Otago, New Zealand. CONSTRUCTION DRAWINGS REV. A 20/05/2025

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 4. ALL IMPROVED WORKS ARE SUBJECT TO INSPECTION, COMPLIANCE AND
 RELATED FEATURES WITHIN THE SURVEY INFORMATION PROVIDED.
 5. CONSTRUCTION OF EXISTING AND NEW ALL LOADS SERVICES
 RELATED TO EXISTING AND NEW ALL LOADS SERVICES.
 6. ALL IMPROVED WORKS ARE SUBJECT TO INSPECTION, COMPLIANCE AND
 RELATED FEATURES WITHIN THE SURVEY INFORMATION PROVIDED.
 7. REQUIREMENTS FREQUENTLY CHANGED BASED ON INFORMATION
 PROVIDED BY CLIENT.



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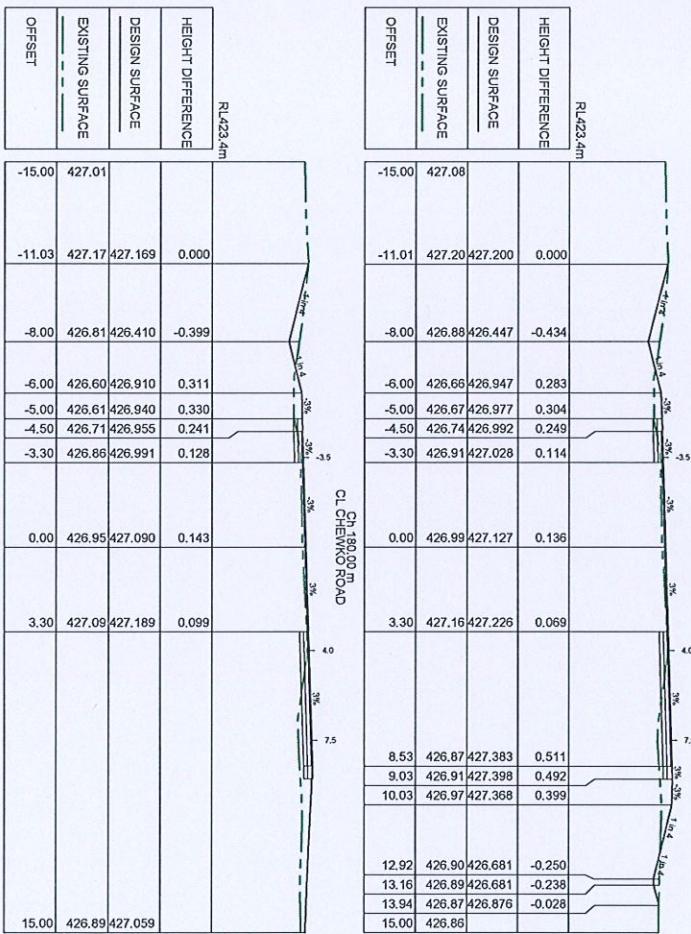
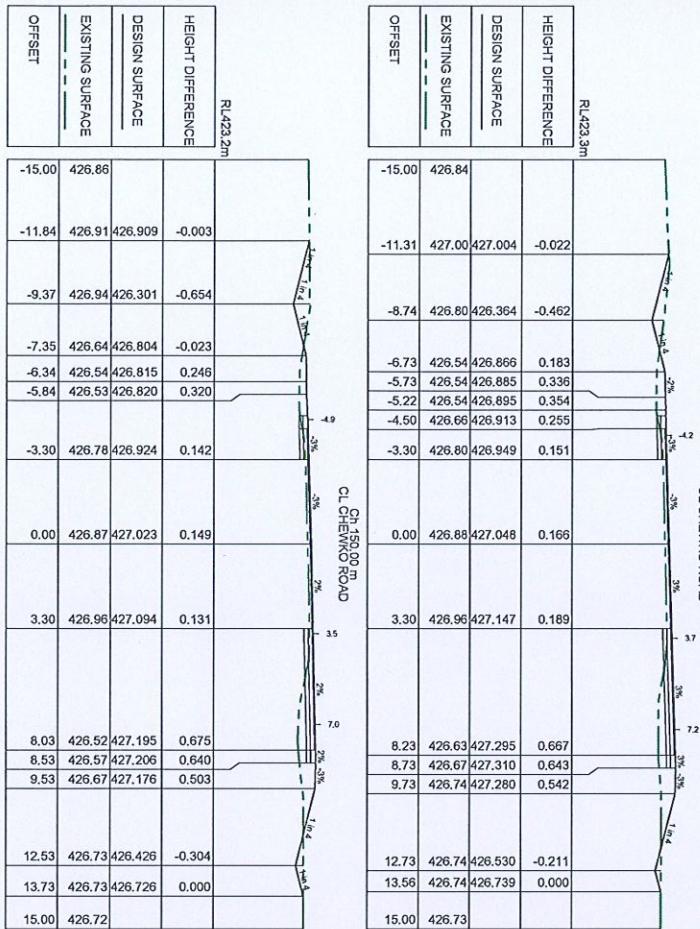
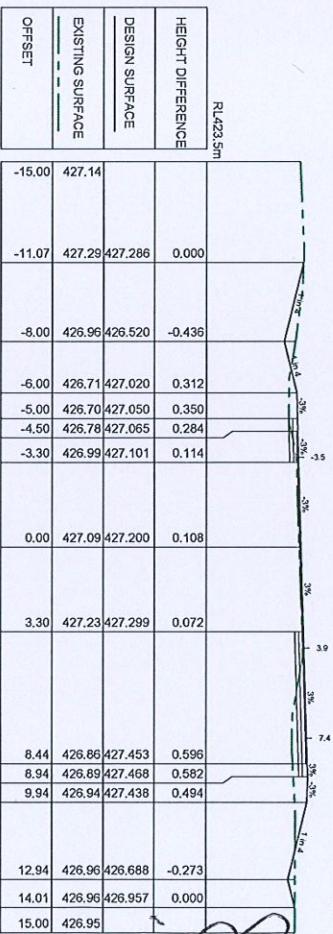
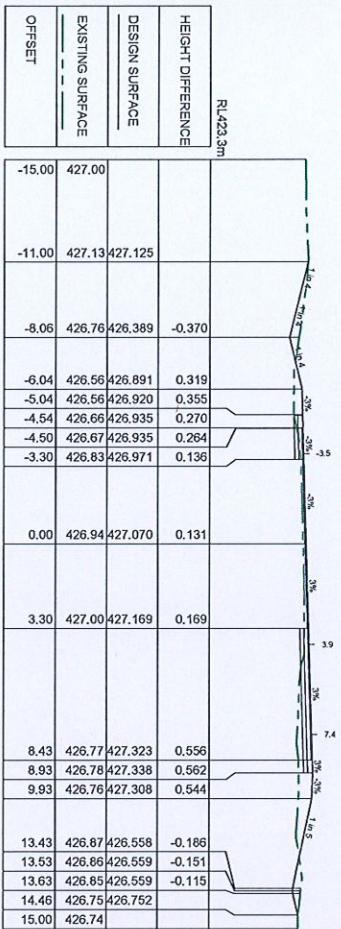
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Design: A.P.B. Checked: J.L.A. Approved: J.L.A. Date: 13/05/2025





FOR APPROVAL

LU23112-1-CD-403 A

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Annotations Approved Date







NOTE
TOP-DOWNGEAM SURVEY HAS BEEN UNDERTAKEN BY BPS ON 17TH SEPTEMBER 2011 AS THE SUBJECT SELF REFERRED TO PPS SURVEY DOCUMENTATION (ADMNISTRAITON) FOR FURTHER INFORMATION NOTE THAT THESE SURVEYS ARE CONDUCTED ON A ONE TIME BASIS.
2. DOWNTIME IS NOT INCLUDED IN THE SURVEY AND NO PAYMENT FOR DOWNTIME IS MADE.
3. CONFIRMATION OF LOCATION AND DEPTH OF ALL DUSTING REMAINERS ARE REQUIRED PRIOR TO COMMENCEMENT OF WORK.
4. ALL WORKED WORKING SUBJECT TO DUSTING AND RECOMMENDED DUSTING METHODS AND EQUIPMENT.
RECOMMENDED DUSTING METHODS AND EQUIPMENT PROVIDED BY BPS
REQUIREMENTS FEASIBILITY COMPLETED BASED ON INFORMATION PROVIDED BY CLIENT.

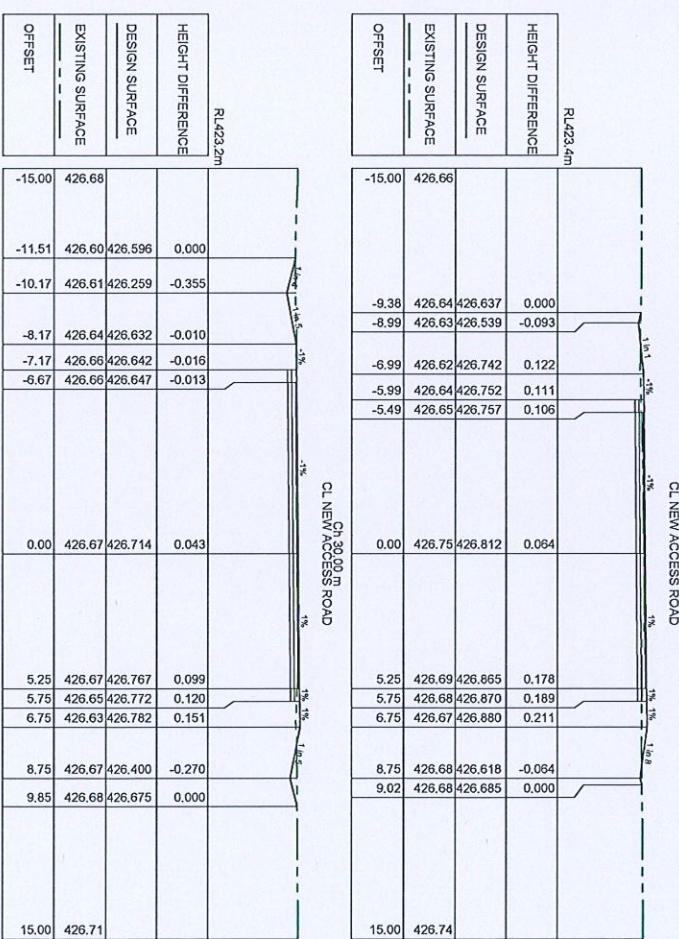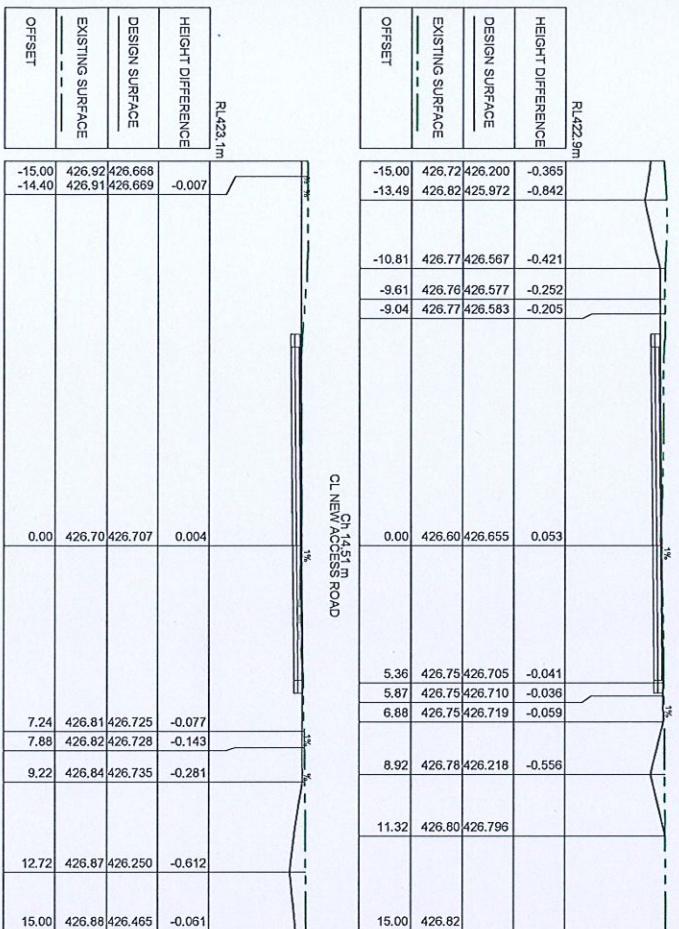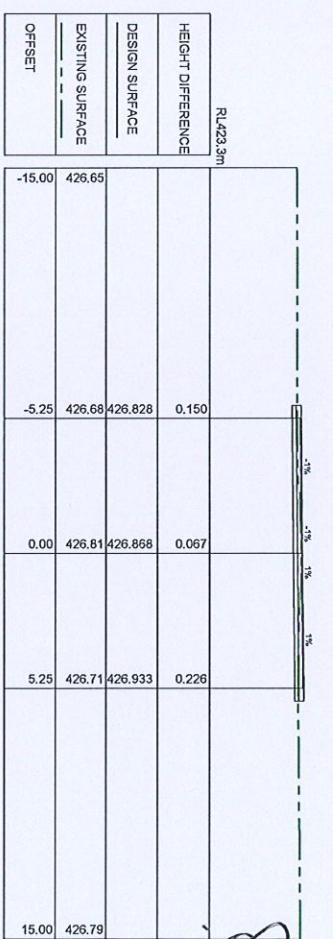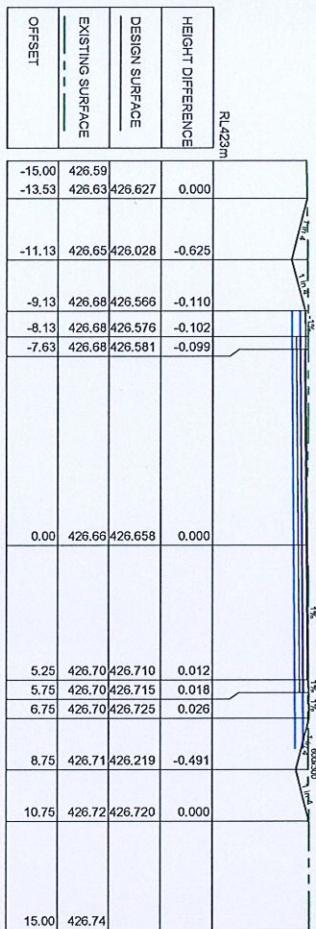

NOTE:
TOPGRAPHIC SAFETY HAS BEEN UNDERTAKEN BY REASON, LTD
SOCIETE D'INGENIERIE ET DE CONSEIL EN SURETE ET EN PROTECTION
THAT THIS SURVEY IS CLOUDED BY THE STATE OF
LACK OF TIME AND NO RESPONSIBILITY FOR THE ACCURACY OF
CONFIRMATION OF COORDINATES AND ELEVATIONS IS ASSUMED.
ALL REPORTED POINTS REFER TO THE SURVEY POINTS
PROVIDED BY CLIENT.

6.79
B.2 21/8/2025







	
Two Rivers Community School Stage 1 & 2 - External Civil Works Cross Sections - New Access Road Sheet 1 of 6 Chemwo Road & 267 River Road, Mareeba, QLD <small>On Behalf of Two Rivers Community School</small> <small>Designation Number: LU23112-1-CD-407 A</small> <small>Rev. 0</small>	
	
<p>A. 100% DESIGN ISSUE - FOR APPROVAL (Copy)</p> <p>Amendments</p>	<p>Approved</p> <p>Date: 13/05/2025</p>
<p>FOR APPROVAL</p>	

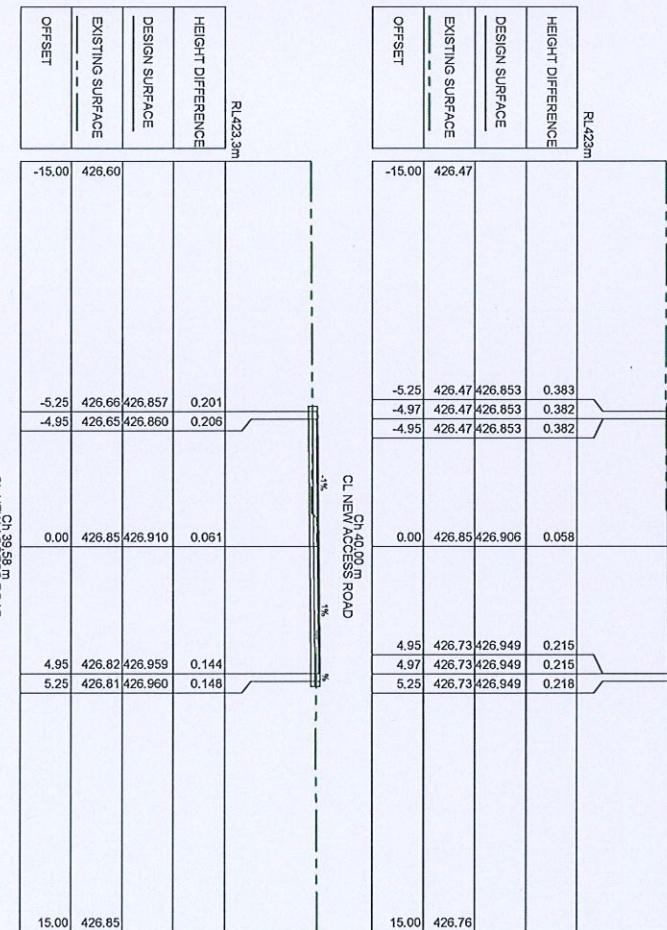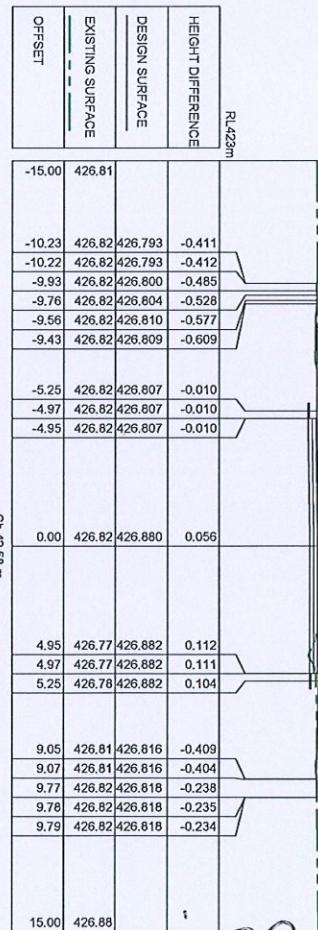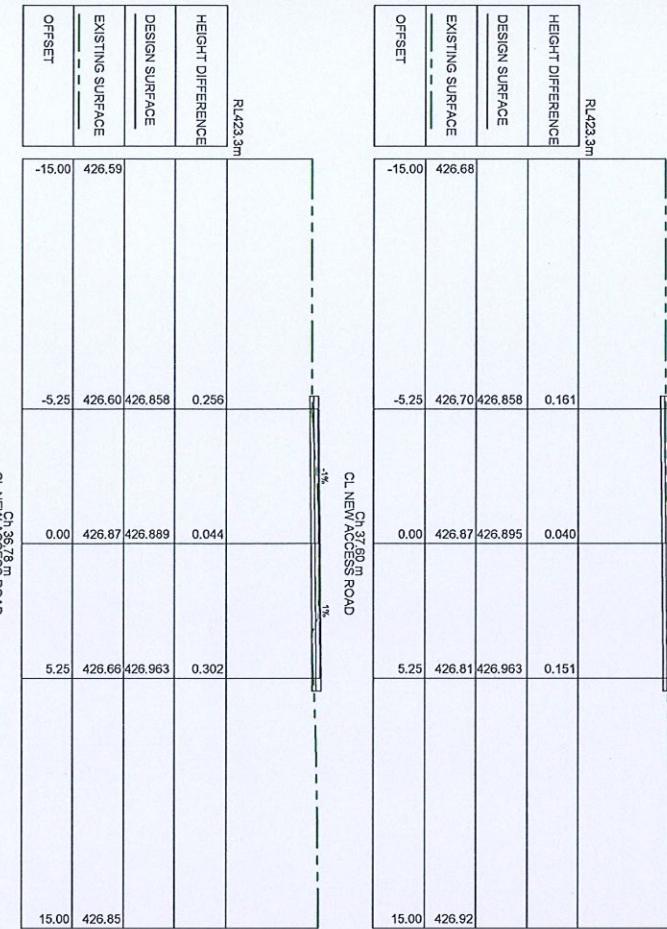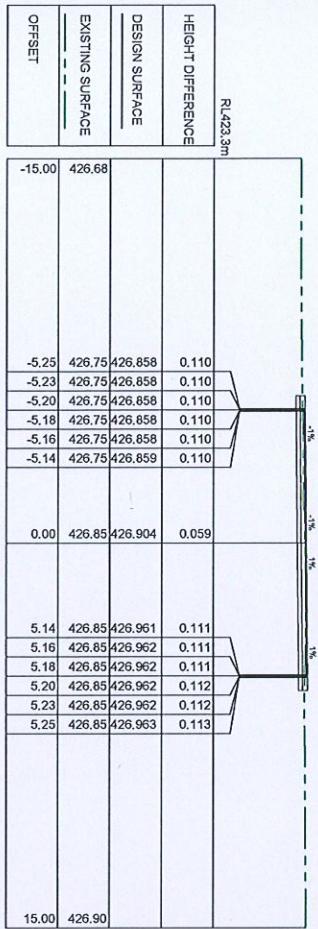

NOTE:
TOGRAPHING SURVEY HAS BEEN UNDERTAKEN IN ACCORDING ON THE DOCUMENTATION AS THE SUBJECT SITE REFERS TO SURVEY DOCUMENTATION AS THE SUBJECT SITE REFERS TO SURVEY INFORMATION. NOTWITHSTANDING THE ABOVE, THE SURVEY INFORMATION PROVIDED IS NOT INTENDED FOR USE AS A DESIGN BASIS FOR ANY PROJECT. IT IS THE RESPONSIBILITY OF THE SURVEYOR TO DETERMINE THE SUITABILITY OF THE SURVEY INFORMATION PROVIDED.
1. THIS SURVEY WAS CONDUCTED IN ACCORDANCE WITH THE STANDARDS OF
2. SURVEYING AS SET OUT IN THE CANADIAN NATIONAL SURVEYING
3. DOCUMENTATION AS THE SUBJECT SITE REFERS TO SURVEY INFORMATION. NOTWITHSTANDING THE ABOVE, THE SURVEY INFORMATION PROVIDED IS NOT INTENDED FOR USE AS A DESIGN BASIS FOR ANY PROJECT. IT IS THE RESPONSIBILITY OF THE SURVEYOR TO DETERMINE THE SUITABILITY OF THE SURVEY INFORMATION PROVIDED.
4. ALL INFORMATION PROVIDED IS SUBJECT TO CHANGE AND
REQUIREMENTS FOR FURTHER INFORMATION AS APPROPRIATE,
PROVIDED BY CLIENT.

NOTE
 1. SUBMISSIONS AND DRAWINGS HAVE BEEN UNQUOTEED AS THE SUBJECT SITE REFERRED TO IN THIS
 DOCUMENTATION. NOTWITHSTANDING, FOR FURTHER INFORMATION, PLEASE CONTACT THE LEADER URBAN TEAM.
 2. LONGER SURVEY LINE OR SURVEY POINTS ARE PROVIDED AS A REFERENCE POINT.
 3. EXISTING FEATURES WHICH THE SURVEY INFORMATION REFERS TO.
 4. CONSTRUCTION OF ALL WORKS IS SUBJECT TO APPROVAL BY LEADER URBAN SERVICES.
 ALL PROPOSED WORKS ARE SUBJECT TO APPROVAL BY LEADER URBAN SERVICES.
 RELEASES AND PAYMENTS ARE MADE ON APPROVAL OF THE CONTRACTORS.
 REQUIREMENTS FOR SUBMISSIONS AND APPROVALS ARE PROVIDED BY LEADER URBAN SERVICES.
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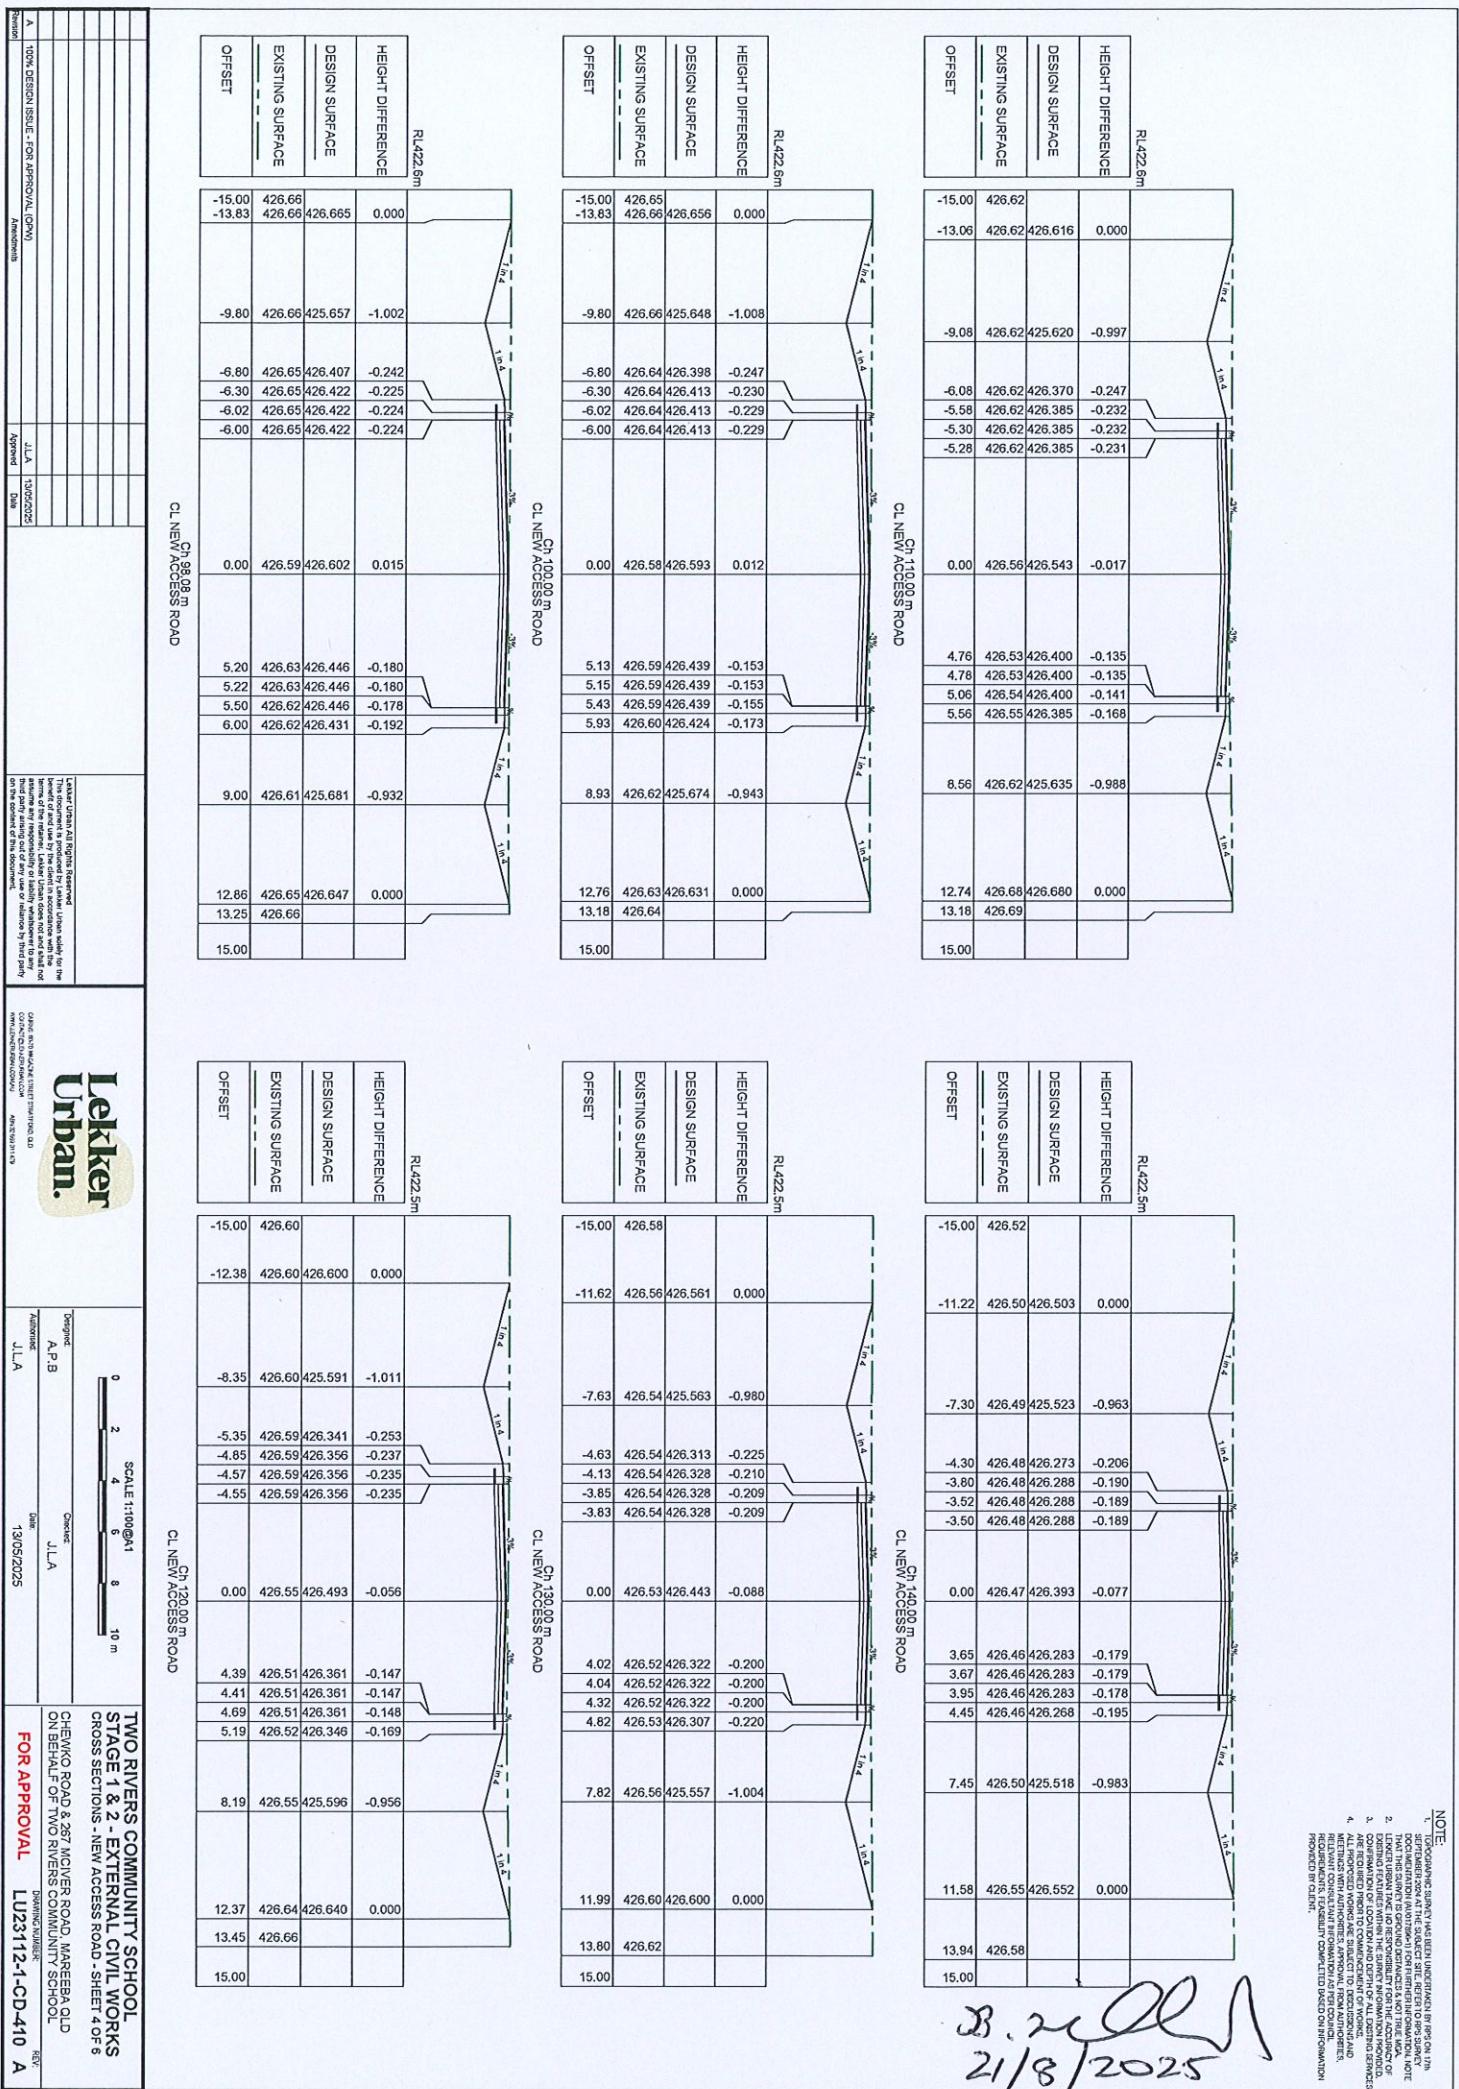
CL NEW ACCESS ROAD					
A	100% DESIGN ISSUE - FOR APPROVAL ONLY				
Revised					
	Approved	Date			

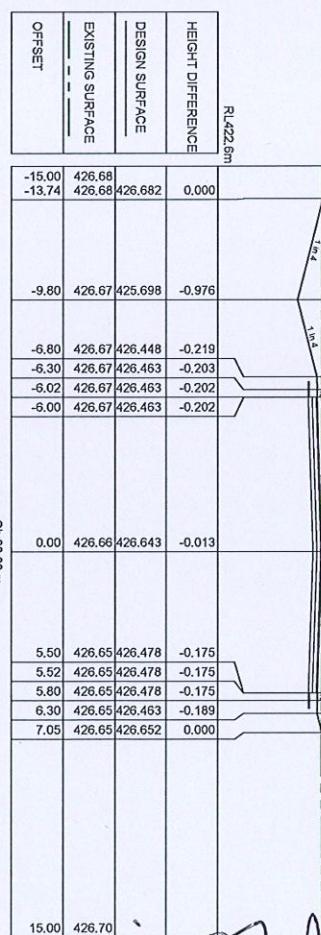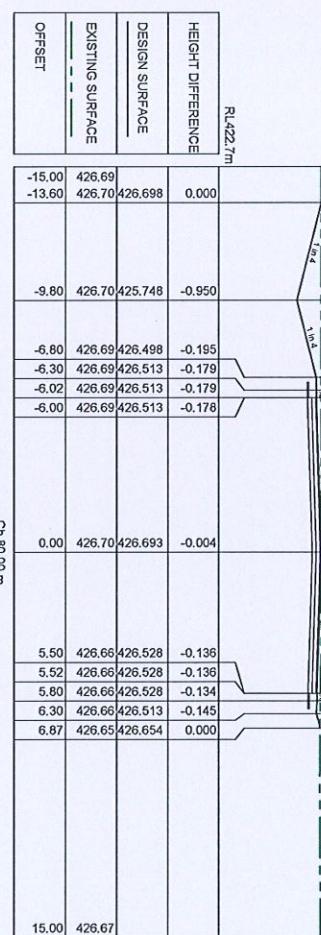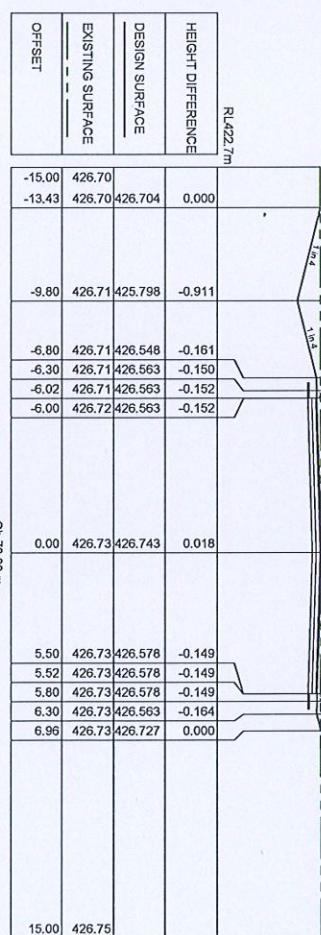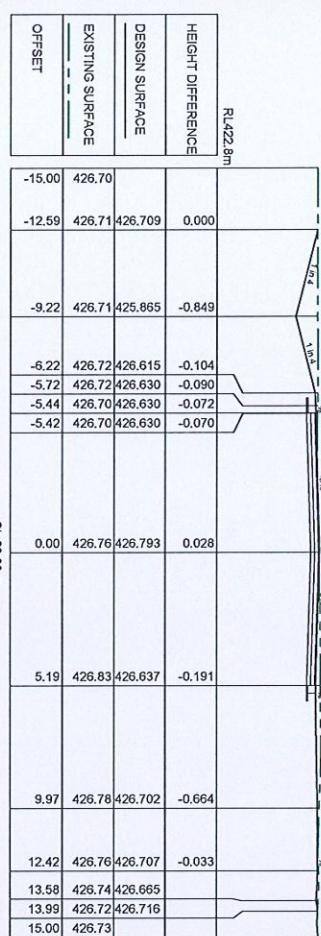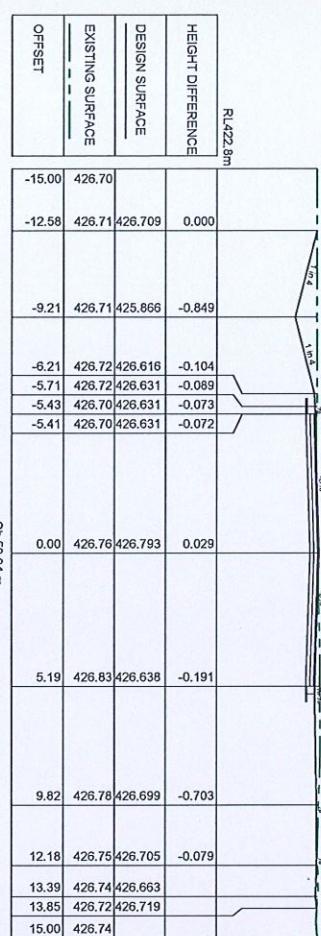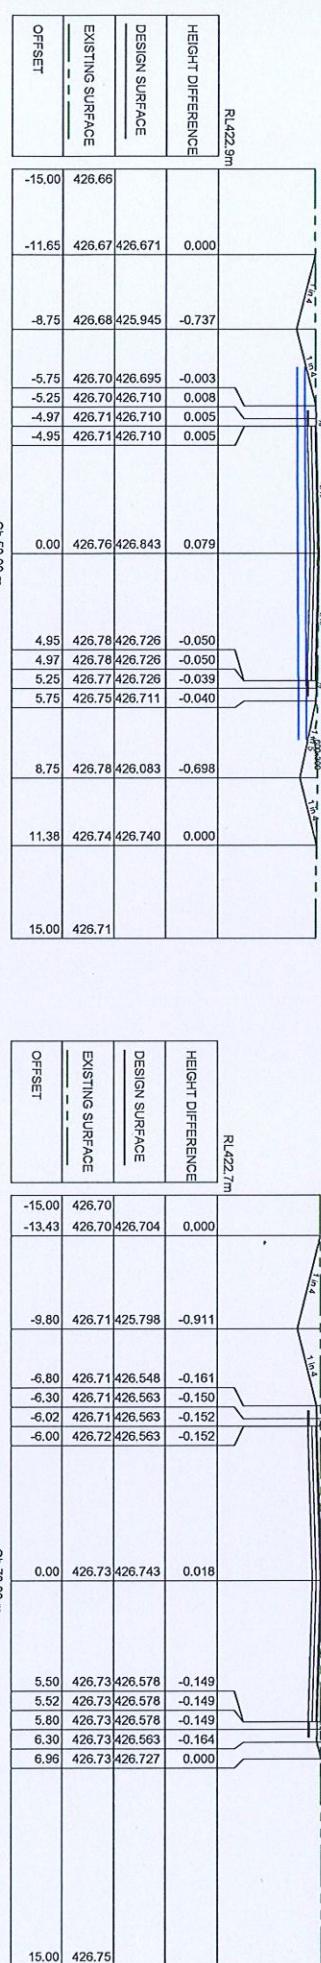

TWO RIVERS COMMUNITY SCHOOL
STAGE 1 & 2 - EXTERNAL CIVIL WORKS
CROSS SECTIONS - NEW ACCESS ROAD - SHEET 5 OF 6
CHEWKO ROAD & 267 MCNIVEN ROAD, MAREEBA QLD
ON BEHALF OF TWO RIVERS COMMUNITY SCHOOL
FOR APPROVAL
LU23112-1-CD-409 A







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NOTE:
 1. THIS DOCUMENT CONTAINS SURVEY INFORMATION FOR THE PURPOSE OF DOCUMENTATION AND CHECKS. IT IS NOT A RECORD OF SURVEY WORK.
 2. THAT THE SURVEY OF EARTHWORKS AND SURFACE FEATURES IS NOT A THOROUGH CHECK OF
 3. DIMENSIONS AND SURFACE FEATURES.
 4. CONFIRMATION OF LOCATION AND DEPTH OF ALL DUGGING PITS AND
 5. DUGOUTS MADE WITHIN THE SURVEY INFORMATION PROVIDED.
 6. ALL PROPOSED WORKS ARE SUBJECT TO DESIGNERS AND
 7. METERS WITH AUTHORITY, APPROVAL FROM AUTHORITIES,
 8. REQUIREMENTS MADE BY PLANNING AUTHORITIES AND
 9. REQUIREMENTS MADE BY CONTRACTORS.

CL NEW ACCESS ROAD Ch 1500.00m			
Lekker Urban.			
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Revised	Amendments	Approved	Date



TWO RIVERS COMMUNITY SCHOOL STAGE 1 & 2 - EXTERNAL WORKS CROSS SECTIONS - NEW ACCESS ROAD - SHEET 5 OF 6

CHEMWO ROAD & 267 MONTE ROAD, MARIBA QLD ON BEHALF OF TWO RIVERS COMMUNITY SCHOOL

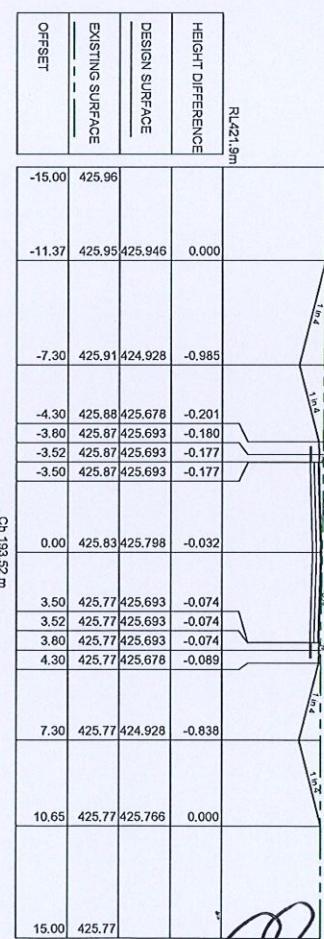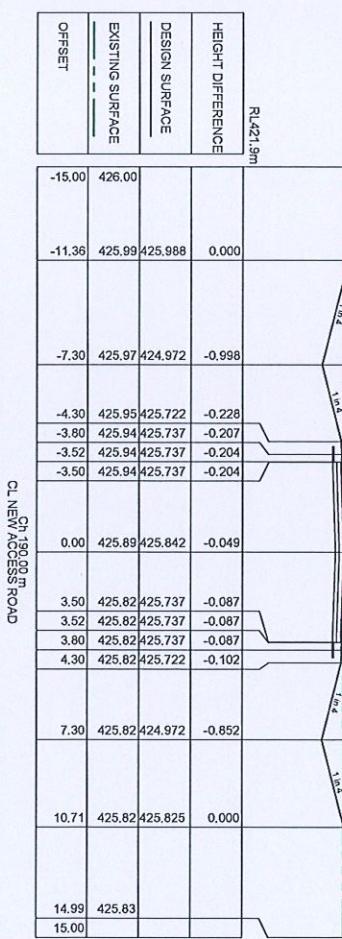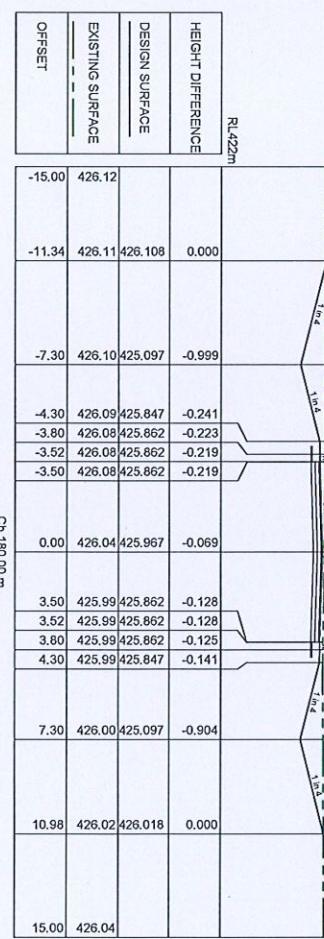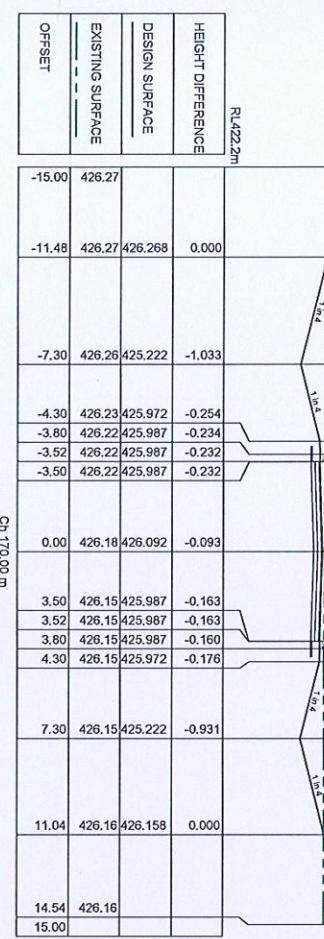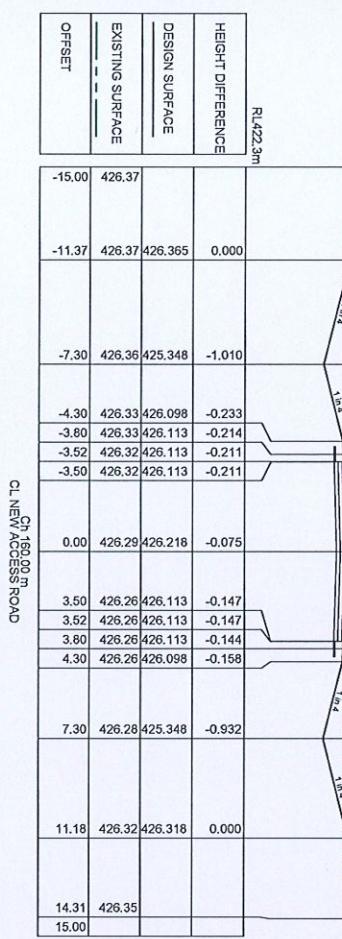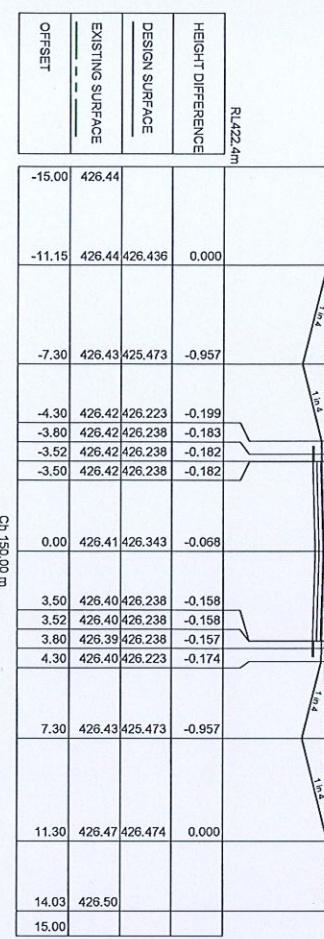OPERATING COMPANY: Lekker Urban Pty Ltd


CONTRACTOR: CHEMWO CONSTRUCTION PTY LTD


APPROVAL: J.L.A.

Date: 13/05/2025

FOR APPROVAL

L.U23-112-1-CD-411 A

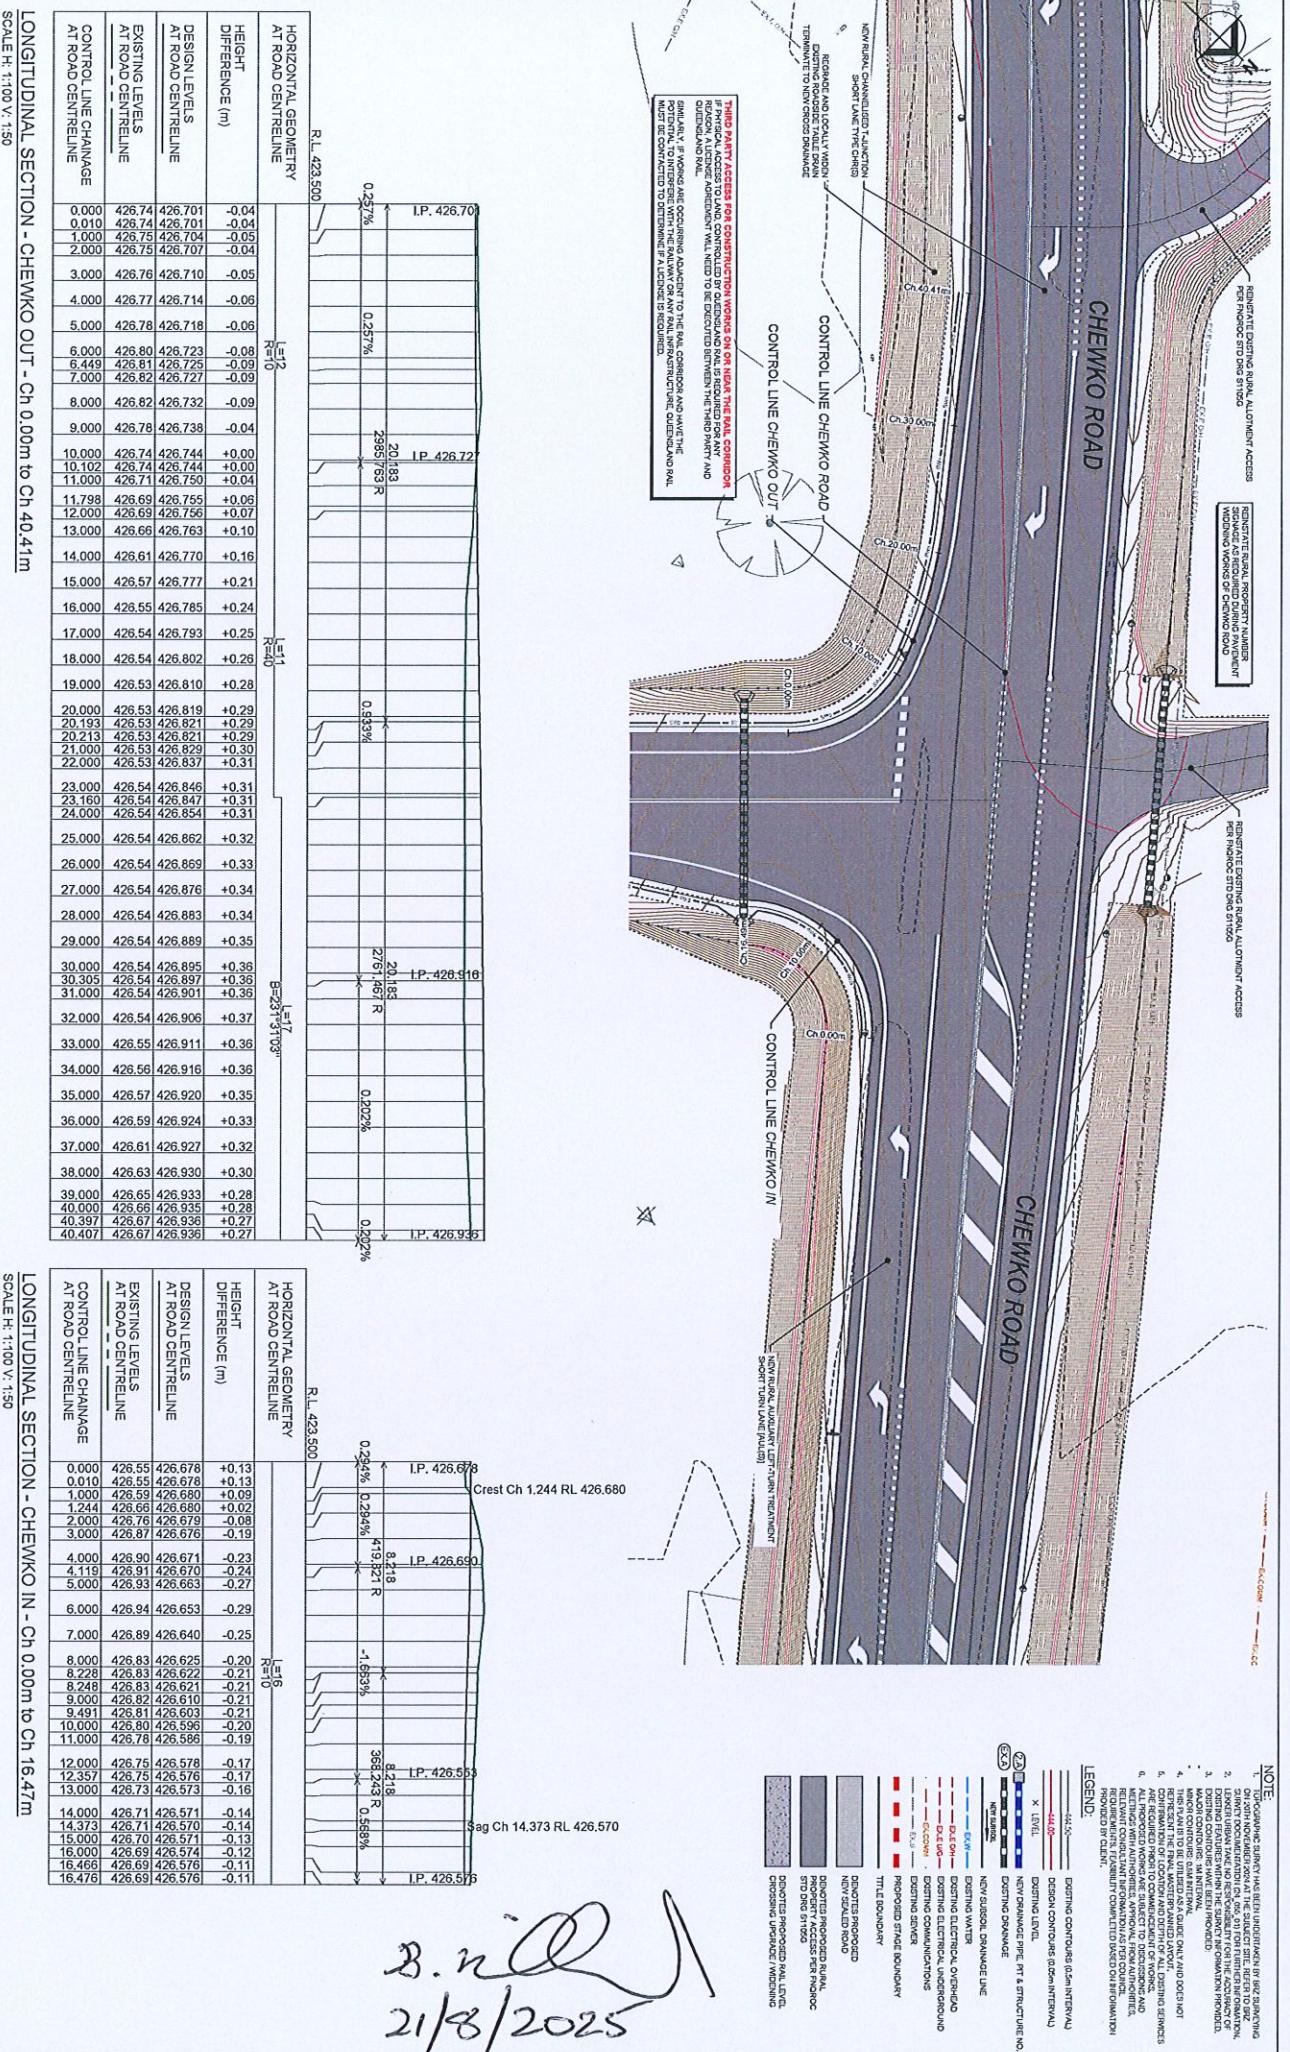

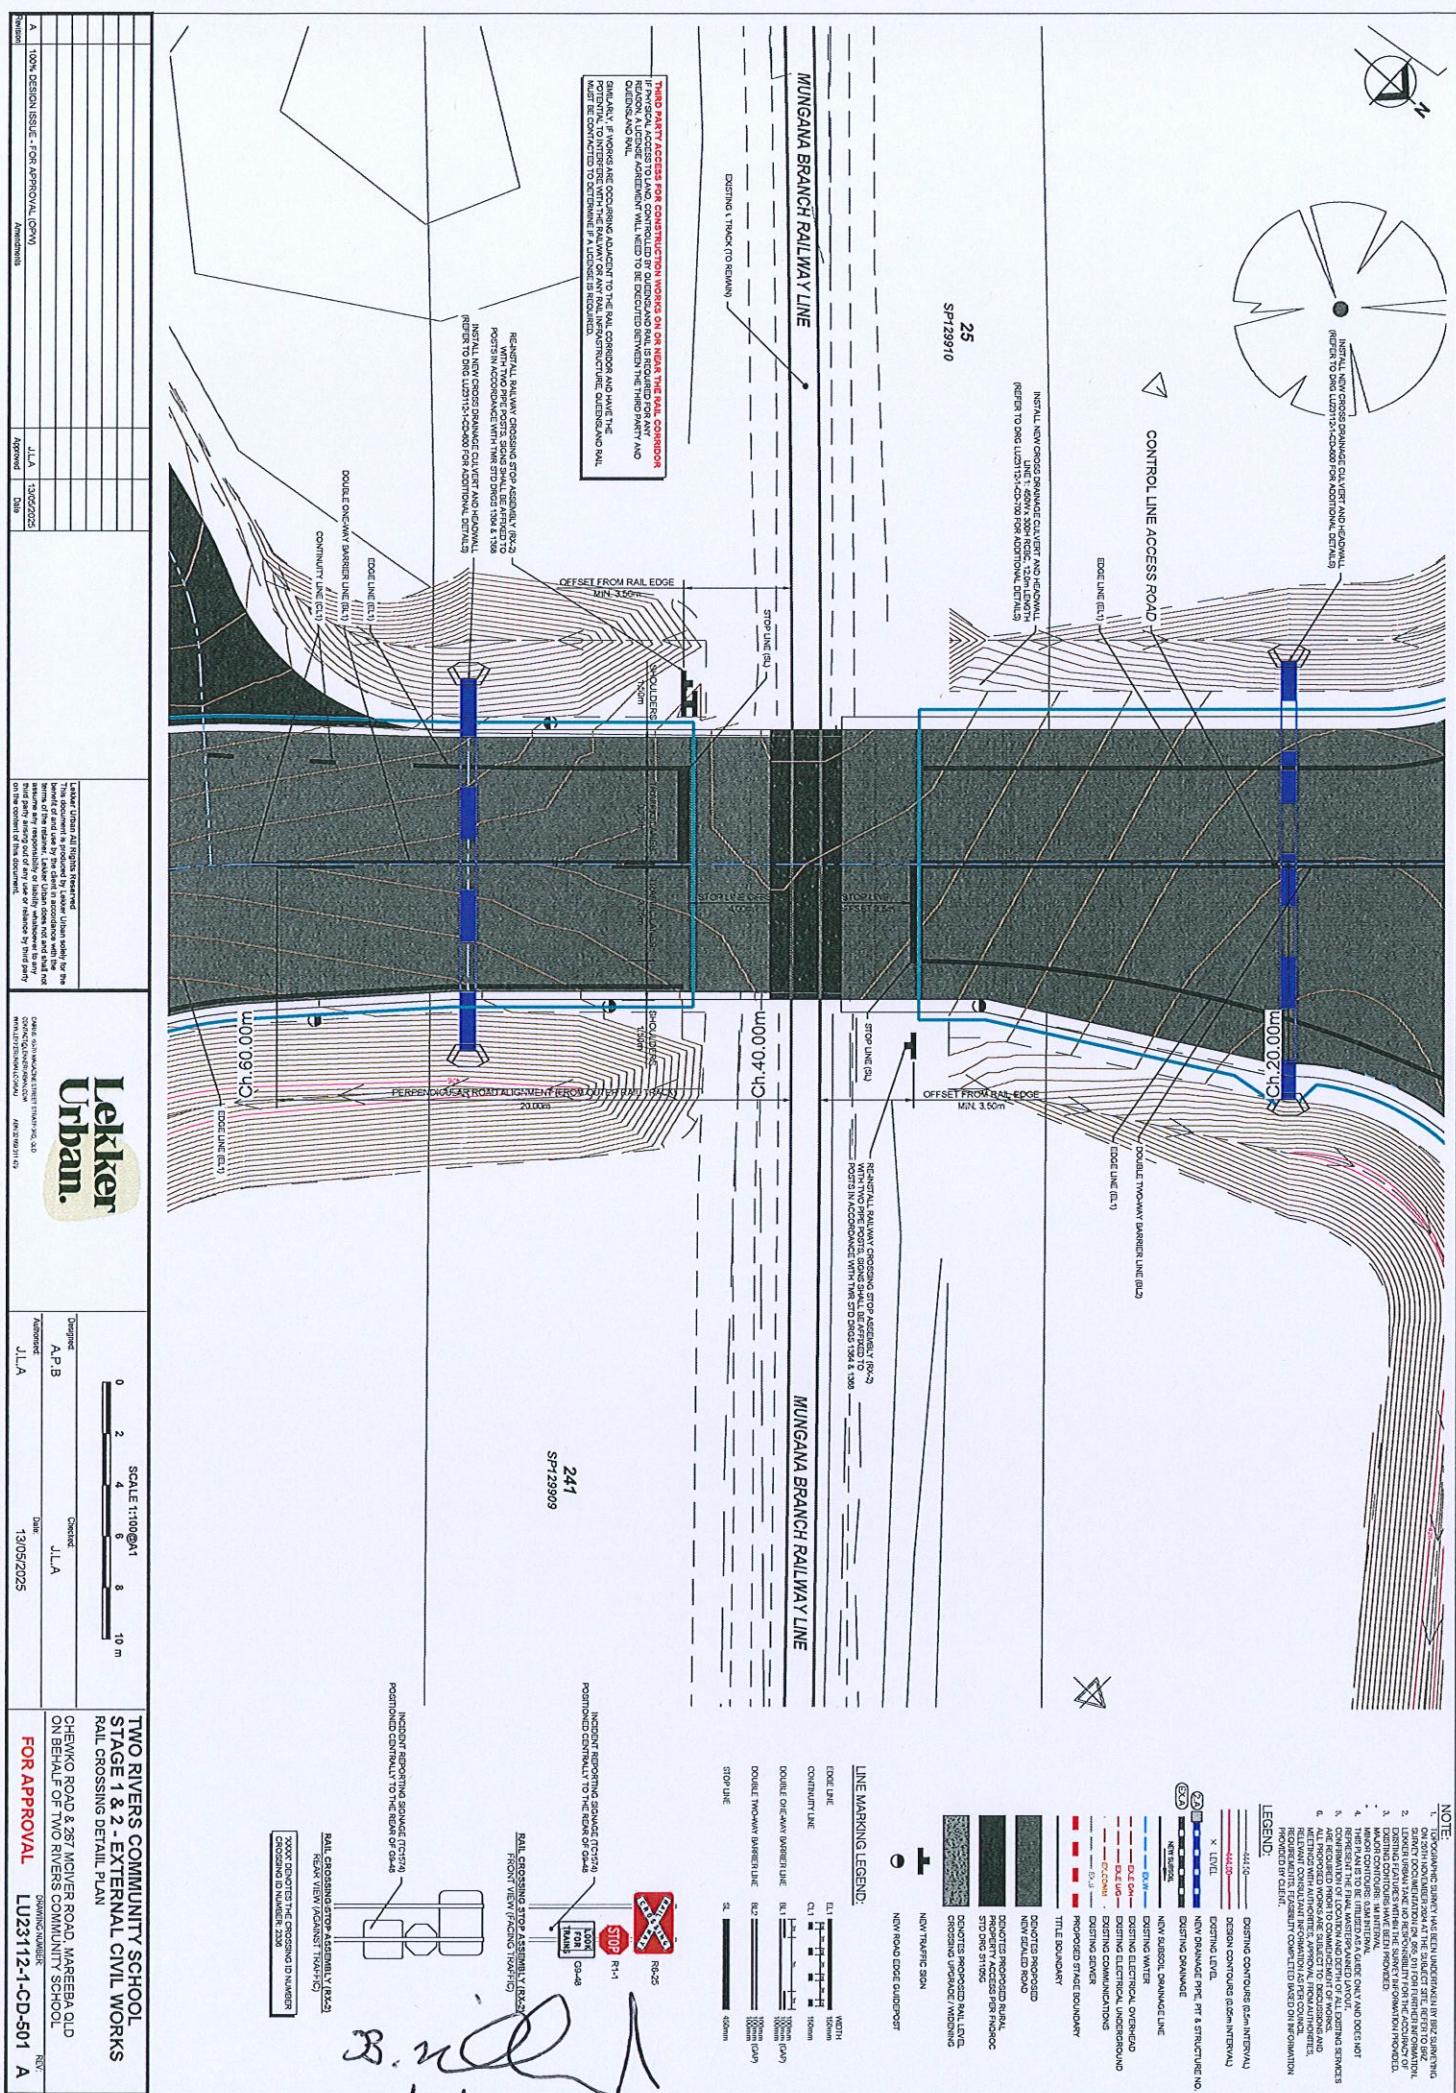

A. 100% DESIGN ISSUE FOR APPROVAL (PDM) Reviewed	J.L.A. Approved Date
B. 100% DESIGN ISSUE FOR APPROVAL (PDM) Reviewed	J.L.A. Approved Date

LINE LOT 1

SCALES H:1:250 V:1:50

PIPE DETAILS	SLOPE/GRADE	DATUM RL	INVERT LEVEL	DESIGN SURFACE
HGL (10% AEP)	1.30:0.0	426.590	0.500	426.590
DEPTH TO INVERT			0.500	
DESIGN SURFACE				426.844
EXISTING SURFACE				426.742
CHANGAGE			0.000	18.000

LINE LOT 2

SCALES H:1:250 V:1:50

LINE 1

SCALES H:1:250 V:1:50

LINE 3

SCALES H:1:250 V:1:50

LINE 2






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LINE OT 1

SCALES H:1:250 V:1:50

LINE OT 2

SCALES H:1:250 V:1:50

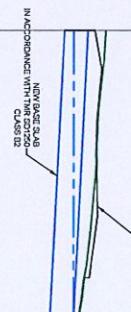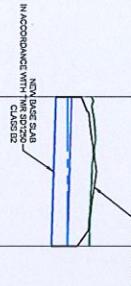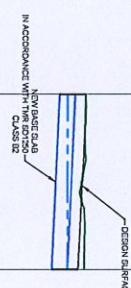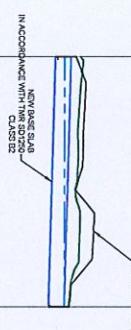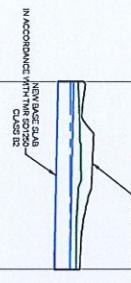

TWO STAGE 1 & 2 - EXTERNAL CIVIL WORKS

DRAINAGE LONGITUDINAL SECTIONS

CHEWKO ROAD & 207 MOWER ROAD, MARREBA QLD

ON BEHALF OF TWO RIVERS COMMUNITY SCHOOL

DRAWING NUMBER:

REV:

A

H: 0	5	10	15	20	25 m
V: 0	1	2	3	4	5 m
0.000	426.737	426.538	426.036	426.269	17.050
0.000	426.737	426.538	426.036	426.269	14.050
0.000	426.699	426.459	426.049	426.269	11.050
0.000	426.699	426.459	426.049	426.269	8.050
0.000	426.699	426.459	426.049	426.269	5.050
0.000	426.699	426.459	426.049	426.269	2.050
0.000	426.699	426.459	426.049	426.269	0.050

TWO STAGE 1 & 2 - EXTERNAL CIVIL WORKS

DRAINAGE LONGITUDINAL SECTIONS

CHEWKO ROAD & 207 MOWER ROAD, MARREBA QLD

ON BEHALF OF TWO RIVERS COMMUNITY SCHOOL

DRAWING NUMBER:

REV:

A

H: 0	5	10	15	20	25 m
V: 0	1	2	3	4	5 m
0.000	425.533	425.221	424.721	424.637	11.050
0.000	425.533	425.221	424.721	424.637	8.050
0.000	425.533	425.221	424.721	424.637	5.050
0.000	425.533	425.221	424.721	424.637	2.050
0.000	425.533	425.221	424.721	424.637	0.050

TWO STAGE 1 & 2 - EXTERNAL CIVIL WORKS

DRAINAGE LONGITUDINAL SECTIONS

CHEWKO ROAD & 207 MOWER ROAD, MARREBA QLD

ON BEHALF OF TWO RIVERS COMMUNITY SCHOOL

DRAWING NUMBER:

REV:

A


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0.000	424.938	424.433	424.036	423.269	2.050
0.000	424.938	424.433	424.036	423.269	0.050

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21/8/2025

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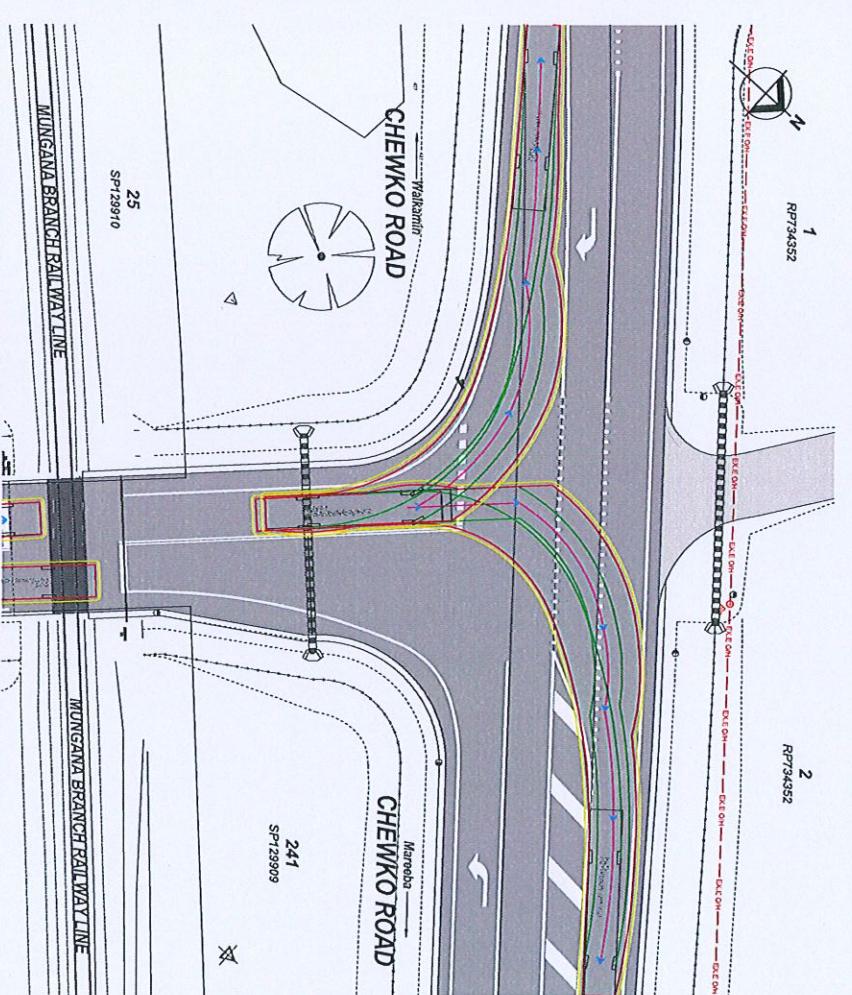
Approved J.L.A. Approved Date 13/05/2025

FOR APPROVAL LU23/112-1-CD-600 A

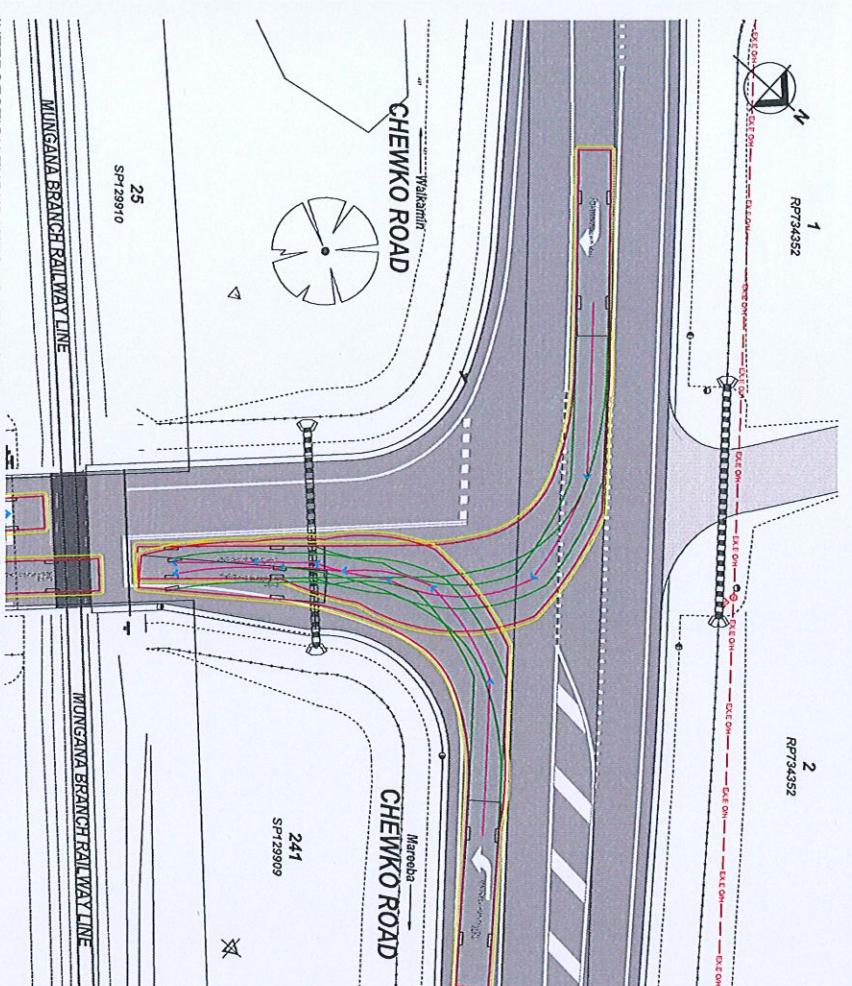


INTERSECTION TURNPATHS - CHEWKO & NEW ACCESS ROAD: DESIGN VEHICLE (INBOUND)

SCALE 1:200
INTERSECTION TURNPATHS - CHEWKO & NEW ACCESS ROAD: DESIGN VEHICLE (OUTBOUND)



INTERSECTION TURNPATHS - CHEWKO & NEW ACCESS ROAD: DESIGN VEHICLE (INBOUND)

SCALE 1:200
INTERSECTION TURNPATHS - CHEWKO & NEW ACCESS ROAD: DESIGN VEHICLE (OUTBOUND)

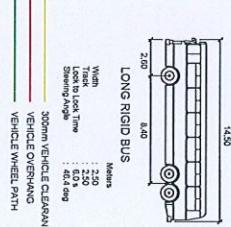

DESIGN VEHICLE - 14.5m LONG RIGID BUS



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Lekker Urban.

*B. n
21/8/2025*


TWO RIVERS COMMUNITY SCHOOL
STAGE 1 & 2 - EXTERNAL CIVIL WORKS
VEHICLE TURN MOVEMENT LAYOUT PLAN - SHEET 1 OF 2
CHEWKO ROAD & 27 MOYER ROAD, MAREBBA QLD
ON BEHALF OF TWO RIVERS COMMUNITY SCHOOL
DRAWING NUMBER: LU23112-1-CD-800 REV A
CONTRACTOR: TURF CONSTRUCTION QD
DATE DRAWN: 13/05/2025
FOR APPROVAL

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Printed:	Approved Date

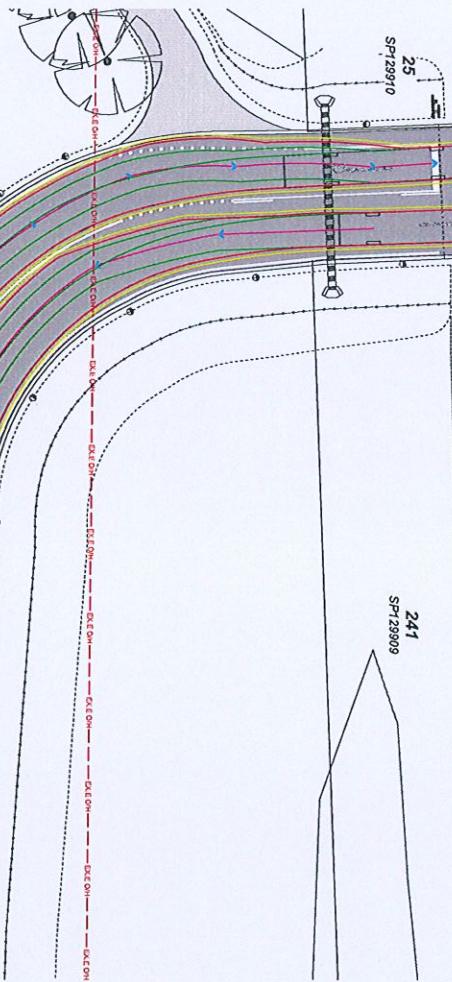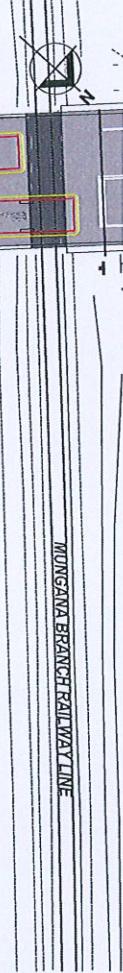

INTERSECTION TURNPATHS - NEW ACCESS ROAD: DESIGN VEHICLE (INBOUND)

SCALE 1:200

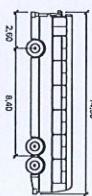

LONG RIGID BUS
Width : 2.60 Meters
Length : 8.60 Meters
Height : 1.65 Meters
Shoeing Angle : 40.4 deg
300mm VEHICLE CLEARANCE
VEHICLE OVERHANG
VEHICLE WHEEL PATH

DESIGN VEHICLE - 14.5m LONG RIGID BUS

N.T.S.

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A	100% DESIGN ISSUE - FOR APPROVAL (OPEN)
Reference	J.L.A
Comments	Approved
Date	10/02/2025

TWO RIVERS COMMUNITY SCHOOL
STAGE 1 & 2 - EXTERNAL CIVIL WORKS
VEHICLE TURN MOVEMENT LAYOUT PLAN-SHEET 2 OF 2
CHIENKO ROAD & 267 MCLEVER ROAD, MARIBA QLD
ON BEHALF OF TWO RIVERS COMMUNITY SCHOOL
DRAWING NUMBER: LU23112-1-CD-3017 A
REV: 0
DATE: 13/05/2025
FOR APPROVAL

0 4 SCALE 1:200 @ A1 8 12 16 20 m
Tentative Drawing
A.P.B J.L.A
Approved Date: 13/05/2025


B. will
21/8/2025

ON BEHALF OF TWO RIVERS COMMUNITY SCHOOL
STAGE 1 & 2 - INTERNAL CIVIL WORKS
CHEWKO ROAD & 267 MCIVER ROAD, MAREEBA QLD
(INTERNAL SITE WORKS)

(INTERNAL SITE WORKS)

CIVIL ENGINEERING DRAWING LIST

DRAWING NUMBER	SHEET TITLE
CD-100	COVER SHEET, LOCALITY & DRAWING SCHEDULES
CD-101	CONSTRUCTION NOTES
CD-102	CONCEPT EROSION & SEDIMENT CONTROL NOTES
CD-103	OVERALL GENERAL ARRANGEMENT LAYOUT PLAN
CD-201	CONCEPT EROSION & SEDIMENT CONTROL LAYOUT PLAN
CD-202	CLEARING & DEMOLITION LAYOUT PLAN
CD-203	BULK EARTHWORKS LAYOUT PLAN
CD-204	CIVIL SITE WORKS LAYOUT PLAN
CD-300	ROAD LONGITUDINAL SECTIONS
CD-301	ROAD LONGITUDINAL SECTIONS
CD-302	ROAD LONGITUDINAL SECTIONS
CD-400	ROAD CROSS SECTIONS
CD-401	ROAD CROSS SECTIONS
CD-402	ROAD CROSS SECTIONS
CD-403	ROAD CROSS SECTIONS
CD-404	ROAD CROSS SECTIONS
CD-405	ROAD CROSS SECTIONS
CD-406	ROAD CROSS SECTIONS
CD-407	ROAD CROSS SECTIONS
CD-408	ROAD CROSS SECTIONS
CD-409	ROAD CROSS SECTIONS
CD-410	ROAD CROSS SECTIONS
CD-500	ROAD CROSS SECTIONS
CD-501	DETAIL LAYOUT PLAN
CD-502	DETAIL LAYOUT PLAN
CD-503	DETAIL LAYOUT PLAN
CD-500	STORMWATER CATCHMENT LAYOUT PLAN
CD-601	DRAINAGE LONGITUDINAL SECTIONS
CD-602	DRAINAGE LONGITUDINAL SECTIONS
CD-603	DRAINAGE PIPE SCHEDULES & SETOUT
CD-604	DETAIL LAYOUT PLAN & SECTIONS
CD-605	DETAIL LAYOUT PLAN & SECTIONS
CD-700	TYPICAL CONSTRUCTION DETAILS
CD-701	TYPICAL CONSTRUCTION DETAILS

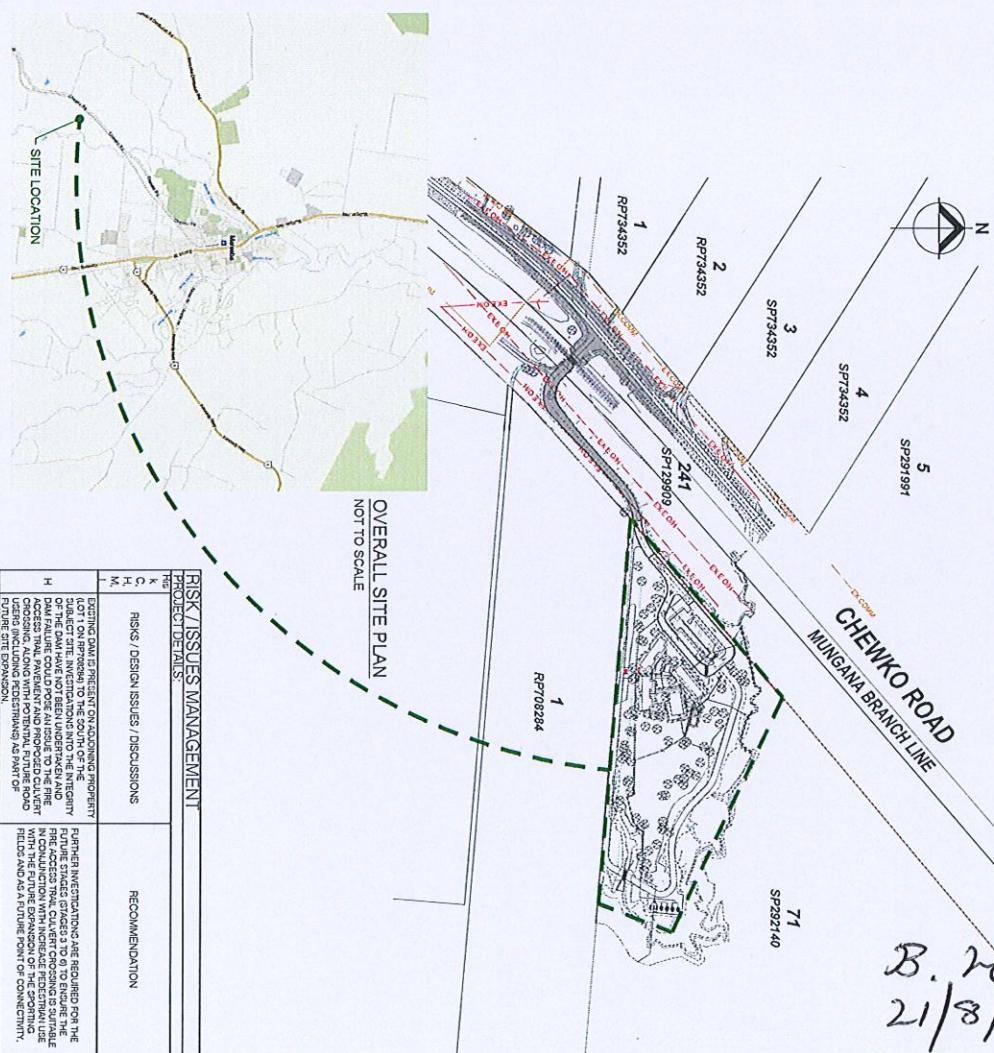

B. will
21/8/2025

PRESENT ON ADDING PROPERTY TO THE COURT OF THE INTEGRITY NOT TO HAVE BEEN MADE BY THE PERSONS WHO PROPOSED AND PROPOSED THE PROJECT, WITH PERTINENT PROBLEMS AS PART OF THE PROJECT.	RECOMMENDATION
REGULAR = High, MEDIUM = Medium, LOW = Low	

**TWO RIVERS COMMUNITY SCHOOL
STAGE 1 & 2 - INTERNAL CIVIL WORKS
COVERING 1 OCTOBER 2019 DRAFT SCHEDULES**

		DRAWING NOT TO SCALE	
		Designing A.P.B	Circled J.L.A
		Date 28/04/2025	
		FOR APPROVAL	
		REV. A LU23112-CD-100 A	
		TWO RIVERS COMMUNITY SCHOOL STAGE 1 & 2 - INTERNAL CIVIL WORKS COVER SHEET, LOCALITY & DRAWING SCHEDULES	
		CHEVICK ROAD & 257 MCIVER ROAD MAREEKA OLD ON BEHALF OF TWO RIVERS COMMUNITY SCHOOL	
		DRAWING NUMBER	
		REV. A LU23112-CD-100 A	
		Lekker Urban.	
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		LEKKER URBAN CONSULTANT ENGINEERS LTD 100% DESIGN ISSUE - FOR APPROVAL Architects Architect Approved Approved Date	

EROSION AND SEDIMENT CONTROL PLANS

PROGRESSIVE EROSION AND SEDIMENT CONTROL PLANS (ESCPs) SHALL BE DEVELOPED AND IMPLEMENTED AS MEASURES.

1. MINIMISE EXTENT AND DURATION OF DISTURBANCE

1.1. WHERE POSSIBLE, WORKS TO BE MANAGED SUCH THAT AREAS OUTSIDE SCOPE OF WORKS REMAIN UNDISTURBED

1.2. MINIMISE EXTENT OF DISTURBANCE WITHIN CONSTRUCTION SITE AT ANY ONE TIME BY STAGING THE WORKS (E.G. RIP EXISTING BURNS IN SECTIONS, WORK ON NEW SECTIONS FOLLOWING COMPLETION OF PREVIOUS STAGED)

1.3. MINIMISE DISTURBANCE OF VEGETATION ALONG THE ROAD VERGE WITH SPECIAL EMPHASIS ON MANAGEMENT OF CONSTRUCTION ACTIVITIES ADJACENT TO WATERCOURSES (E.G. MAINTAIN GRASSY BUFFER WHERE POSSIBLE).

2. CONTROL STORMWATER FLOWS ONTO, THROUGH AND FROM THE SITE

2.1. SEPARATE CLEAN RUNOFF FROM CONTAMINATED (E.G. DUSTY CONSTRUCTION AREA) RUNOFF (MAINTAIN CLEAN

2.2. CONSTRUCT PERMANENT DRAINAGE STRUCTURES EARLY IN THE PROJECT INCLUDING:

2.2.1. KERB ON DOWN SLOPE SIDE OF ROAD

2.2.2. CULVERTS, HEDGEROWS AND ASSOCIATED INLET AND OUTLET PROTECTION (E.G. DISPLANTERS)

2.2.3. MAXIMISE THE SHEET FLOW OF TURBID CONSTRUCTION RUNOFF AND DUSTING SPOT DRAIN (ON UP-SLOPE SIDE OF ROAD) BY MASTICATING SOIL DRAINAGE WHERE POSSIBLE, OR DIVERT INTO NEW CUTTERS AS CONSTRUCTED.

3. USE EROSION CONTROL MEASURES TO PREVENT ON-SITE DAMAGE

3.1. THE INSTALLATION OF ALL EROSION AND SEDIMENT CONTROLS TO OCCUR IMMEDIATELY POST CLEARING AND STRIPPING.

3.2. SITE ROCKFOLIES OF SOIL MATERIAL IN LOW-HAZARD AREAS AHEAD OF WATERCOURSES; ADDITIONAL PROTECTION TO BE AFFORDED WITH A TEMPORARY REVEGETATION DIVERSION BANK AND SEDIMENT CONTROL, IF REQUIRED.

3.3. CONSTRUCT DRAINS WITH PERMEABLE GROUT, WHERE THE DRAINS ARE NOT SHALLOWER THAN 150MM.

3.4. INCREASE THE EFFECTIVENESS AND EFFICIENCY OF SEDIMENT CONTROLS IN THE LOWER AREAS.

4. USE SEDIMENT CONTROL MEASURES TO PREVENT OFF-SITE DAMAGE

4.1. THE INSTALLATION OF ALL EROSION AND SEDIMENT CONTROLS TO OCCUR IMMEDIATELY POST CLEARING AND STRIPPING.

4.2. CONSTRUCT CONTROL MEASURES AS CLOSE TO THE POTENTIAL SOURCE OF SEDIMENT AS POSSIBLE.

4.3. CONTROL THE POSITION OF SOIL AND SEDIMENT MATERIAL ON LOCAL ROADS.

5. STABILISE DISTURBED AREAS QUICKLY

5.1. ALL BATTER STABILISATION AND SEDIMENTATION BARRIERS, DIVERSION DRAINS, SEDIMENT TRAPS, ETC.

5.2. ALL DISTURBED VERGES AND TILL BATTERIES TO BE STABILISED BY REVETTING WITH APPROPRIATE SPECIES (CO-ANNUAL GRASSSES SUCH AS ANNUAL PIGGRASS OR JAPANESE MILLET), OR TURF, AS SOON AS PRACTICAL AFTER INSTRUMENTATION.

5.3. ERUPTIVE SITES TO BE STABILISED BY CO-ANNUAL PIGGRASS OR JAPANESE MILLET, OR TURF, AS SOON AS PRACTICAL.

5.4. ENSURE THE SUCCESS OF THE LATERAL ReforeSTATION PROGRAM BY UTILISING A GOOD TOPSOIL MANAGEMENT PROGRAM.

5.5. CONTROL DUST THROUGH PROGRESSIVE REVETIGATION TECHNIQUES, WATER TANKERS ETC.

6. INSPECT AND MAINTAIN CONTROL MEASURES

6.1. ENSURE THE PROGRESSIVE AND CONTINUOUS IMPLEMENTATION AND MAINTENANCE OF TEMPORARY EROSION AND SEDIMENT CONTROL (E.G. SEDIMENT FENCES, DIVERSION BANKS, DIVERSION TRAPS, SEDIMENT TRAPS, ETC.)

6.2. ALL DISTURBED ROADS, DRIVES, CYCLING TRAILS, ETC. TO BE STABILISED BY CO-ANNUAL PIGGRASS OR JAPANESE MILLET, OR TURF, AS SOON AS PRACTICAL.

6.3. ARRANGE REGULAR INSPECTIONS BY AN ENVIRONMENTAL SCIENTIST TO REVIEW AND UPDATE CONTROL MEASURES.

6.4. ALL EROSION AND SEDIMENT CONTROLS TO BE MAINTAINED IN PLACE UNTIL ALL WORKS ARE COMPLETED AND DISTURBED AREAS HAVE STABILISED.

EXTRACT FROM LANDCOM (2004) MANAGING URBAN STORMWATER, SOIL AND CONSTRUCTION VOLUME 2D MAIN ROADS

CONSTRUCTION ZONE
THIS SEDIMENT AND EROSION CONTROL PLAN CONTAINS FOCUSED MINIMUM REQUIREMENTS FOR ENVIRONMENTAL PROTECTION. HOWEVER, IT IS STILL THE PRINCIPAL CONTRACTORS RESPONSIBILITY TO ENSURE THAT THE WORKS AND MITIGATION STRATEGIES ARE PERFORMED IN A MANNER THAT COMPLIES WITH ALL RELEVANT ENVIRONMENTAL LEGISLATION, INCLUDING ANY DEVELOPMENT APPROVAL REQUIREMENTS.

7.1. EROSION AND SEDIMENT CONTROL COMMENTARY

7.1.1. ON-BUILD EROSION & SEDIMENT CONTROL (ESCP) MEASURES

7.1.1.1. ON-BUILD EROSION & SEDIMENT CONTROL (ESCP) MEASURES

7.1.1.2. ON-BUILD EROSION & SEDIMENT CONTROL (ESCP) MEASURES

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SP291997

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CHEWKO ROAD

MUNGANA BRANCH RAILWAY LINE


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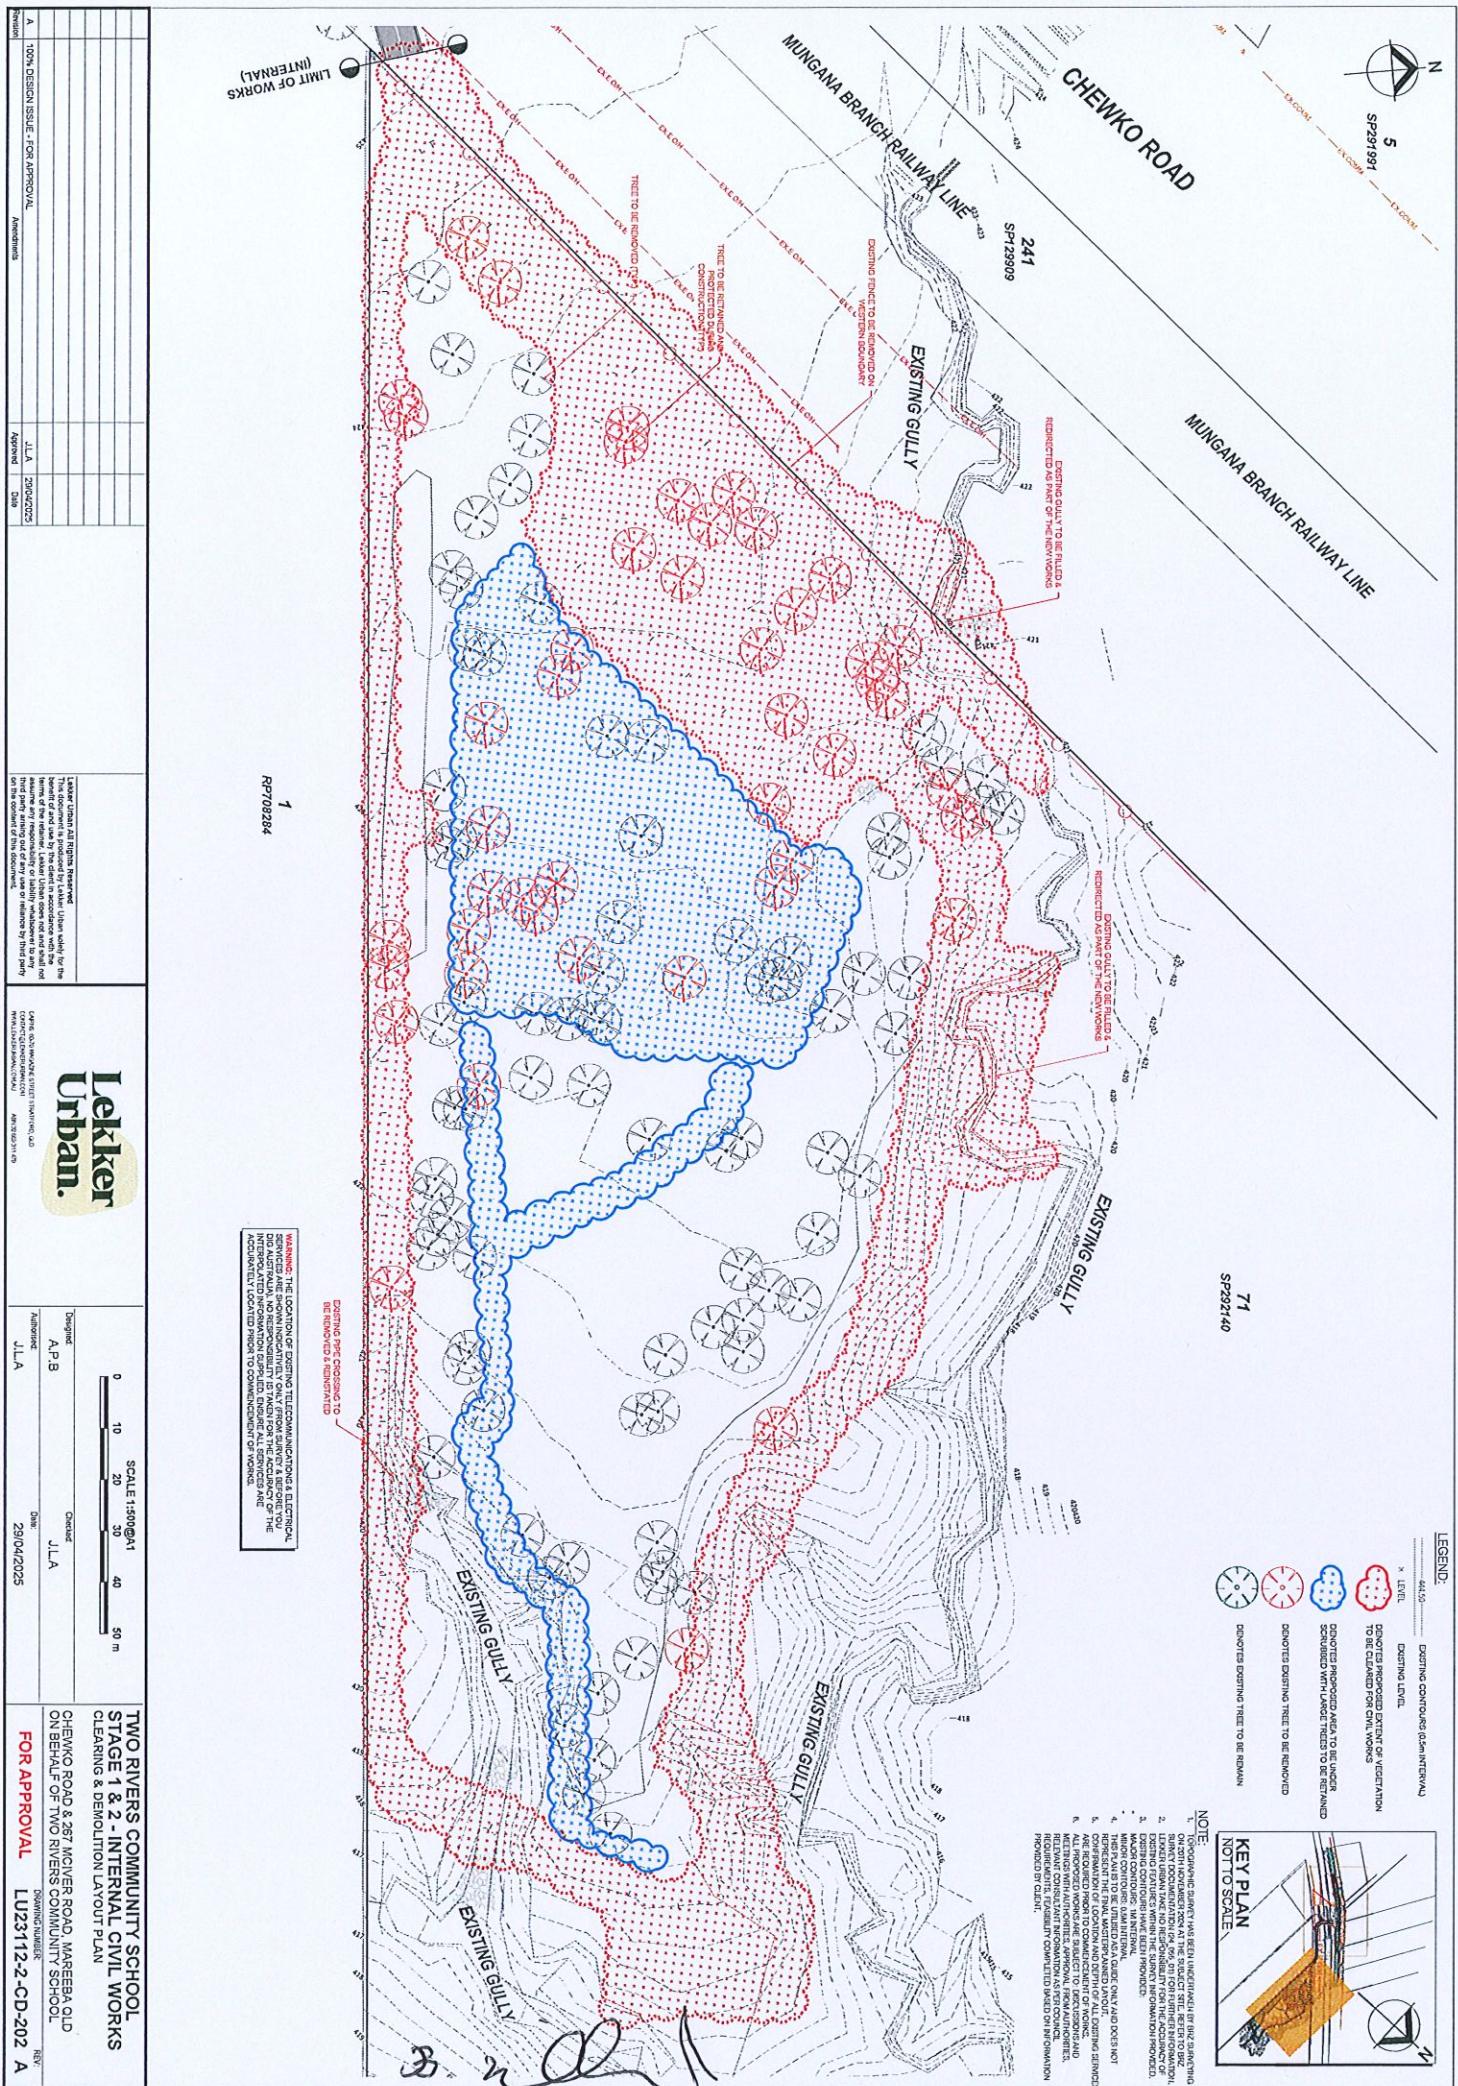
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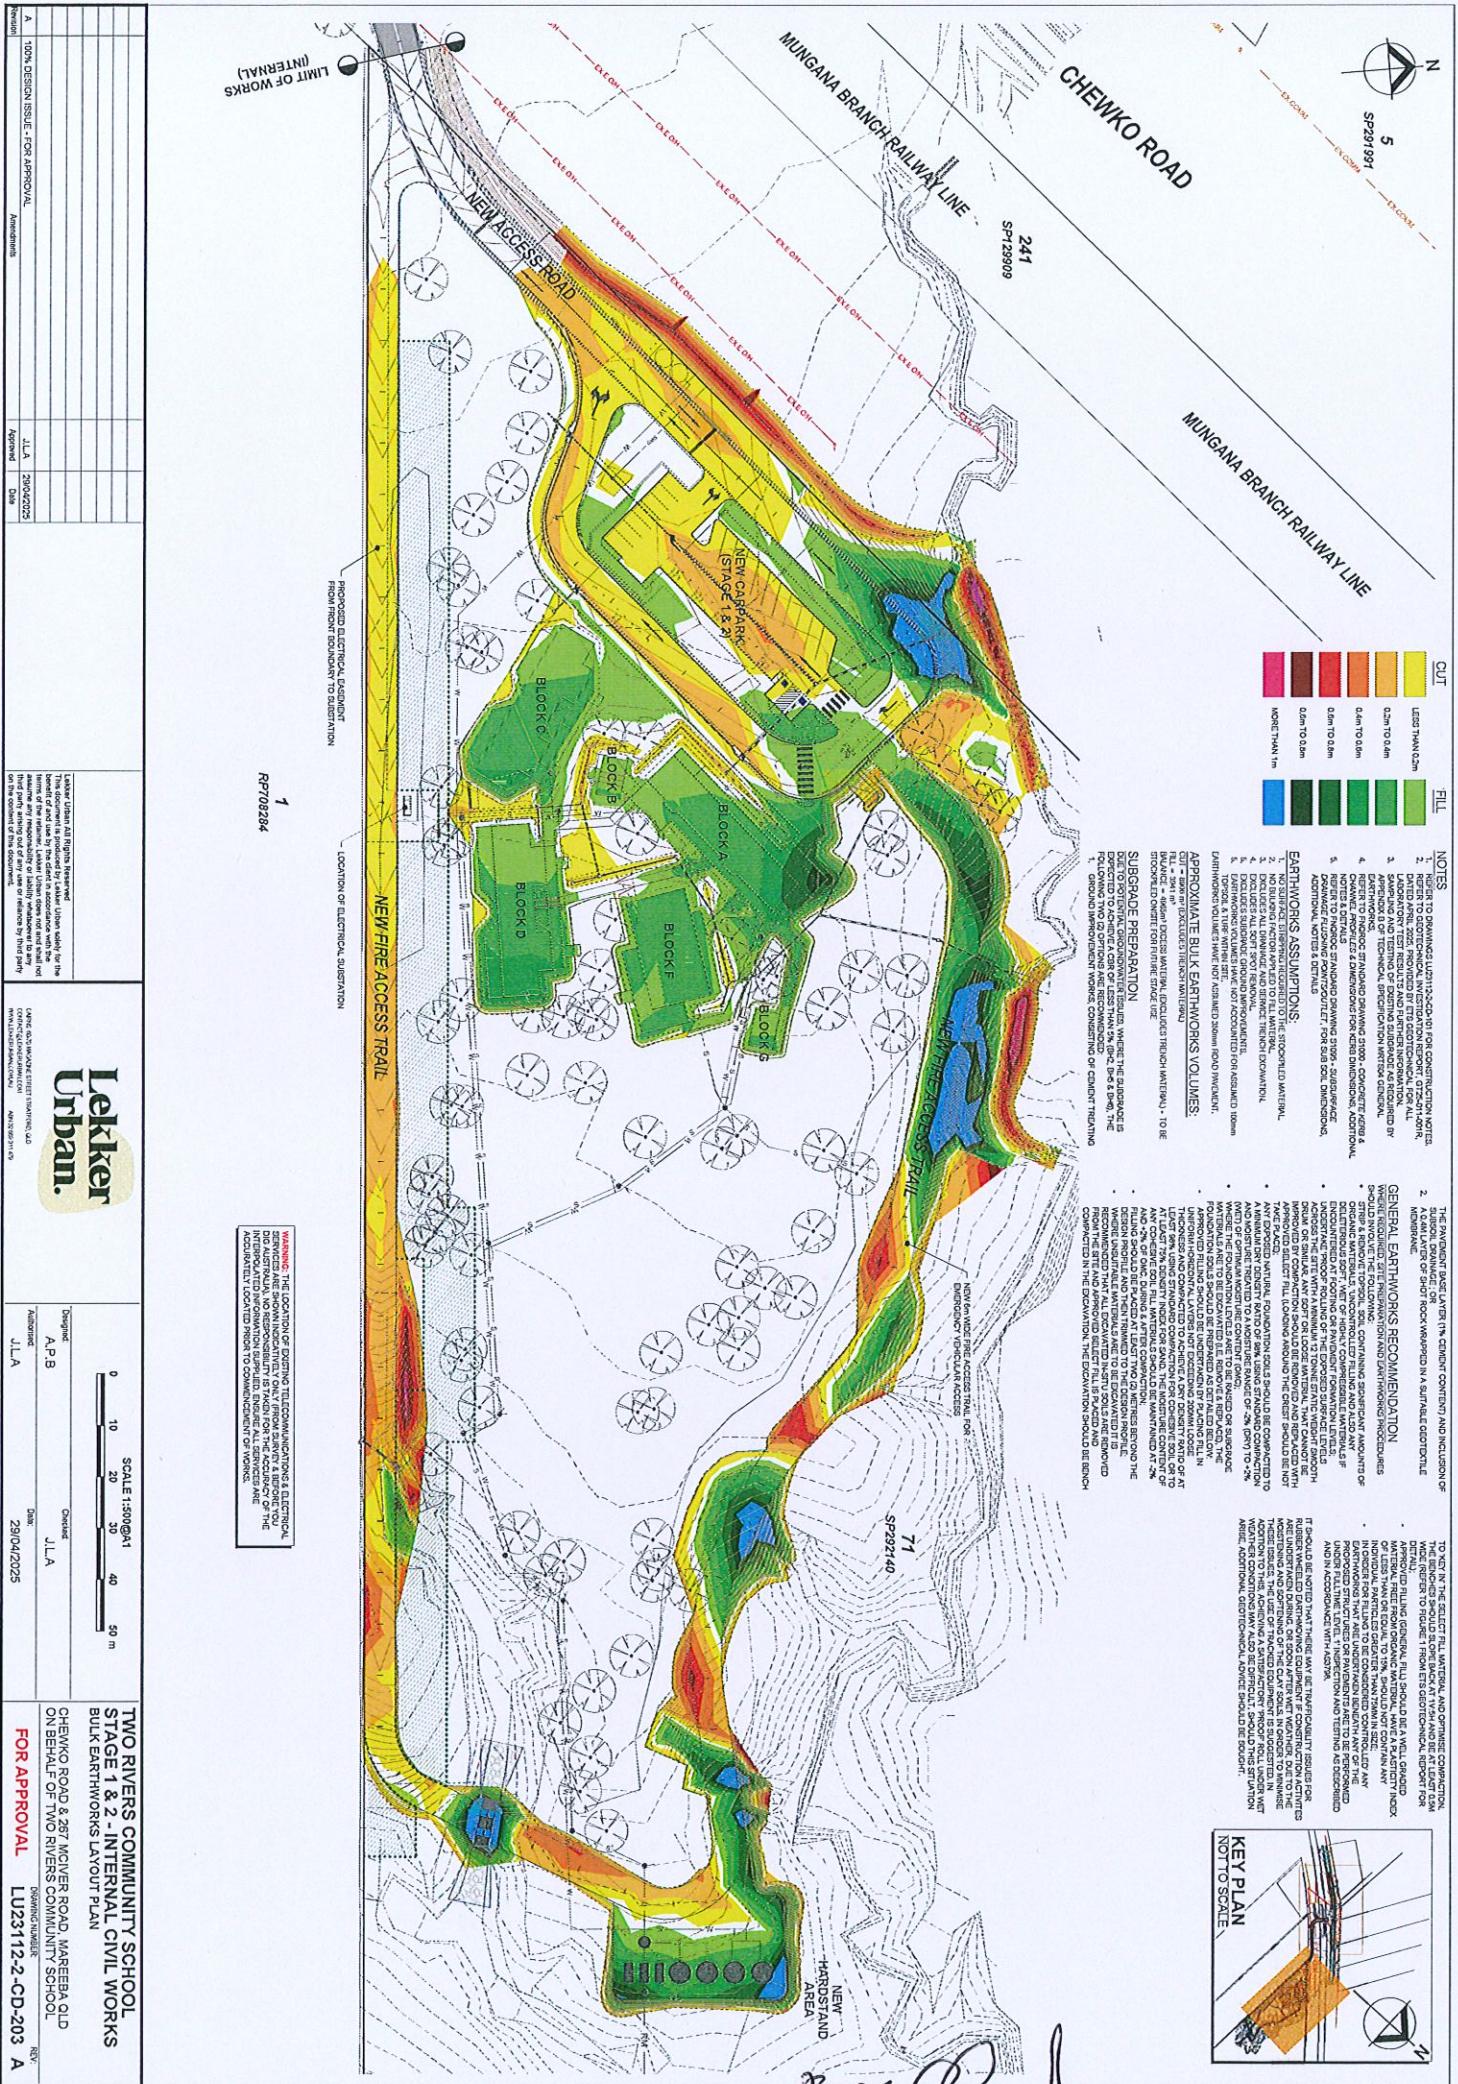
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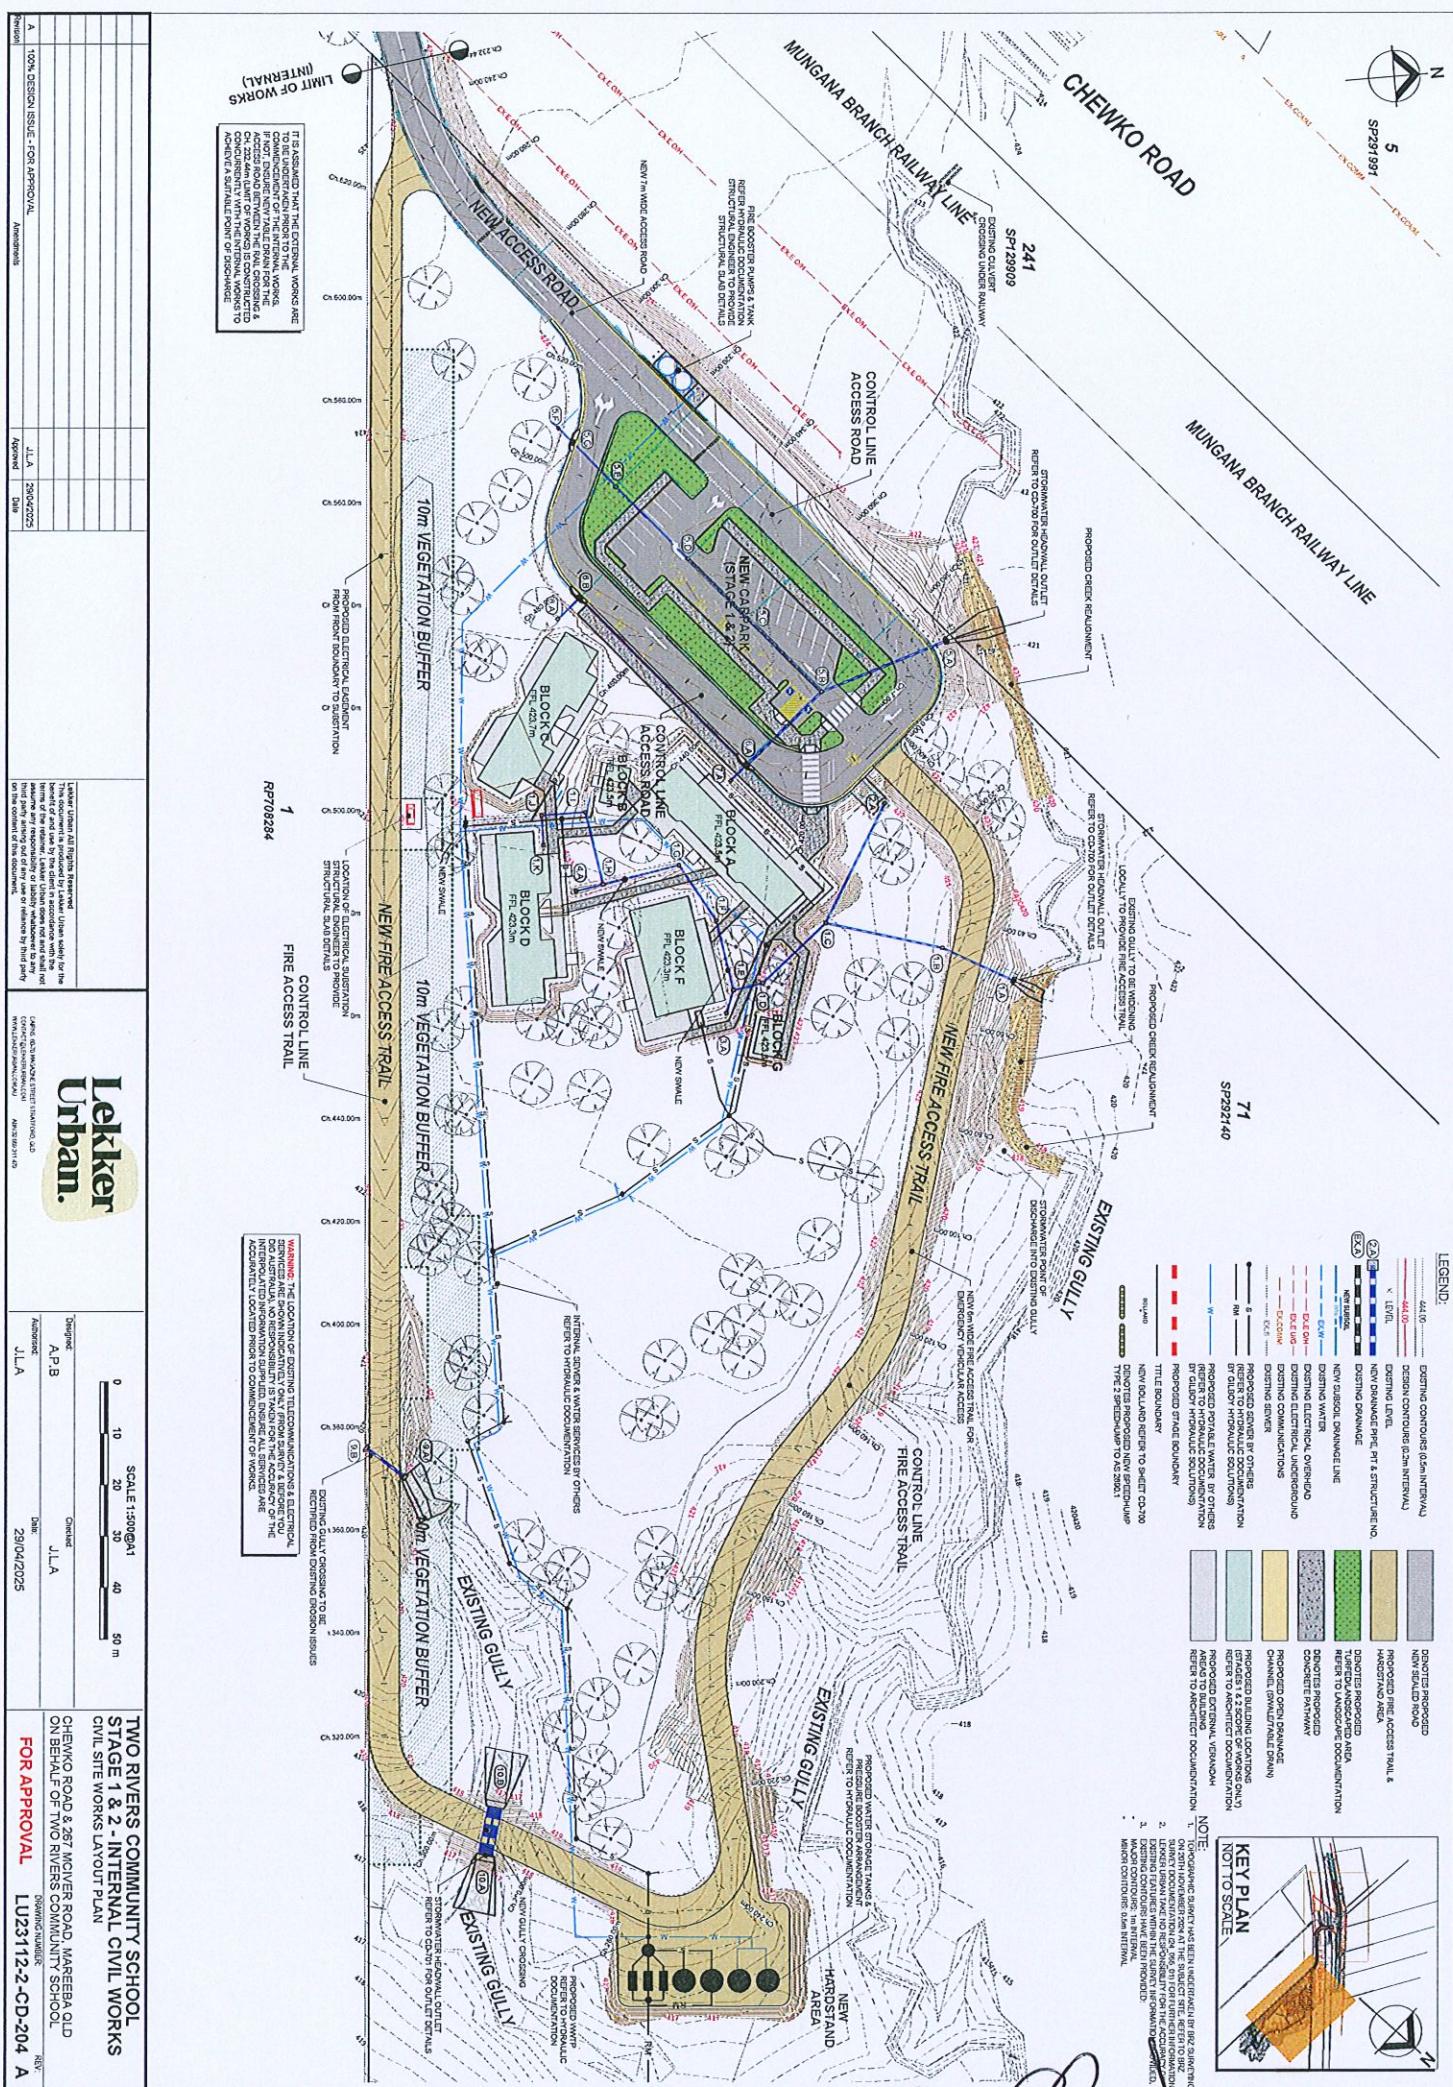
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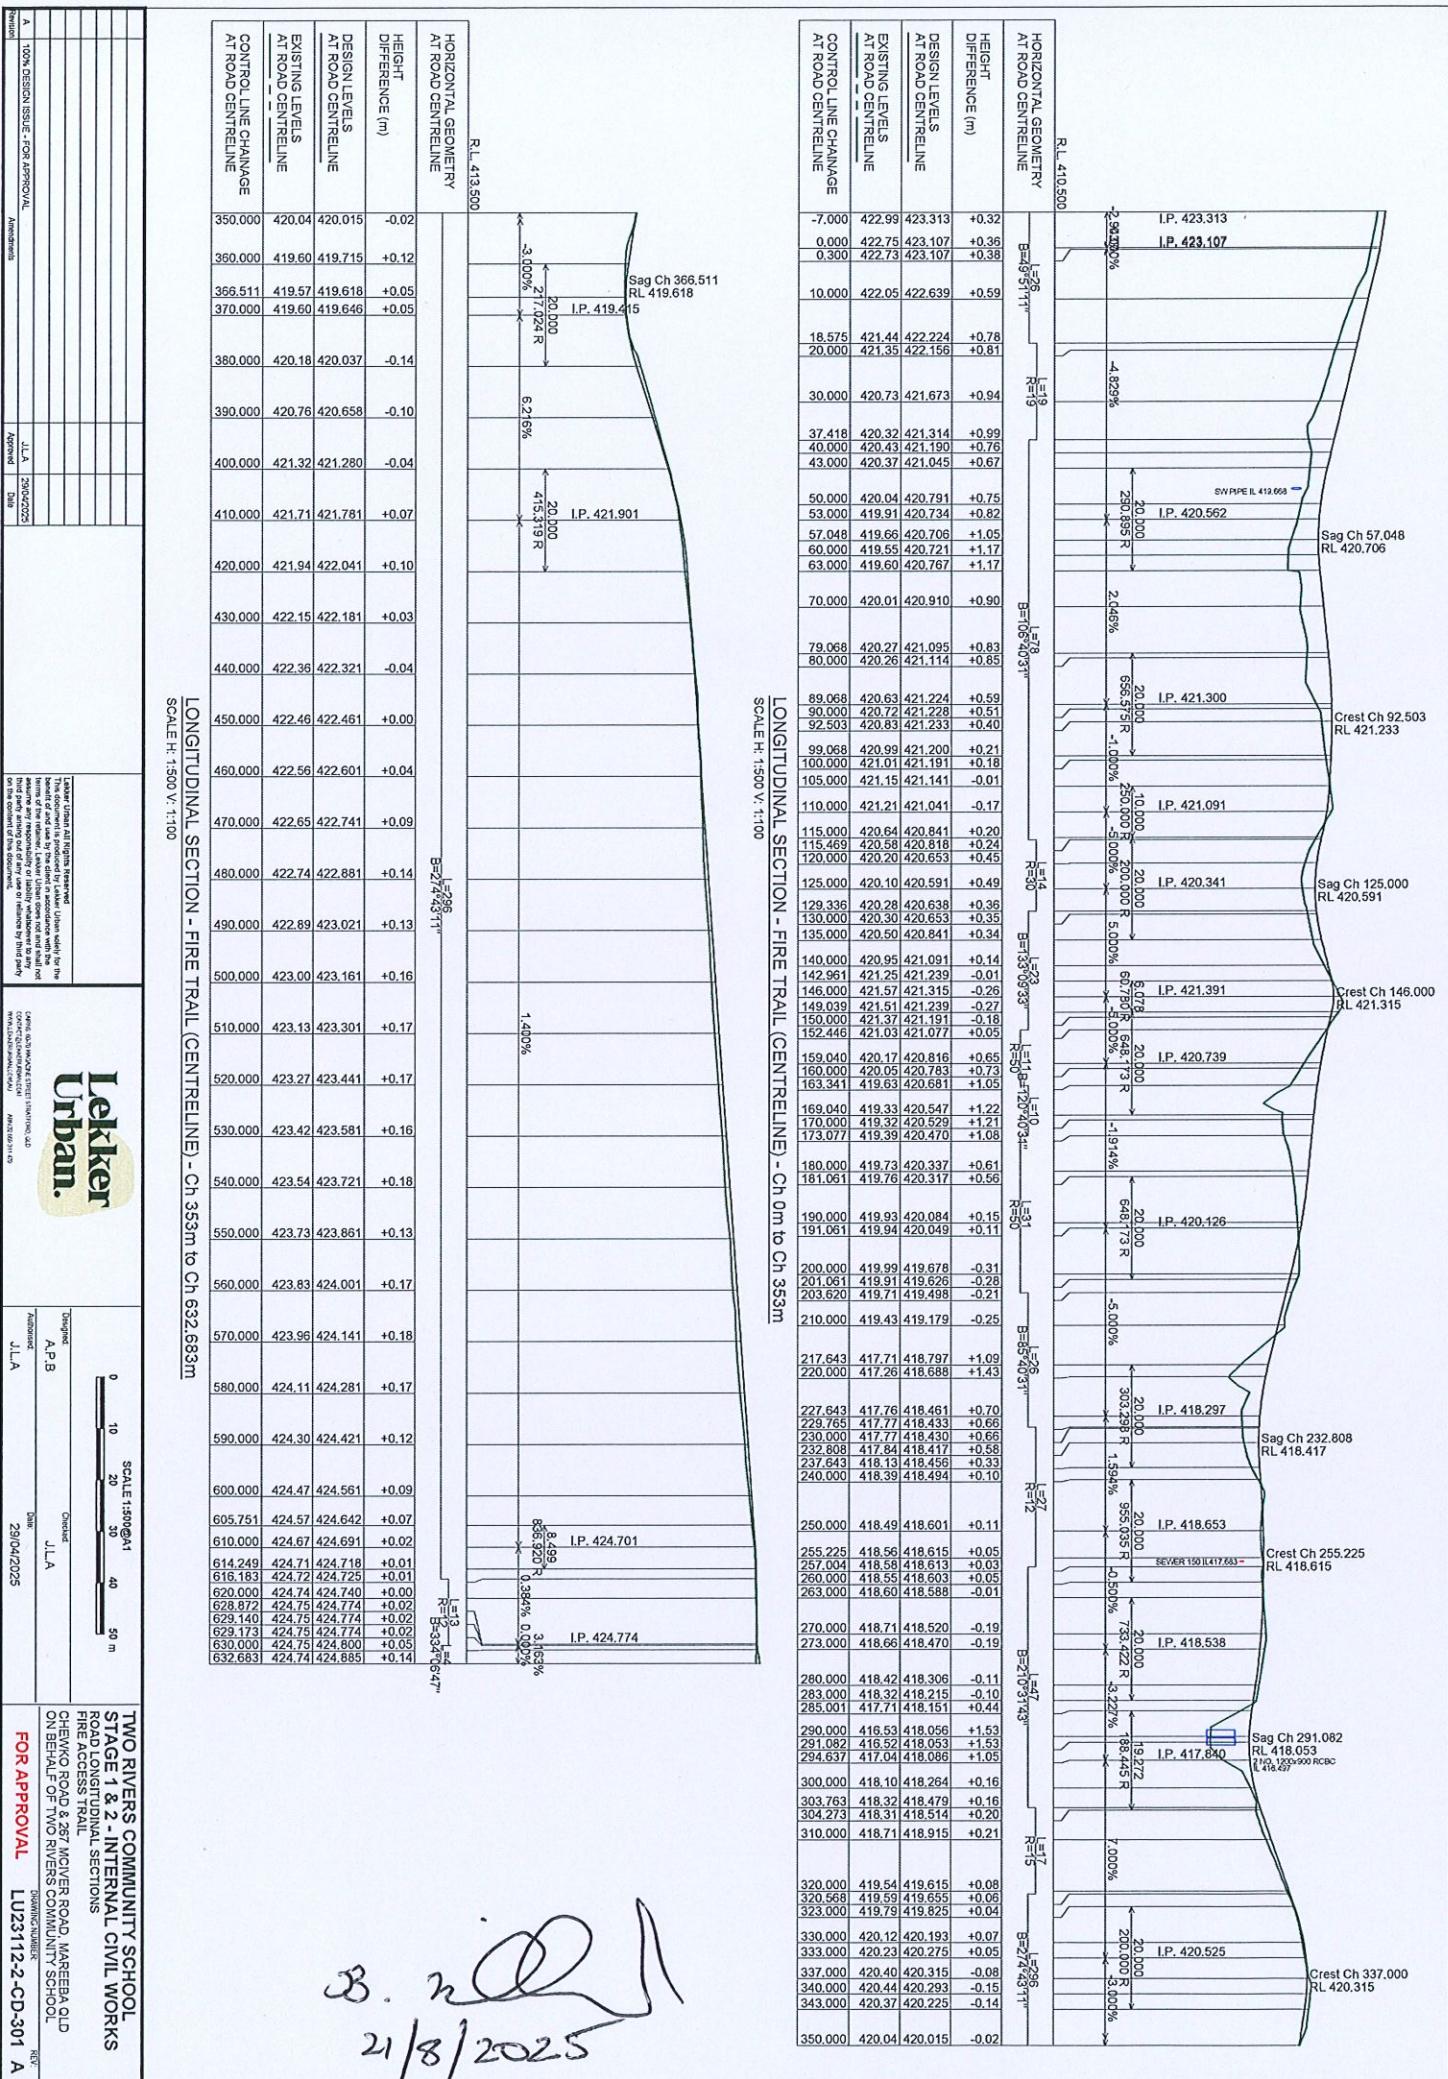



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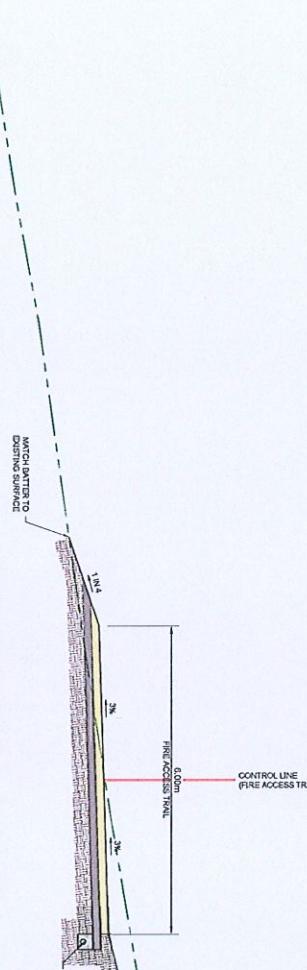







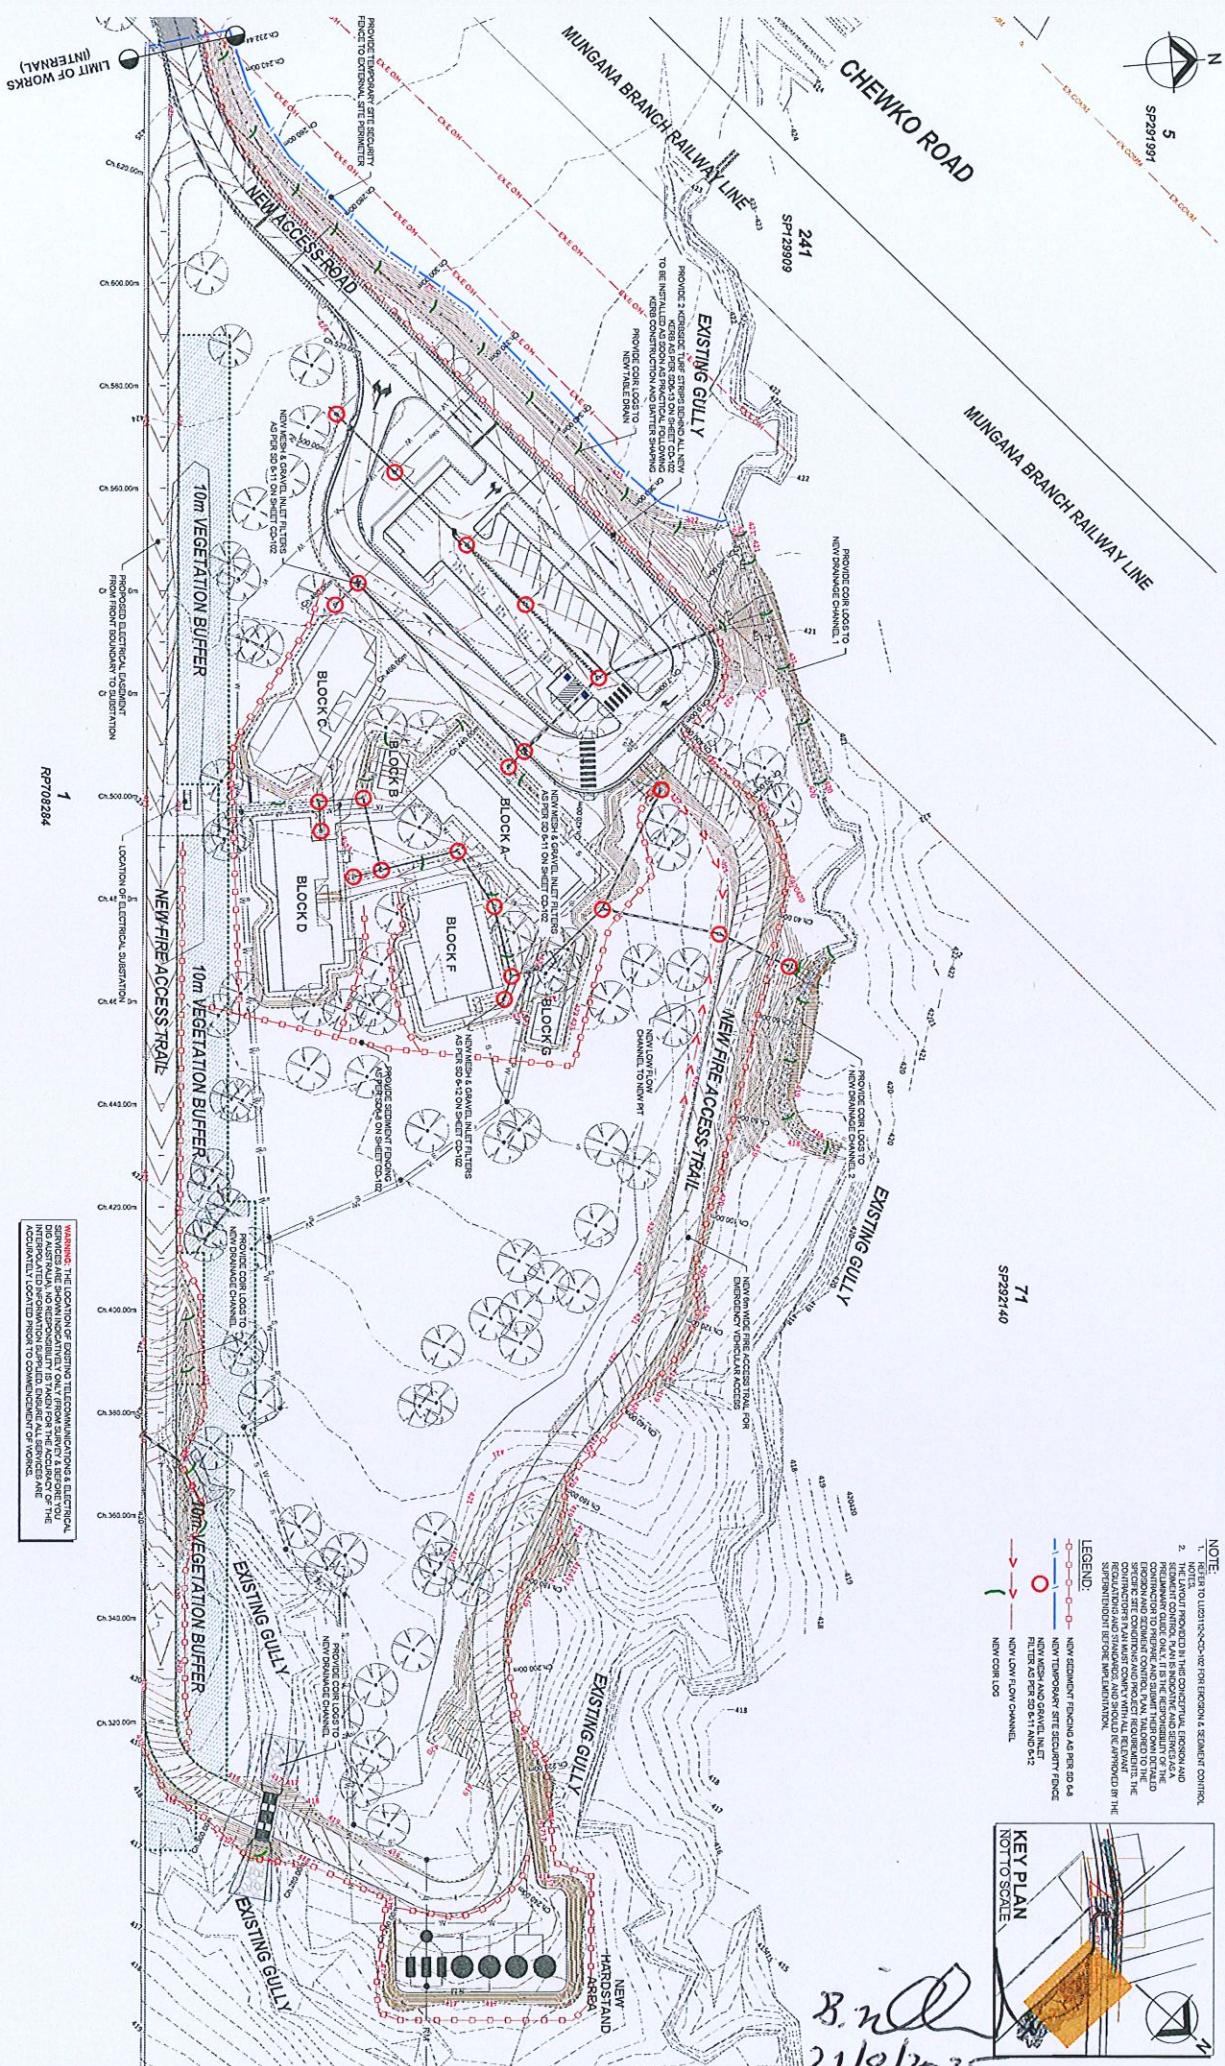

TYPICAL SECTION - ACCESS ROAD (INTERNAL)
SCALE 1:50

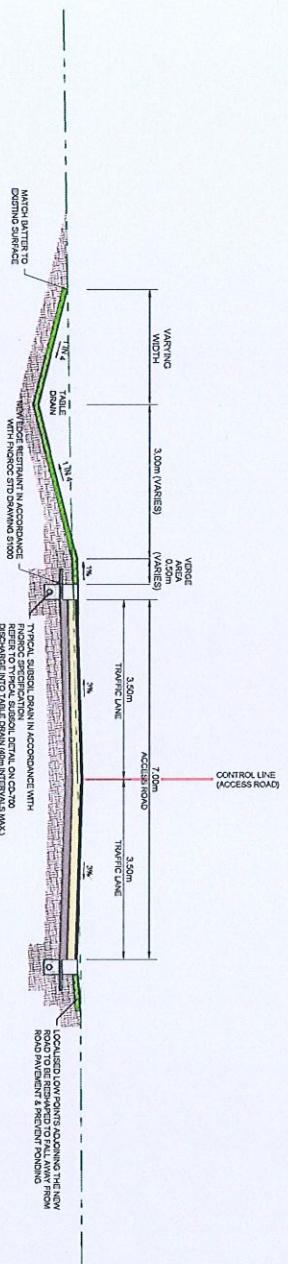

TYPICAL SECTION - FIRE ACCESS TRAIL
SCALE 1:50

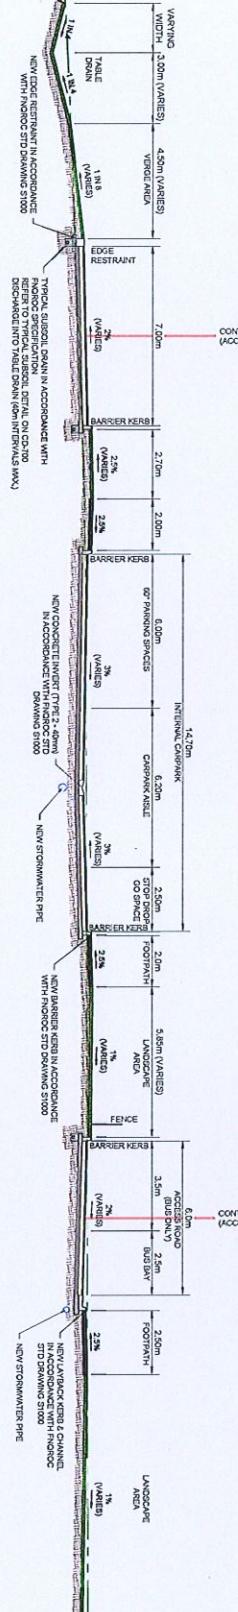

TYPICAL SECTION - NEW CARPARK (STAGE 1 & 2)
SCALE 1:100

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Approved	J.L.A. Date
100% DESIGN ISSUE FOR APPROVAL	Approved

Approved

Notes:

APPROVED BY:
Lekker Urban
Project Manager
J.L.A.
29/04/2025

APPROVED BY:
Lekker Urban
Project Manager
J.L.A.
Approved
Date

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**TWO RIVERS COMMUNITY SCHOOL
STAGE 1 & 2 - INTERNAL CIVIL WORKS
TYPICAL ROAD SECTIONS**

CHENKO ROAD & 287 MAYER ROAD, MAREE QLD

ON BEHALF OF TWO RIVERS COMMUNITY SCHOOL

DRAWING NUMBER:

REV:

CHENG SAWHAY STREET DRAWING 520

WORKS CONTRACTOR:

Architect:

Design:

Surveyor:

Structural Engineer:

Mechanical Engineer:

Electrical Engineer:

Plumbing Engineer:

Landscaping Engineer:

Geotechnical Engineer:

Environmental Engineer:

Quantity Surveyor:

Project Manager:

Architect:

Design:

Surveyor:

Structural Engineer:

Mechanical Engineer:

Electrical Engineer:

Plumbing Engineer:

Landscaping Engineer:

Geotechnical Engineer:

Environmental Engineer:

Quantity Surveyor:

Project Manager:

Architect:

Design:

Surveyor:

Structural Engineer:

Mechanical Engineer:

Electrical Engineer:

Plumbing Engineer:

Landscaping Engineer:

Geotechnical Engineer:

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Landscaping Engineer:

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Environmental Engineer:

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Project Manager:

Architect:

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Landscaping Engineer:

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Project Manager:

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Plumbing Engineer:

Landscaping Engineer:

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Architect:

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Structural Engineer:

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Electrical Engineer:

Plumbing Engineer:

Landscaping Engineer:

Geotechnical Engineer:

Environmental Engineer:

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Structural Engineer:

Mechanical Engineer:

Electrical Engineer:

Plumbing Engineer:

Landscaping Engineer:

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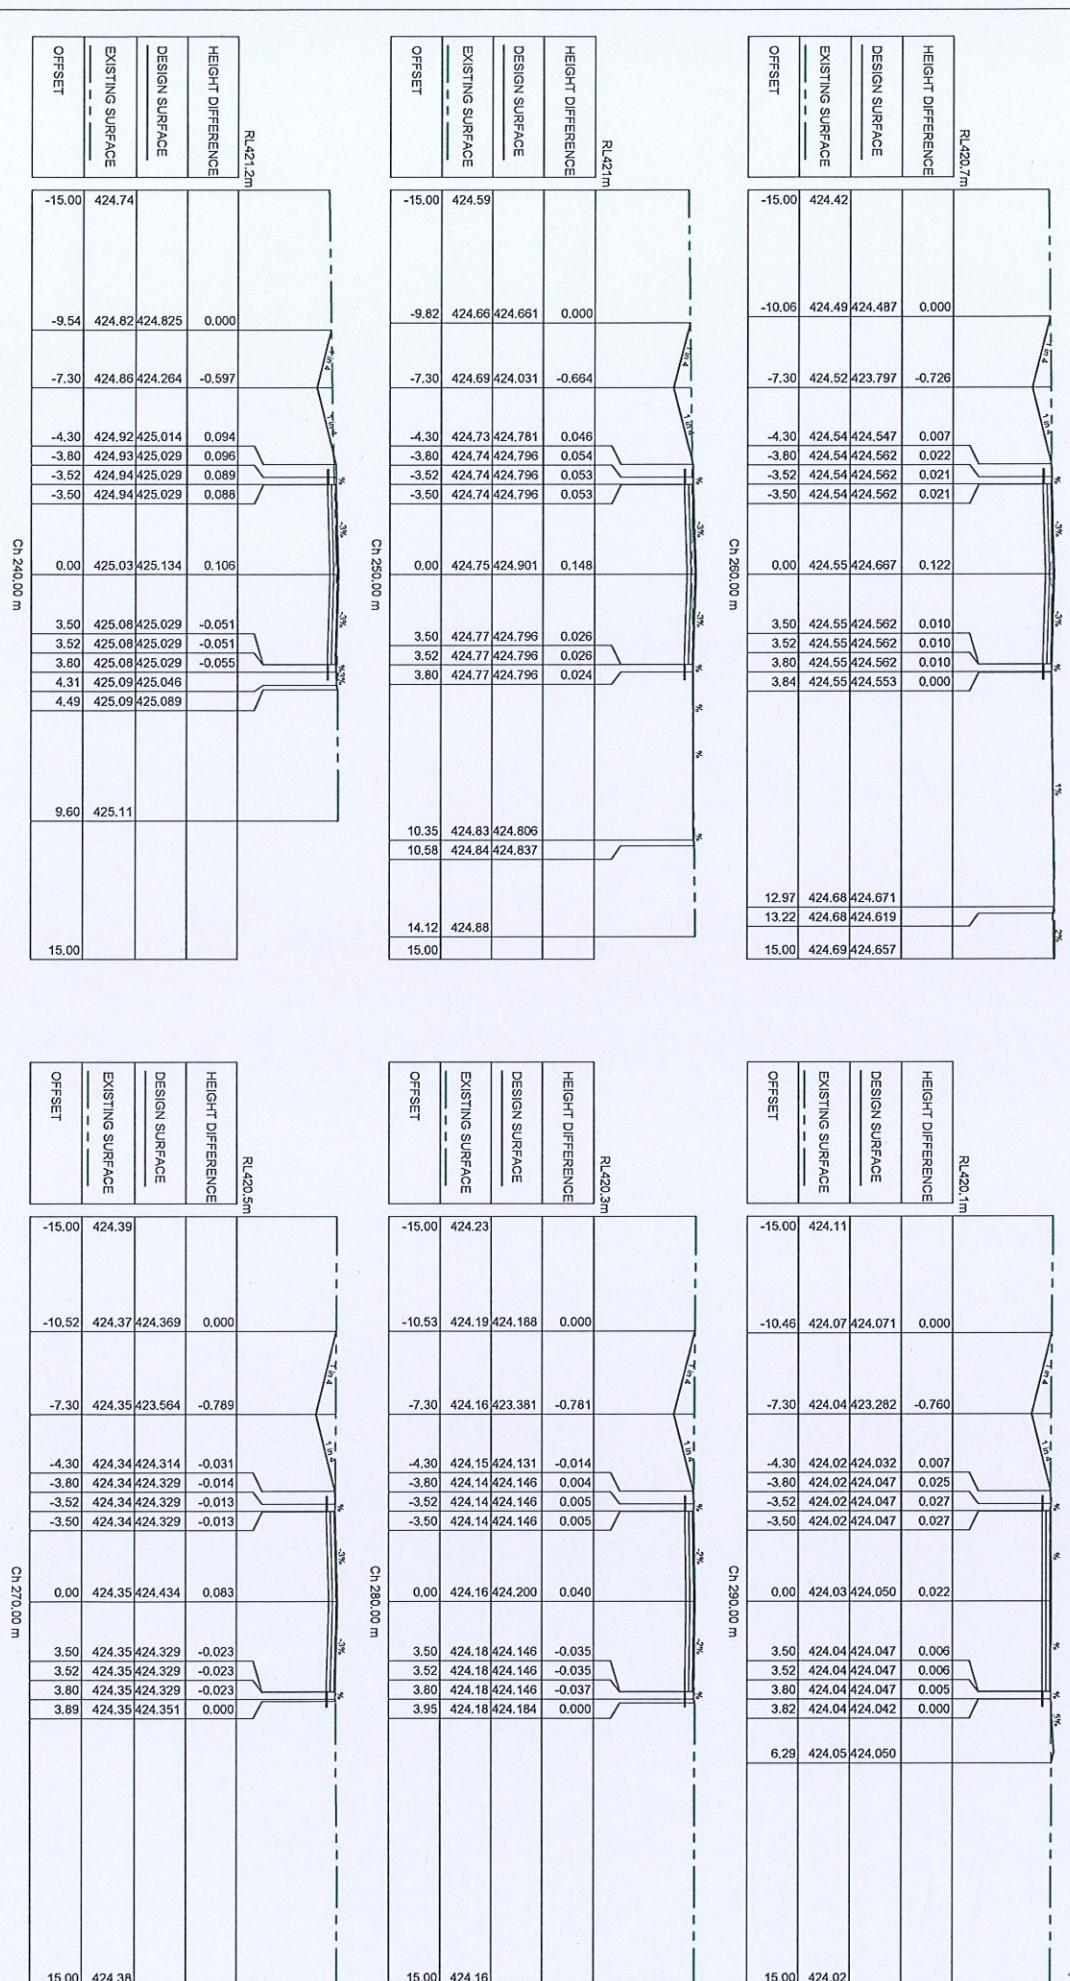
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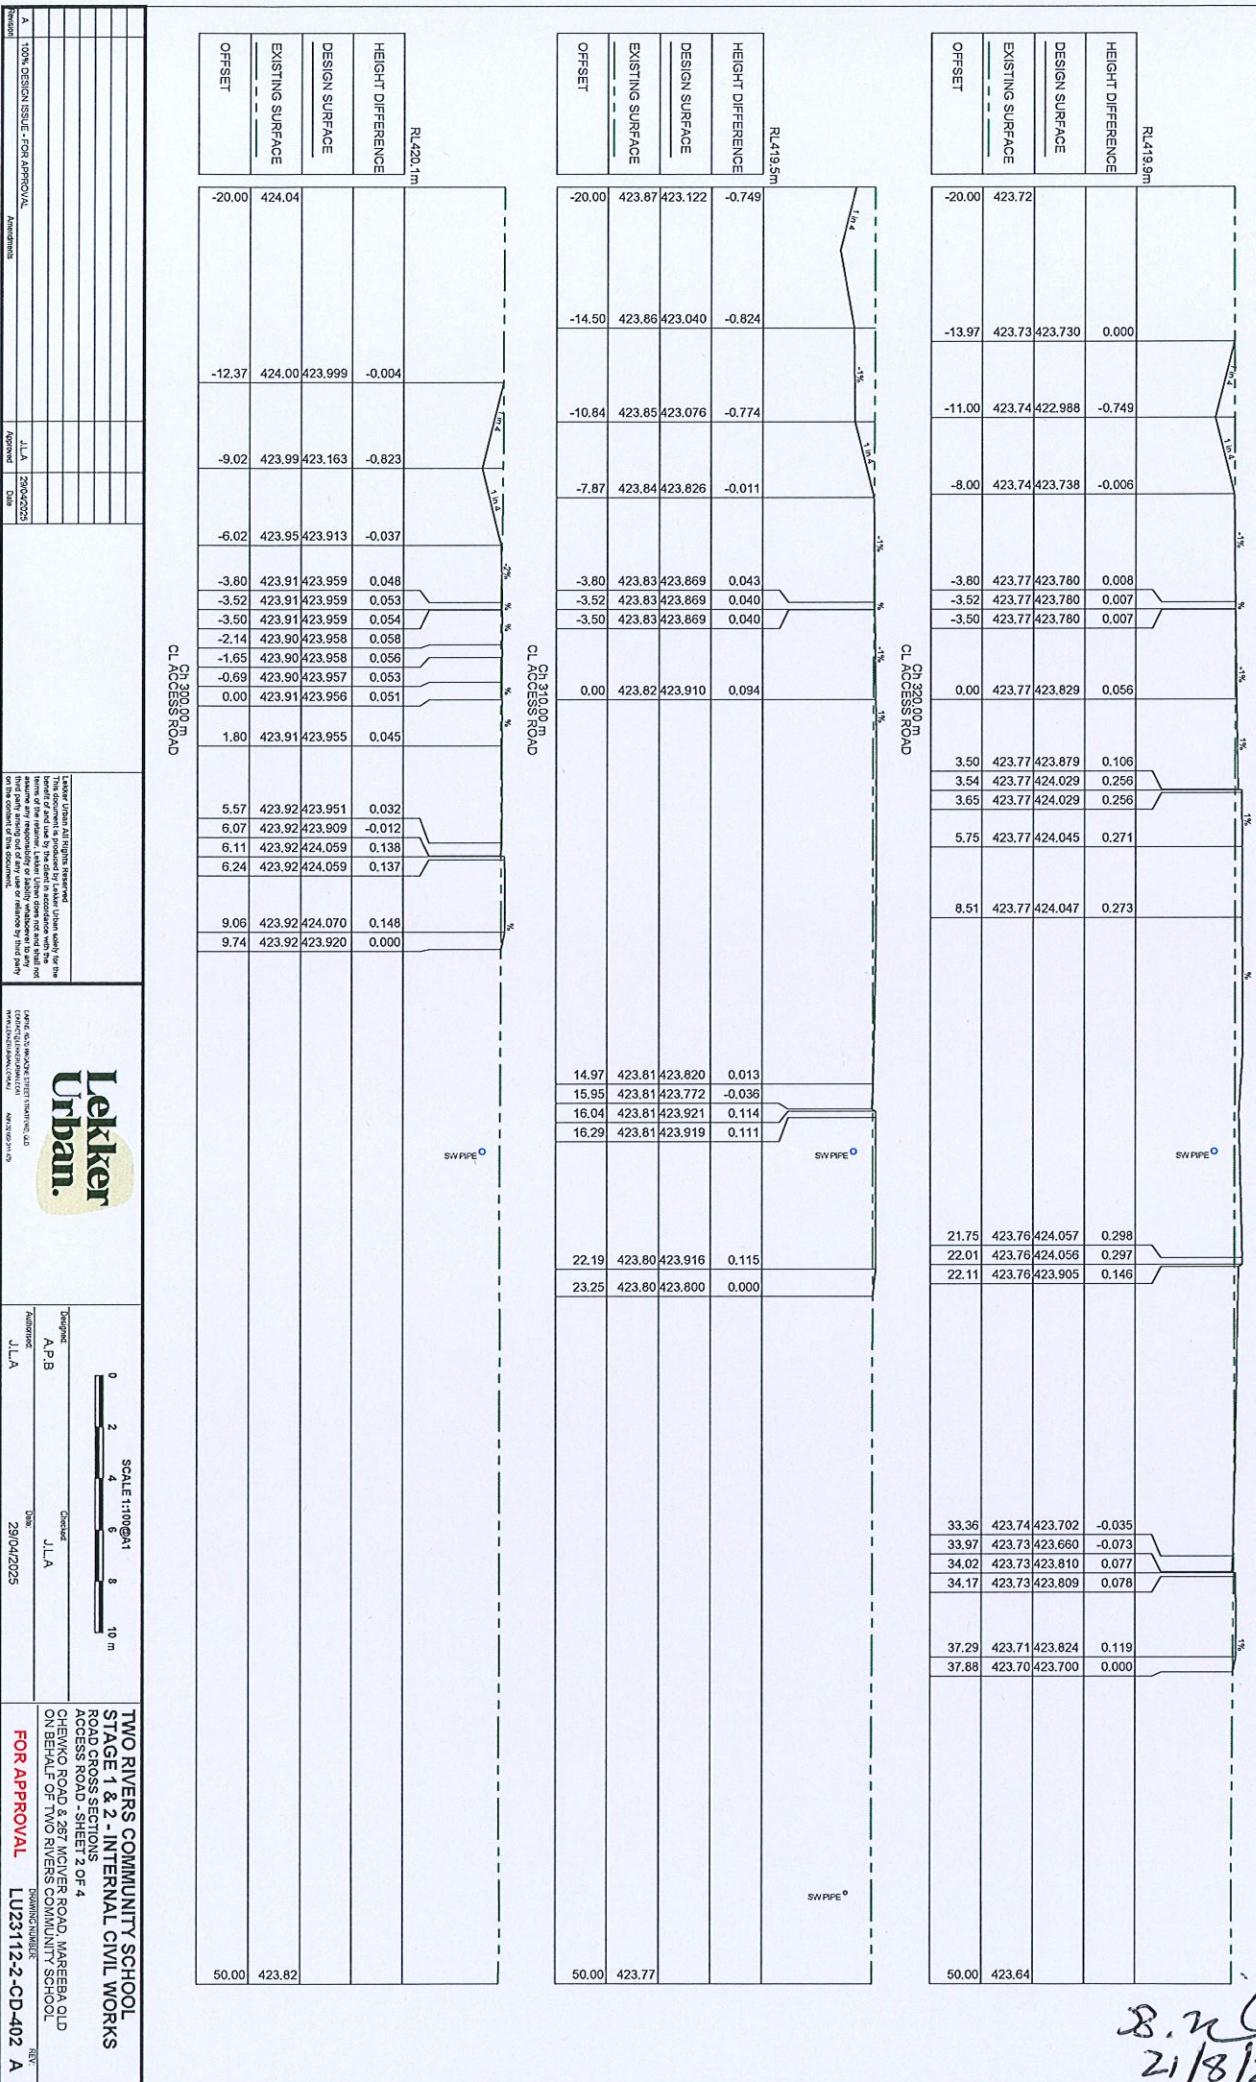
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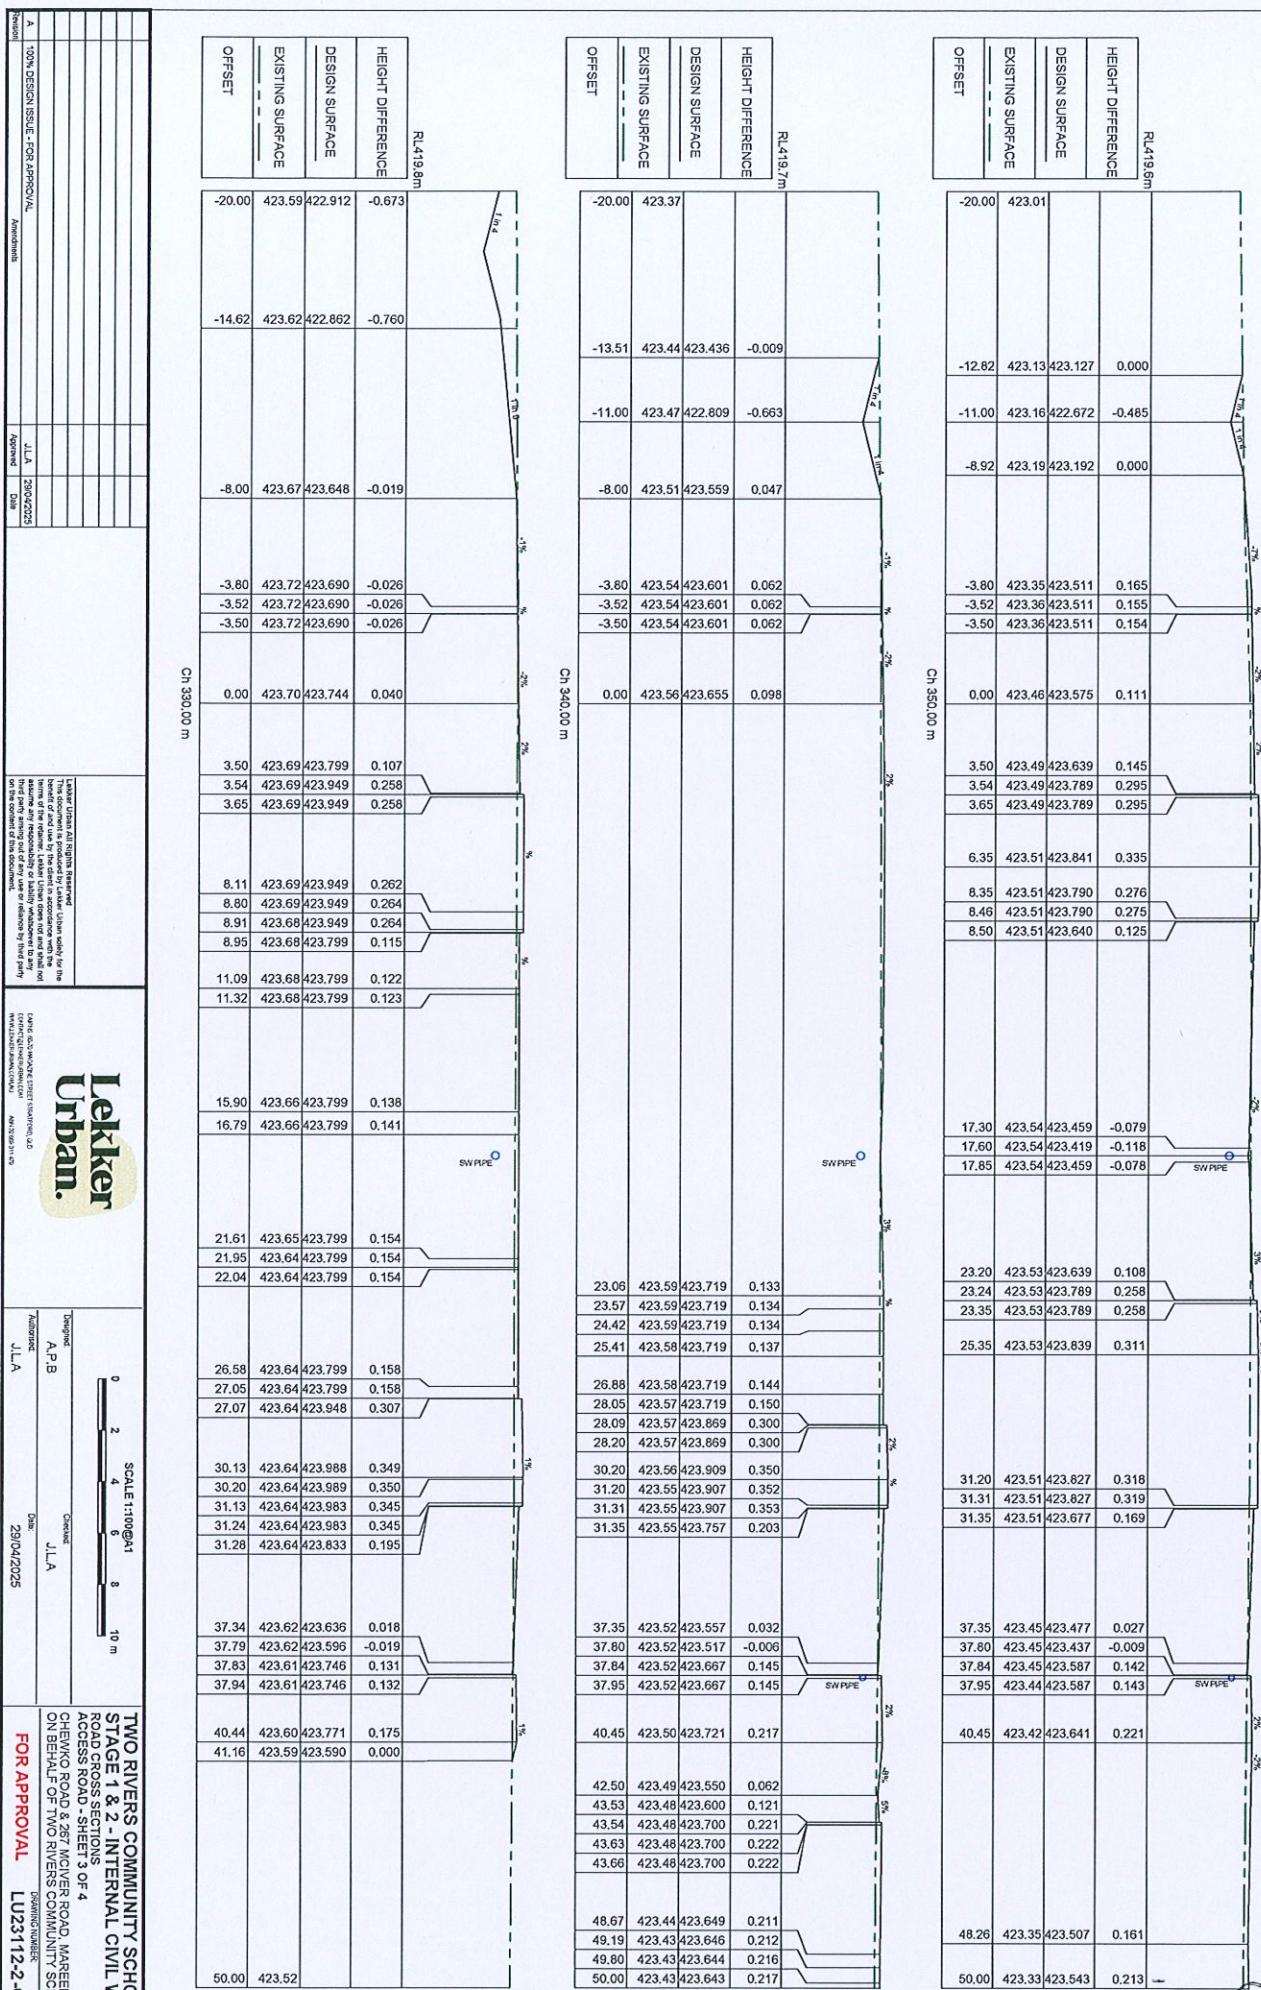
21/8/2025

TWO RIVERS COMMUNITY SCHOOL STAGE 1 & 2 - INTERNAL CIVIL WORKS						
ROAD CROSS SECTIONS ACCESS ROAD - SHEET 1 OF 4						
Design:	A.P.B	Check:	J.L.A			
Approved:	J.L.A	Date:	29/04/2025			
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FOR APPROVAL						
LJU23112-2-CD-401 A						




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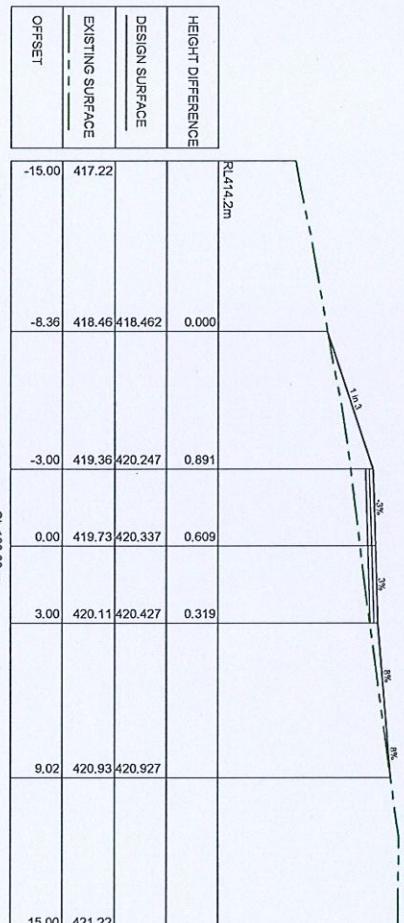
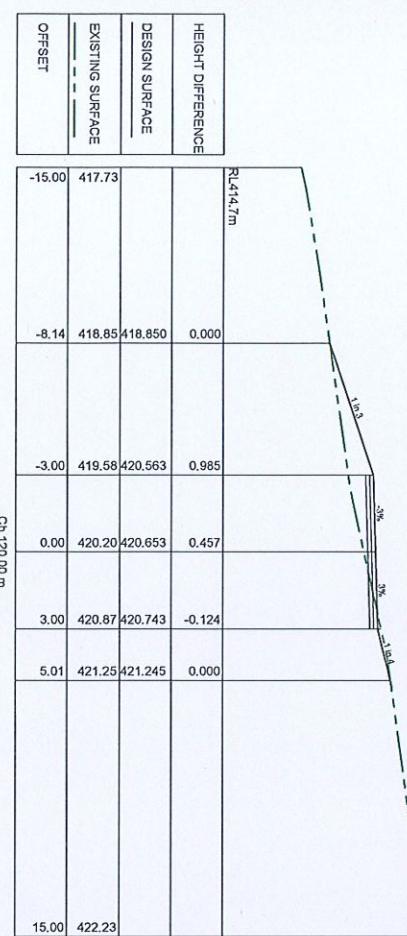
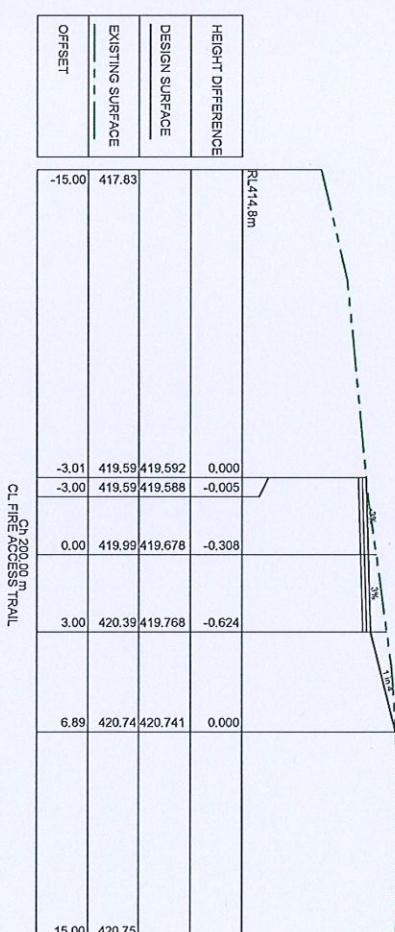
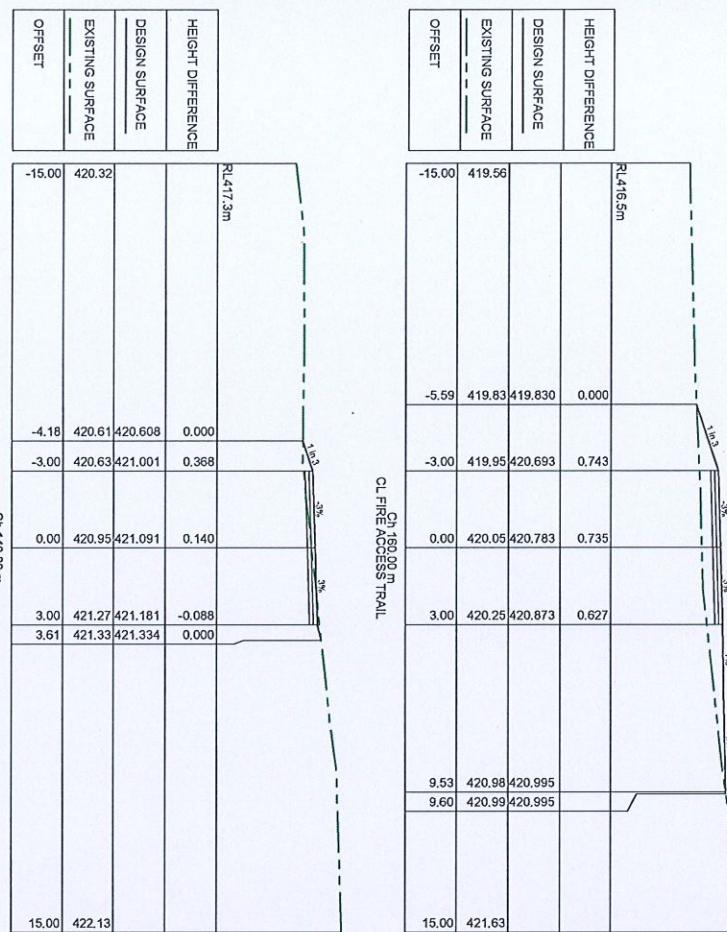





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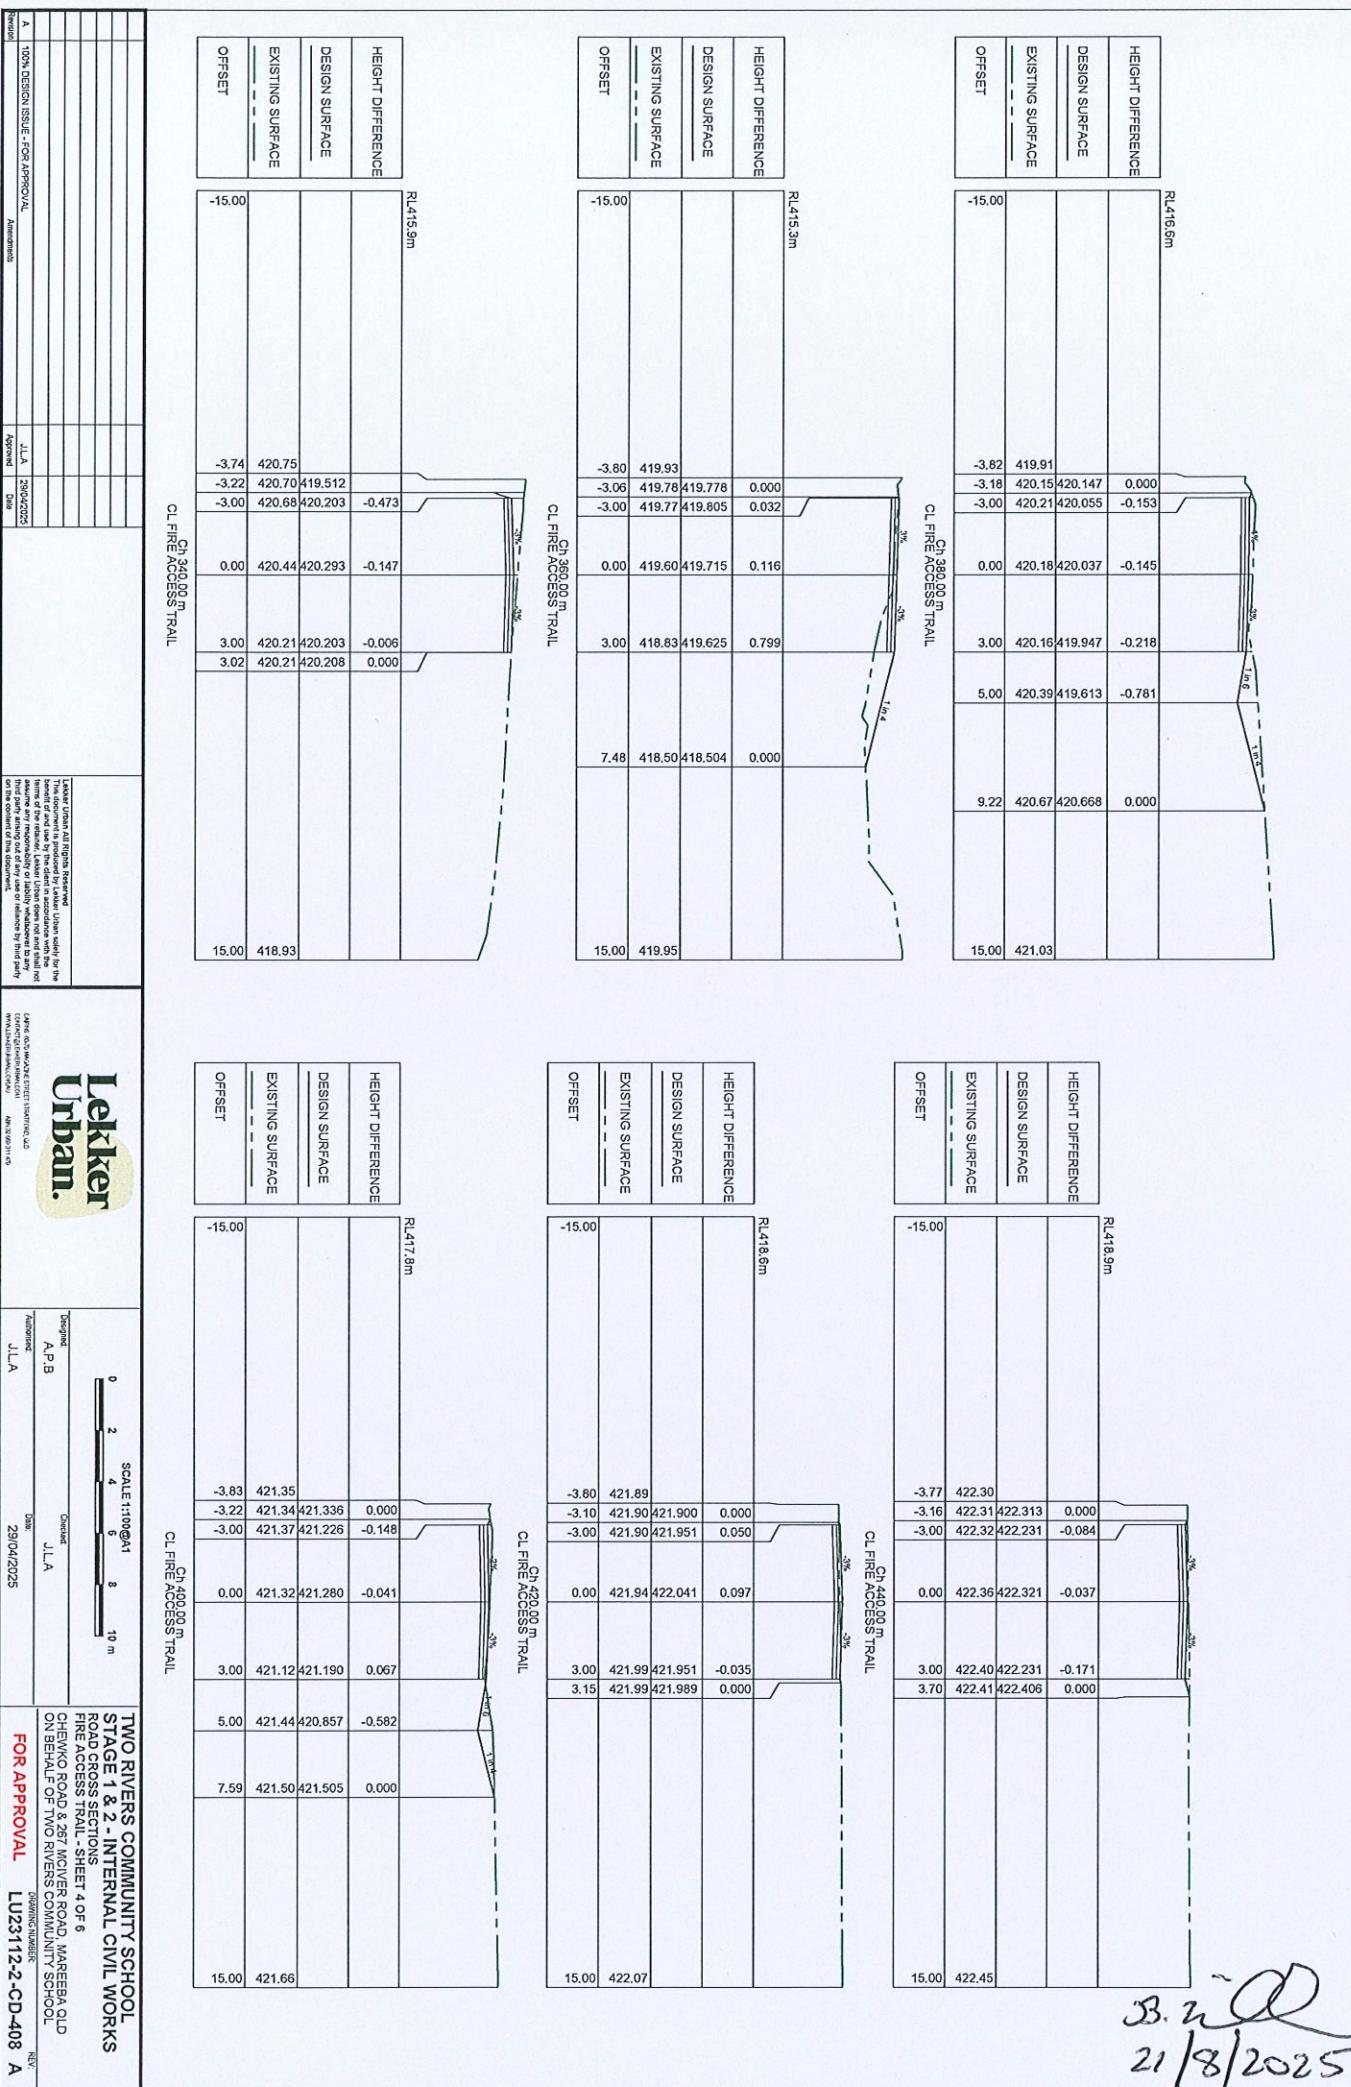


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21/8/2025

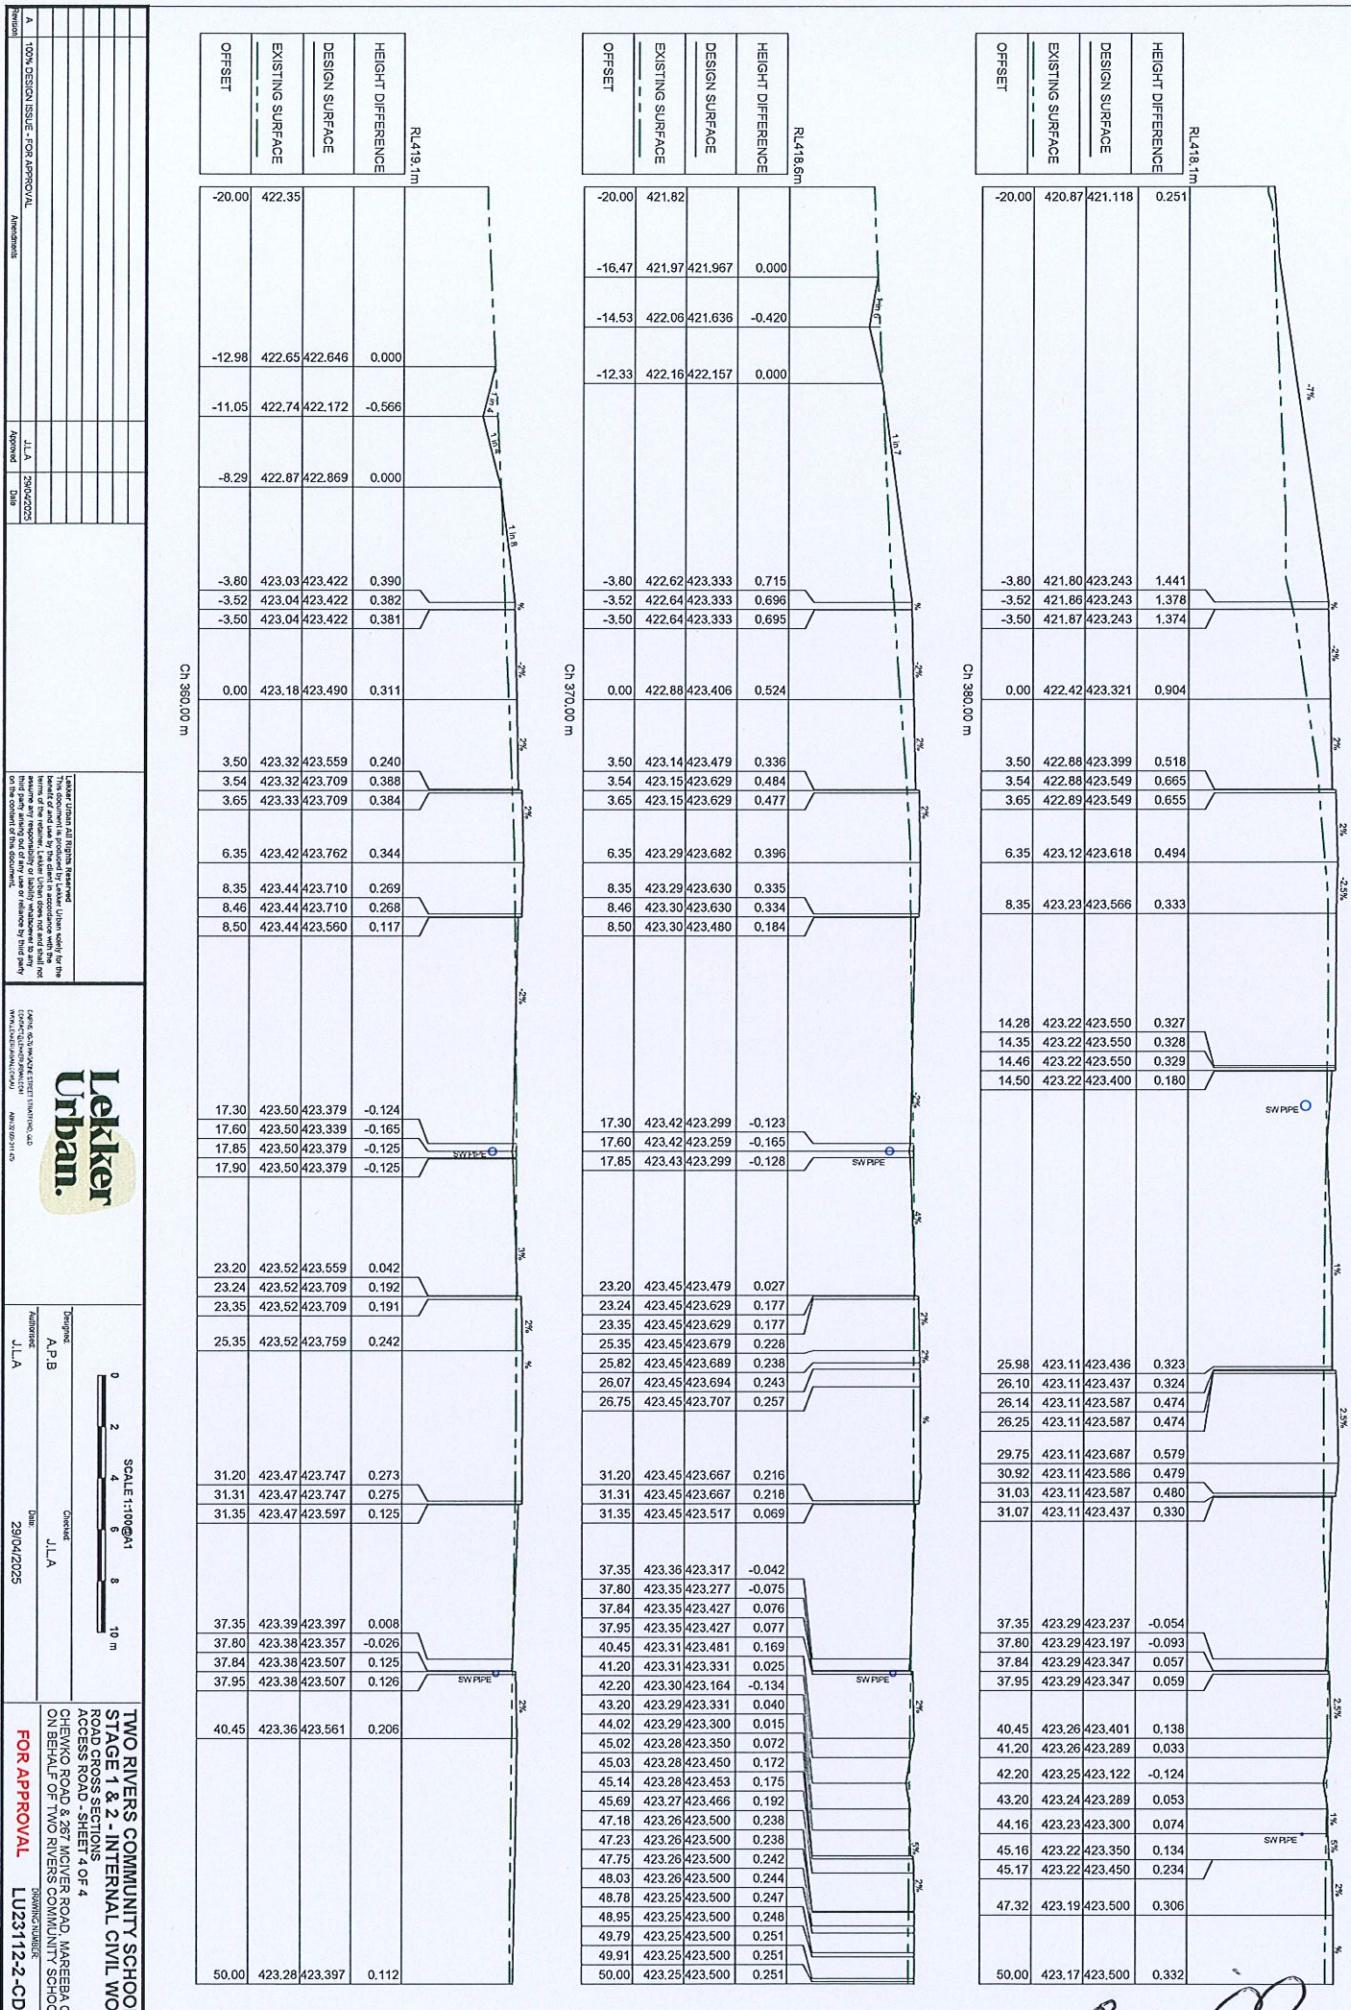

TWO RIVERS COMMUNITY SCHOOL STAGE 1 & 2 - INTERNAL CIVIL WORKS ROAD CROSS SECTIONS FIRE ACCESS TRAIL - SHEET 2 OF 6			
<i>Two Rivers Community School Project - Stage 1 & 2 Internal Civil Works</i>			
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A	100% DESIGN ISSUE FOR APPROVAL	J.L.A	Approved
REV	29/04/2023	Date	29/04/2023
FOR APPROVAL	LJU23112-2-CD-406 A	Signature	8. n 21/8/2023





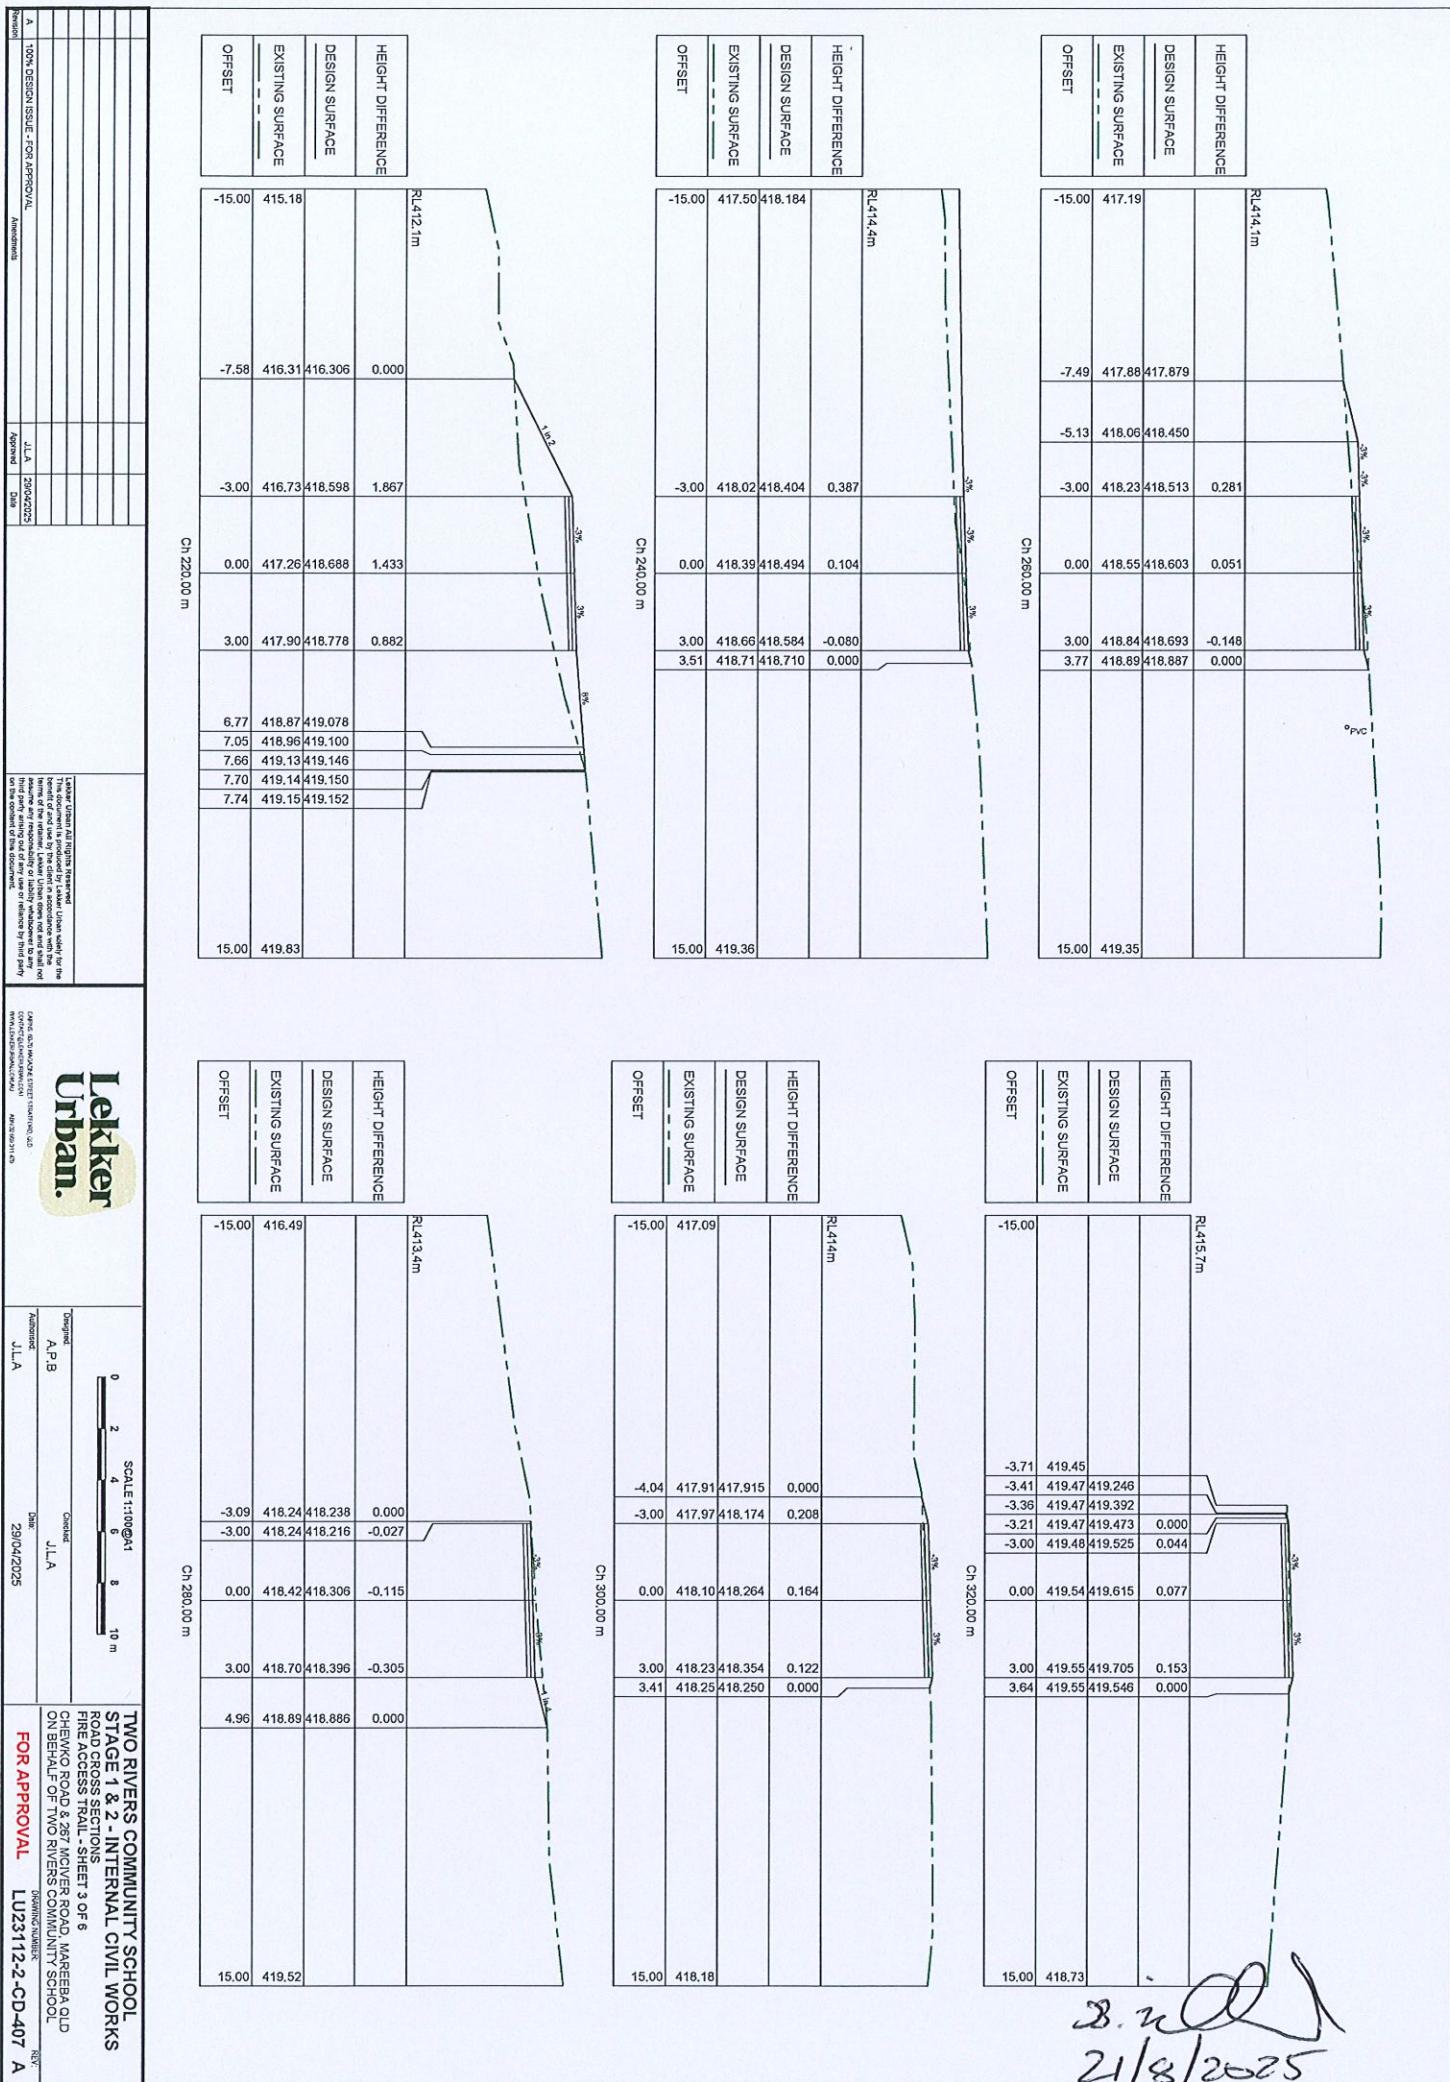

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TWO RIVERS COMMUNITY SCHOOL STAGE 1 & 2 - INTERNAL CIVIL WORKS	
ROAD CROSS SECTIONS FIRE ACCESS TRAIL - SHEET 4 OF 6	
CHEMVO ROAD & 287 MOWER ROAD, MARREBA QLD ON BEHALF OF TWO RIVERS COMMUNITY SCHOOL DRAWN BY: J.L.A. CHECKED BY: J.L.A. APPROVED BY: J.L.A.	
FOR APPROVAL	
Approved	Date: 29/04/2025
Comments: None	
Signature: J.L.A.	
Approval Date: 29/04/2025	
Approval Number: LU23112-2-CD-408 A	

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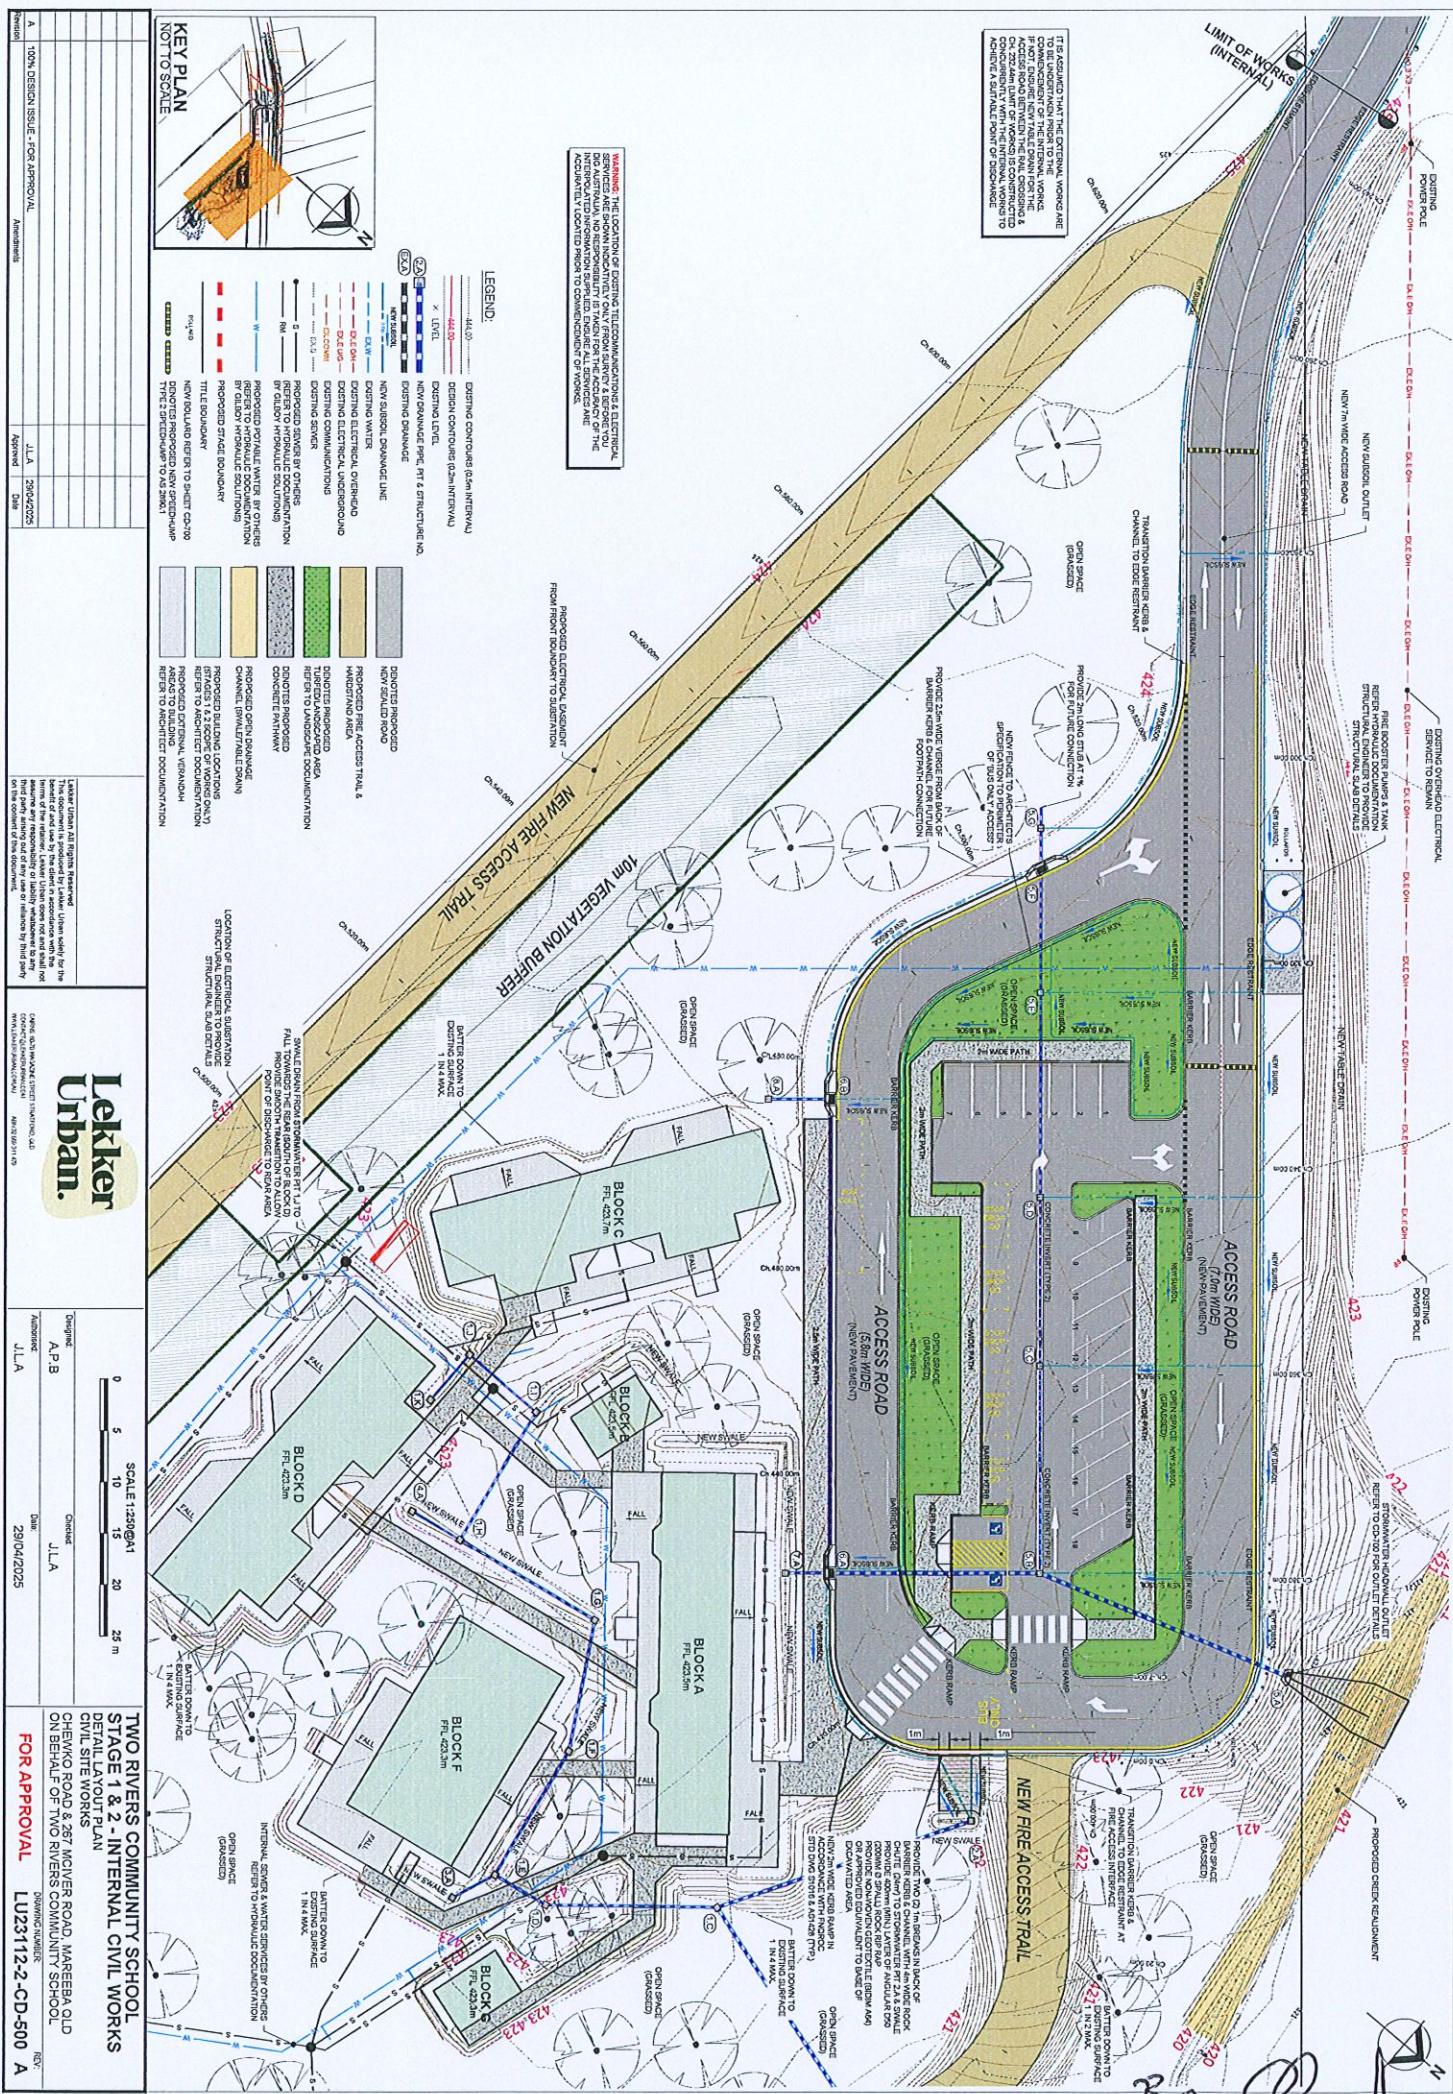



		Lekker Urban.	
		TWO RIVERS COMMUNITY SCHOOL STAGE 1 & 2 - INTERNAL CIVIL WORKS	
		ROAD CROSS SECTIONS FIRE ACCESS TRAIL - SHEET 5 OF 6	
		CHEMVO ROAD & 287 MOWER ROAD, MARREBA QLD ON BEHALF OF TWO RIVERS COMMUNITY SCHOOL	
		DRAWN BY: DUNNING JAMES REV: 0000 CROSS SECTION NUMBER: 5 DATE: 29/04/2025 CONTRACTOR: CHEMVO CONSTRUCTION MANAGER: J.L.A. APPROVED: J.L.A.	
		FOR APPROVAL	
		LJU23112-2-CD-409 A	
		B.R. 21/8/2025	

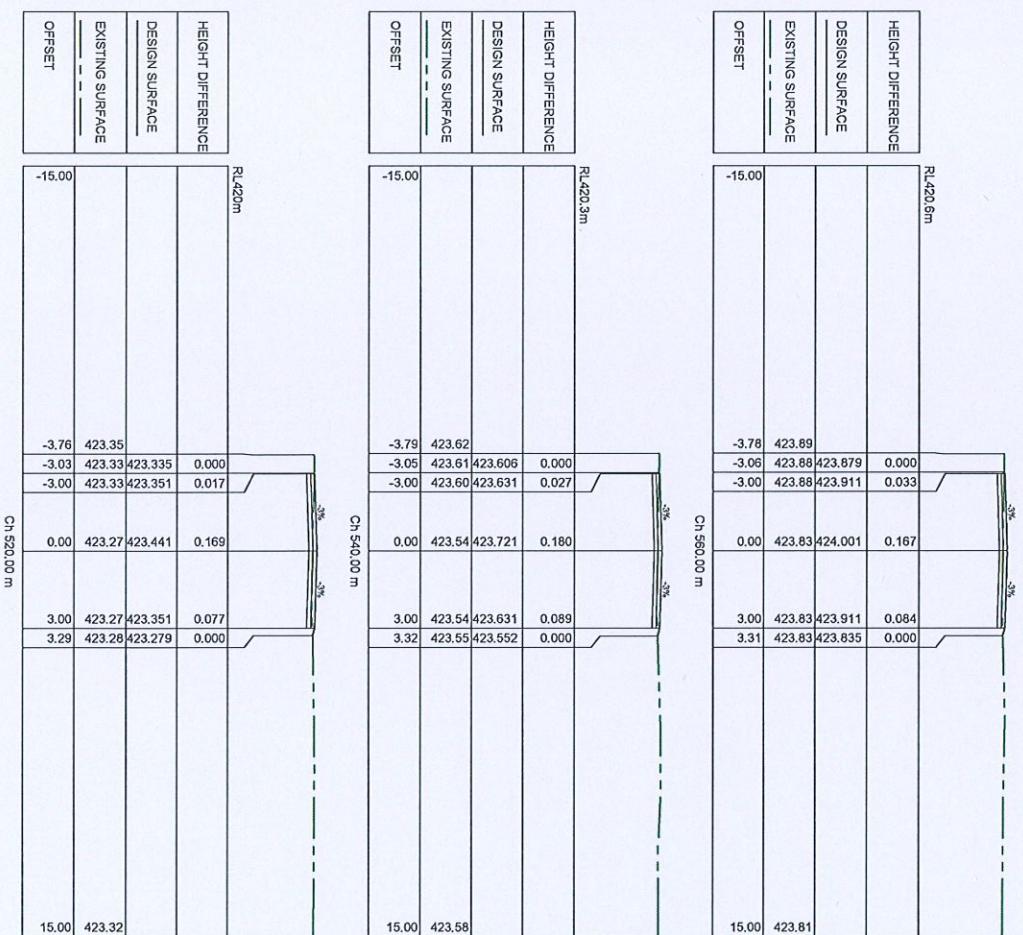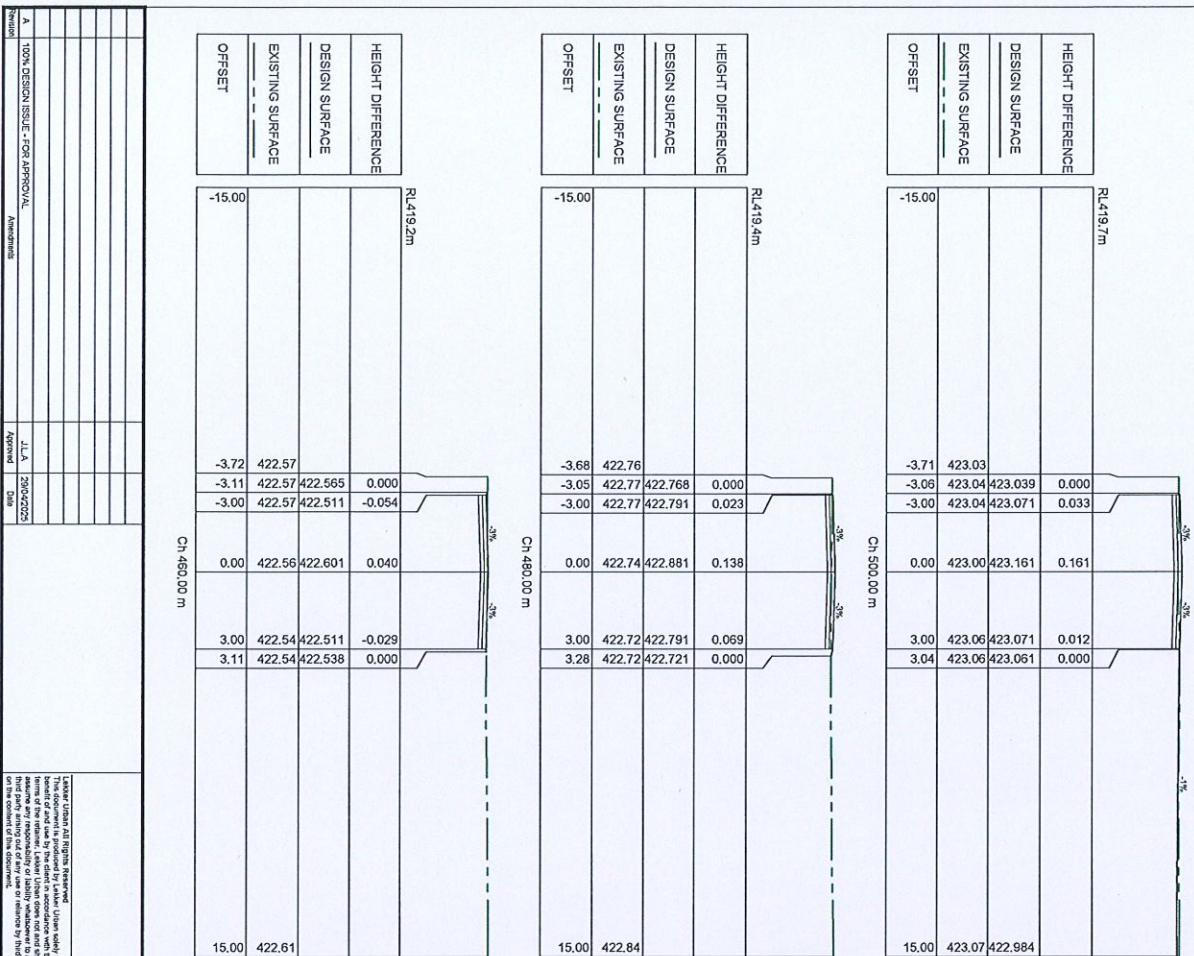Notes:


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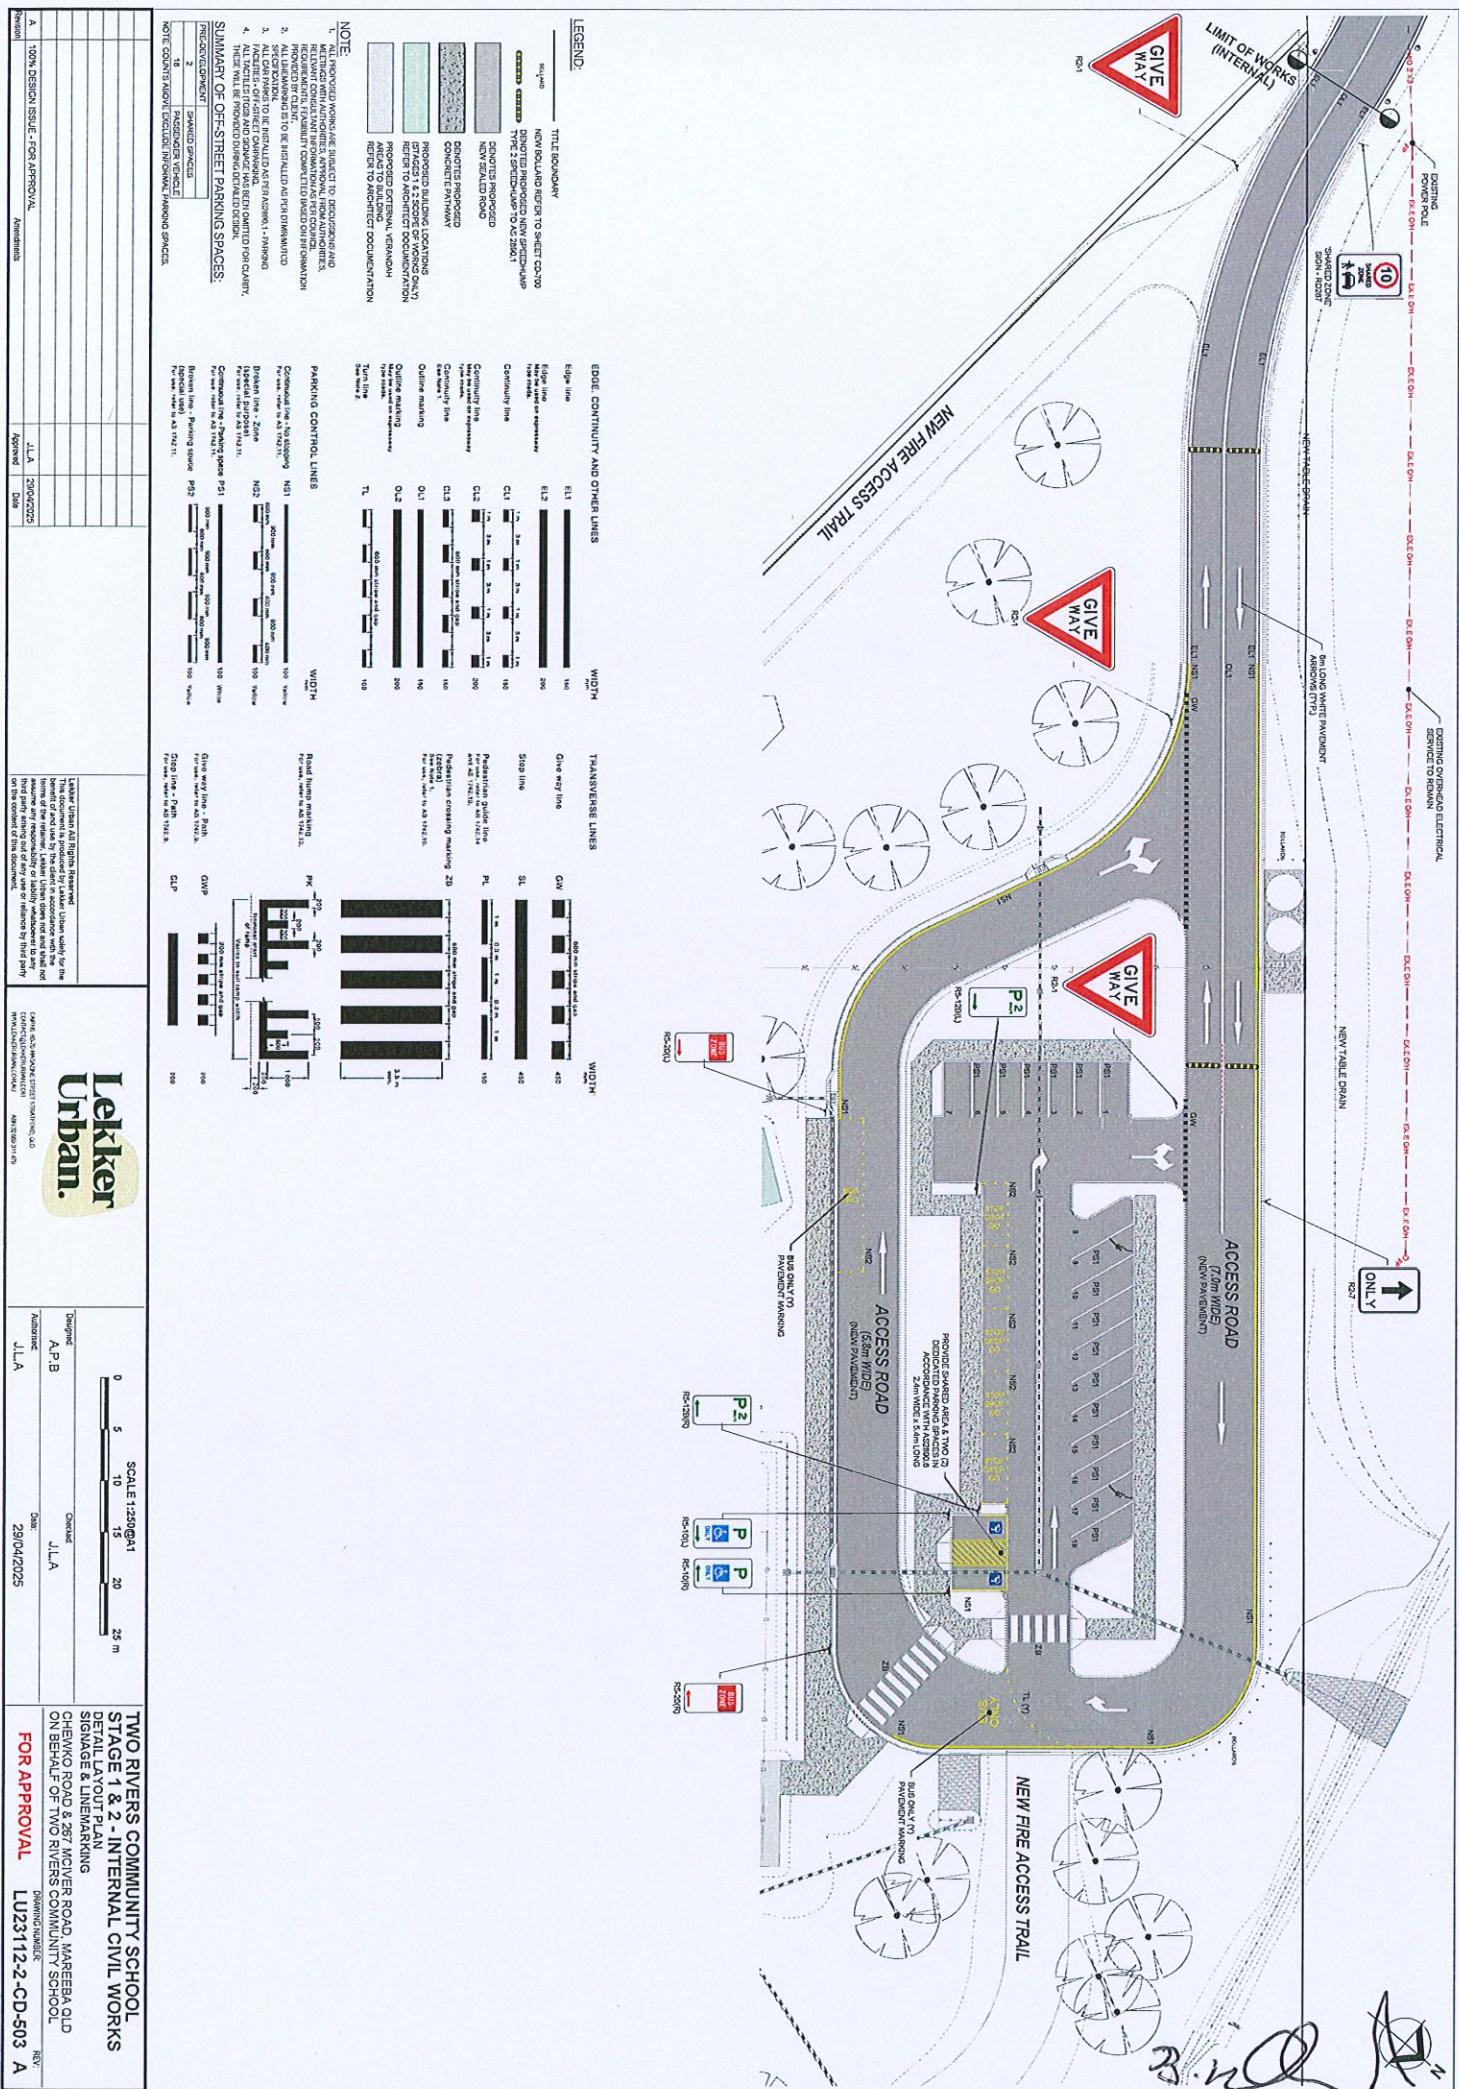




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SP281981
5
SP282140

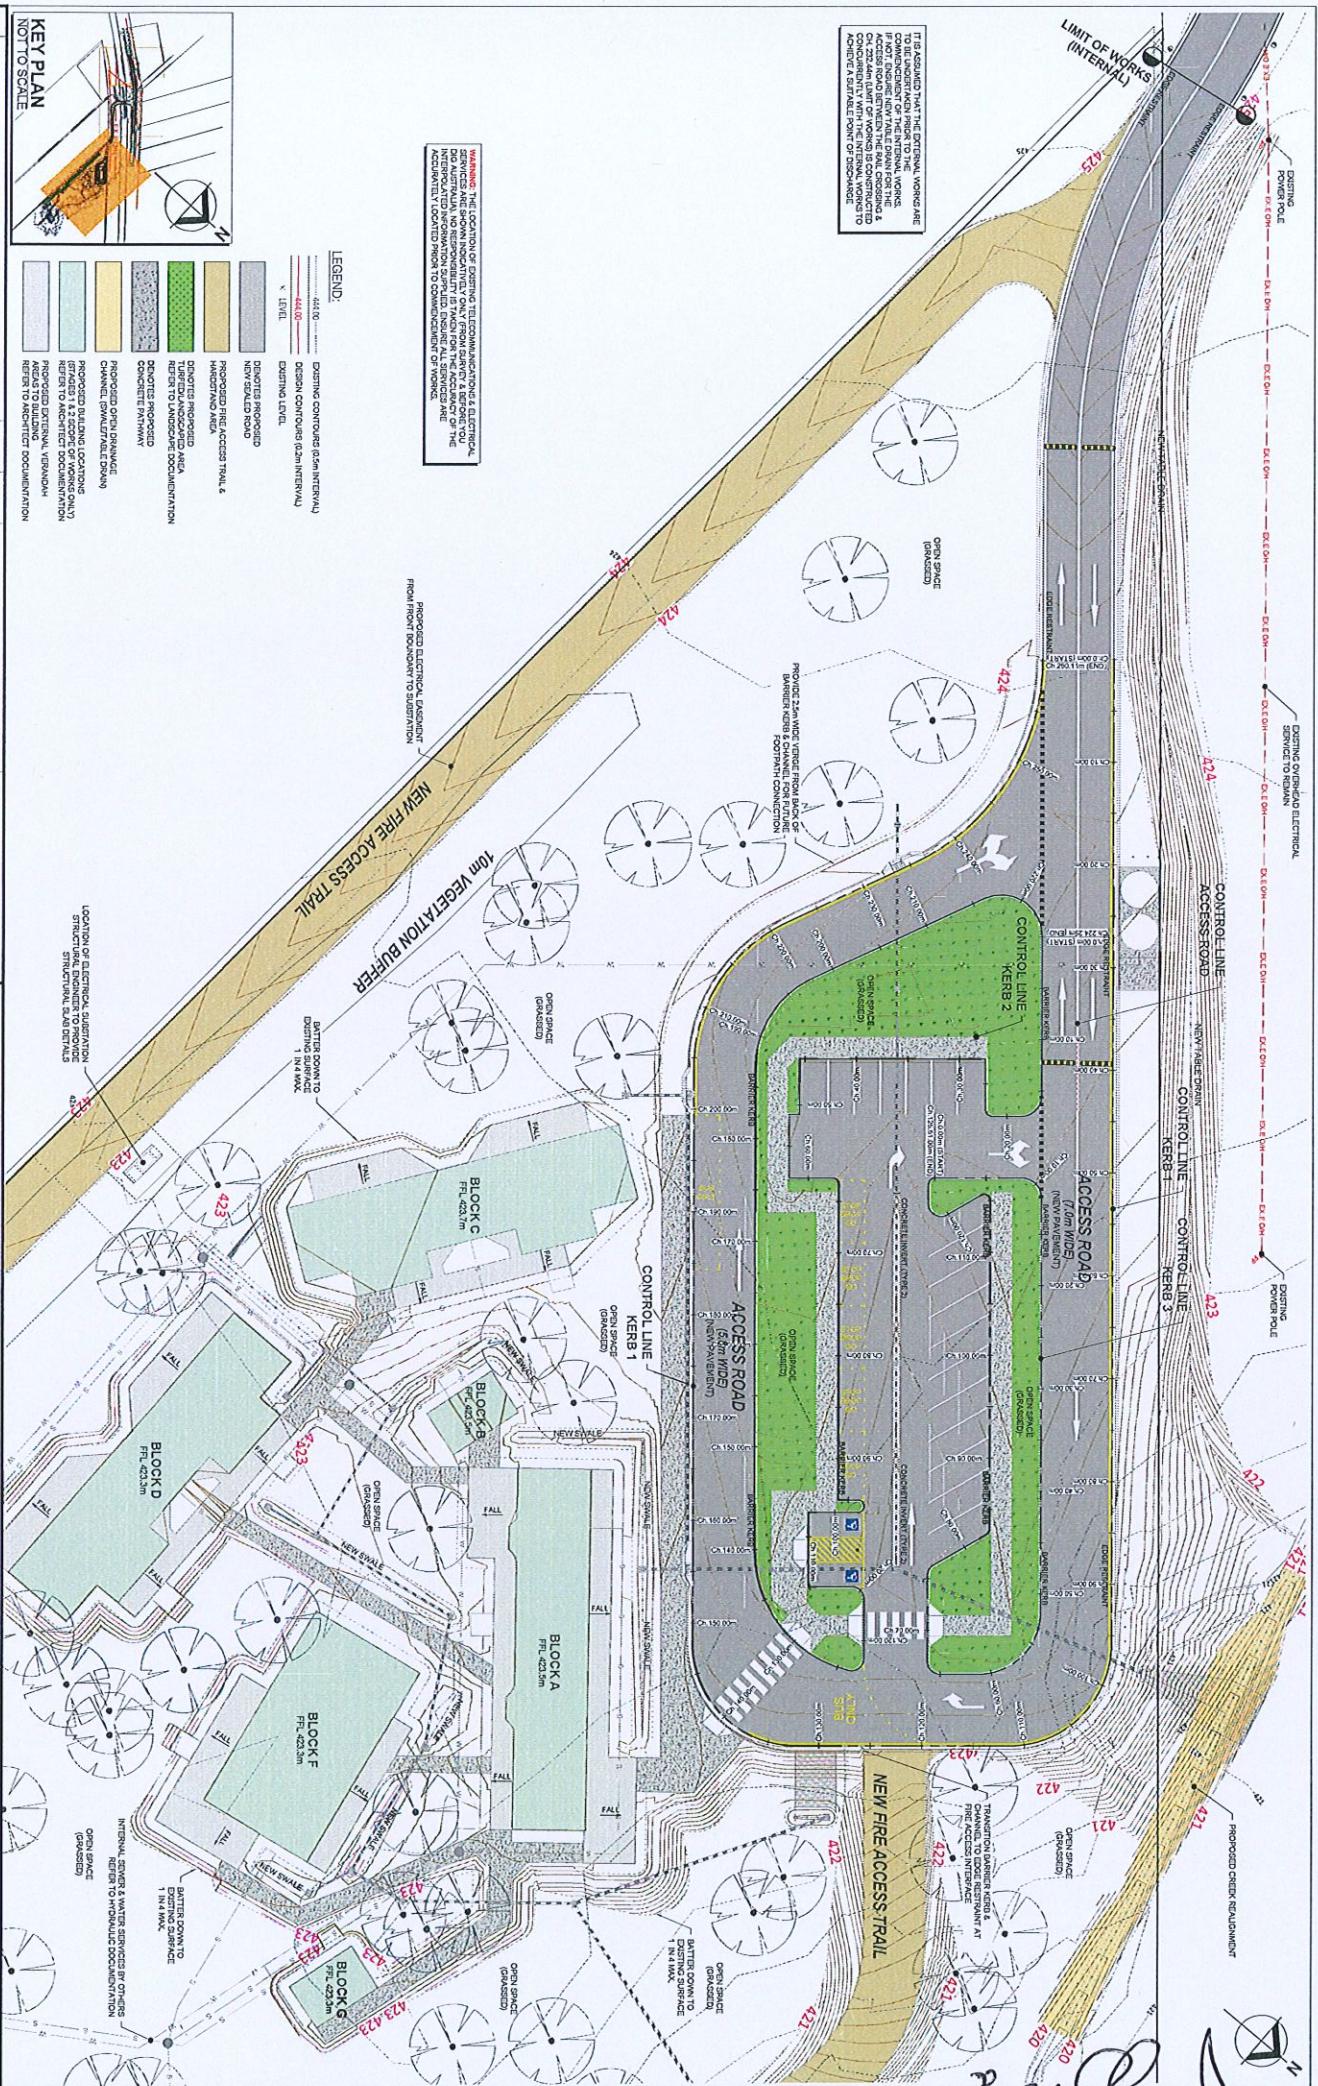CHEWKO ROAD


MUNGANA BRANCH RAILWAY LINE

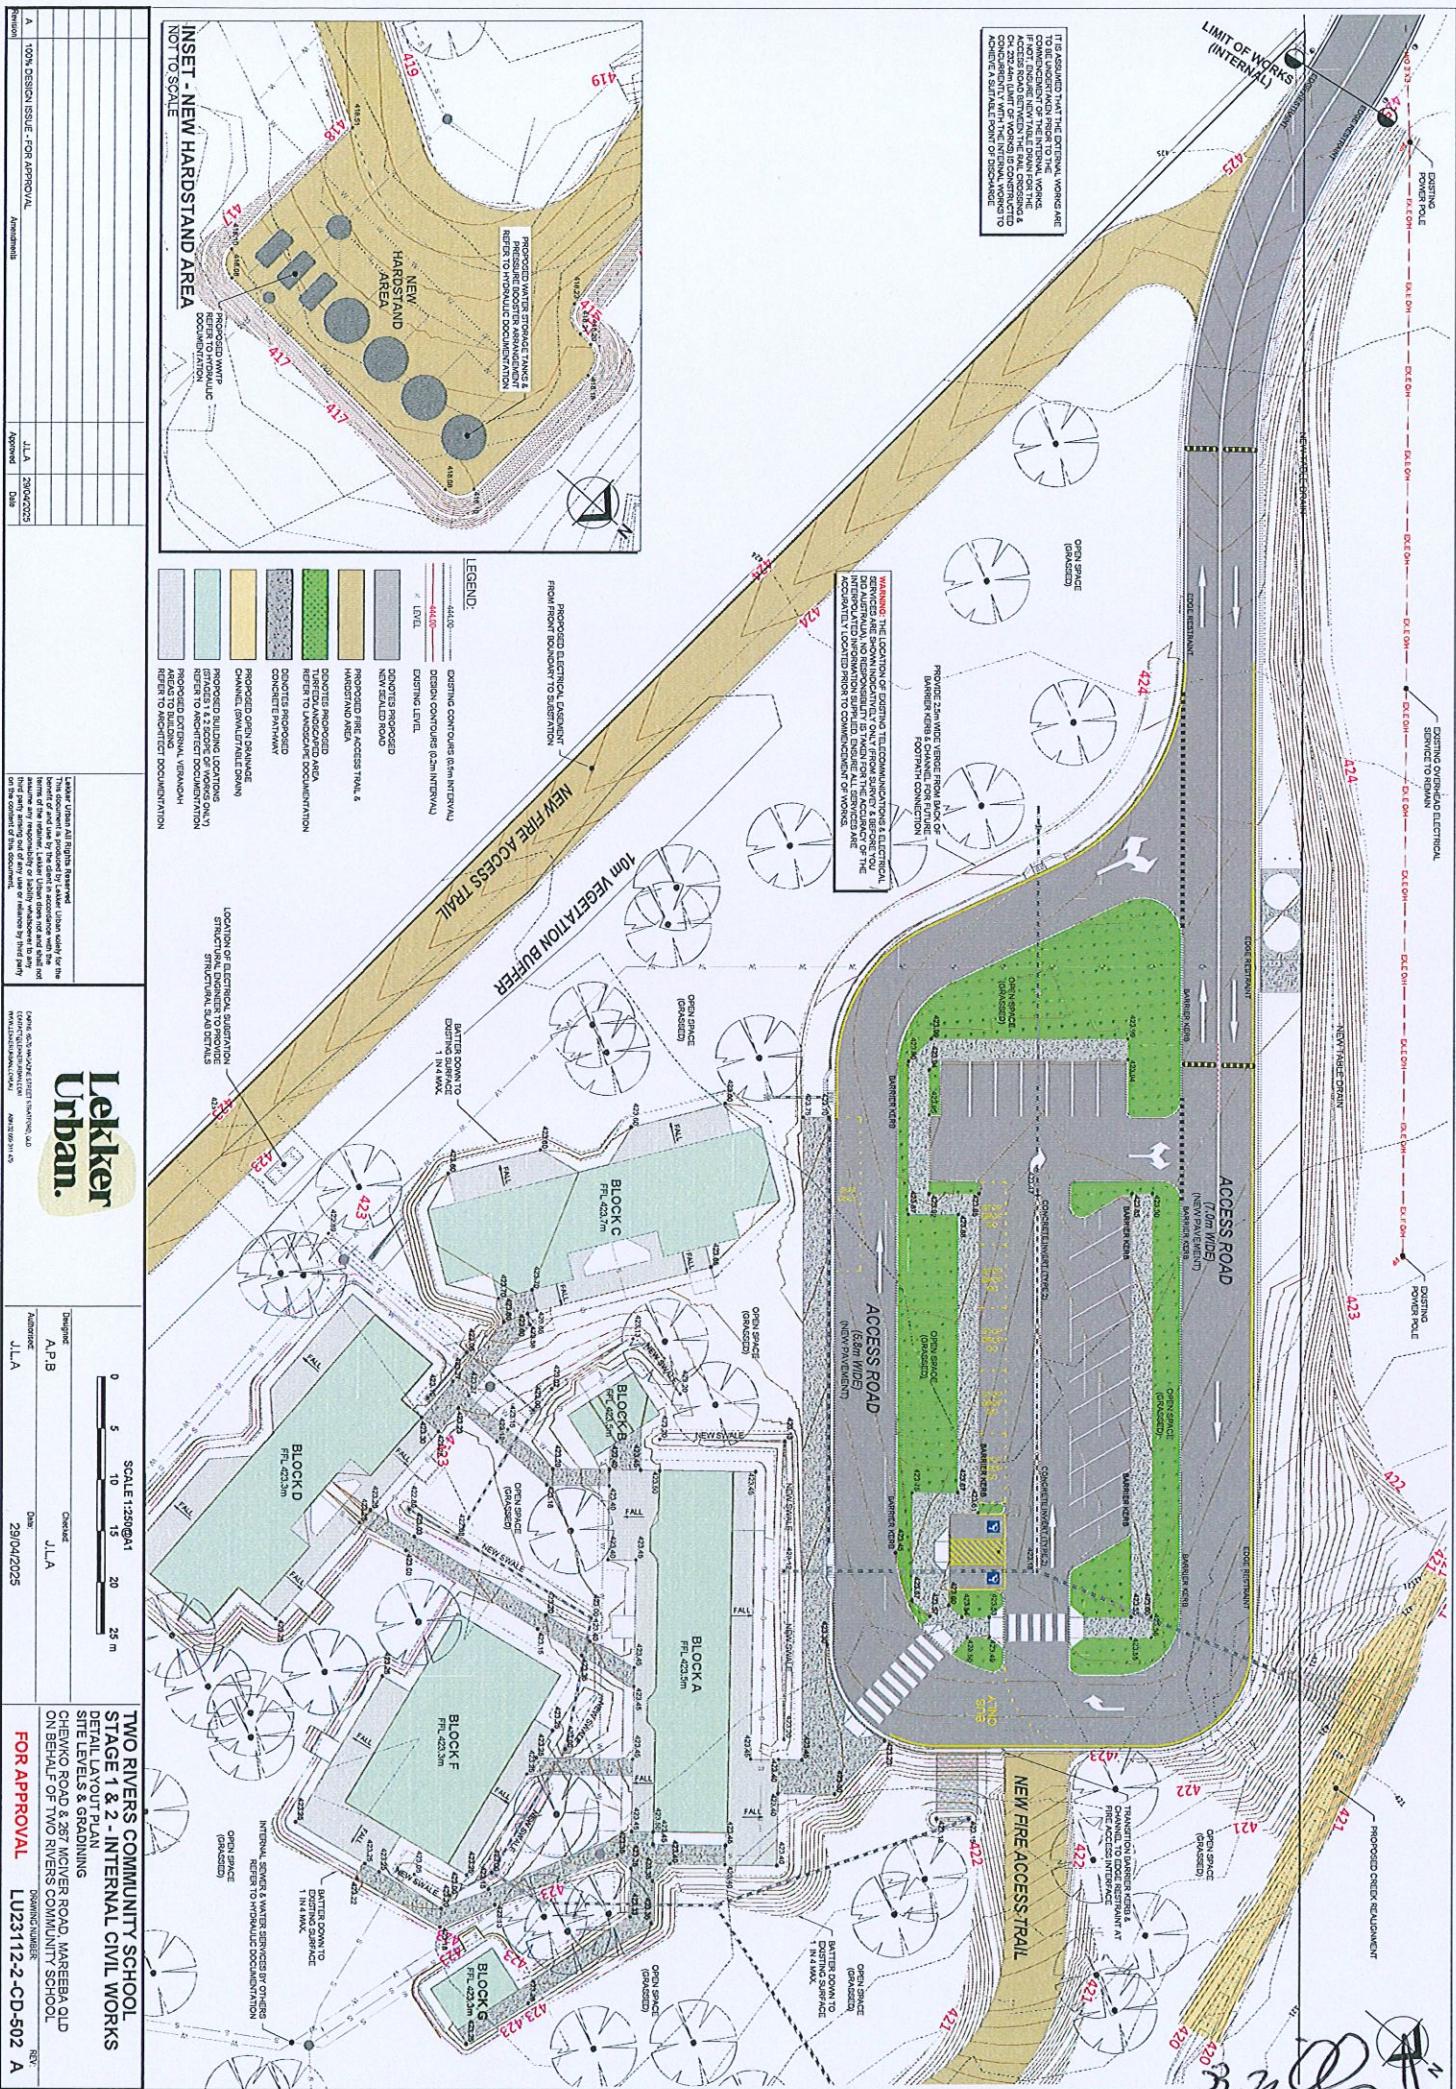PROPOSED CREEK REINFORCEMENT
DISCHARGE INTO SWALE/INTERVAL
STORMWATER POINT OF DEMOLITION TO BE MONITORED
TO PROVIDE FIRE PROTECTION

EXISTING GULLY

71

SP282140

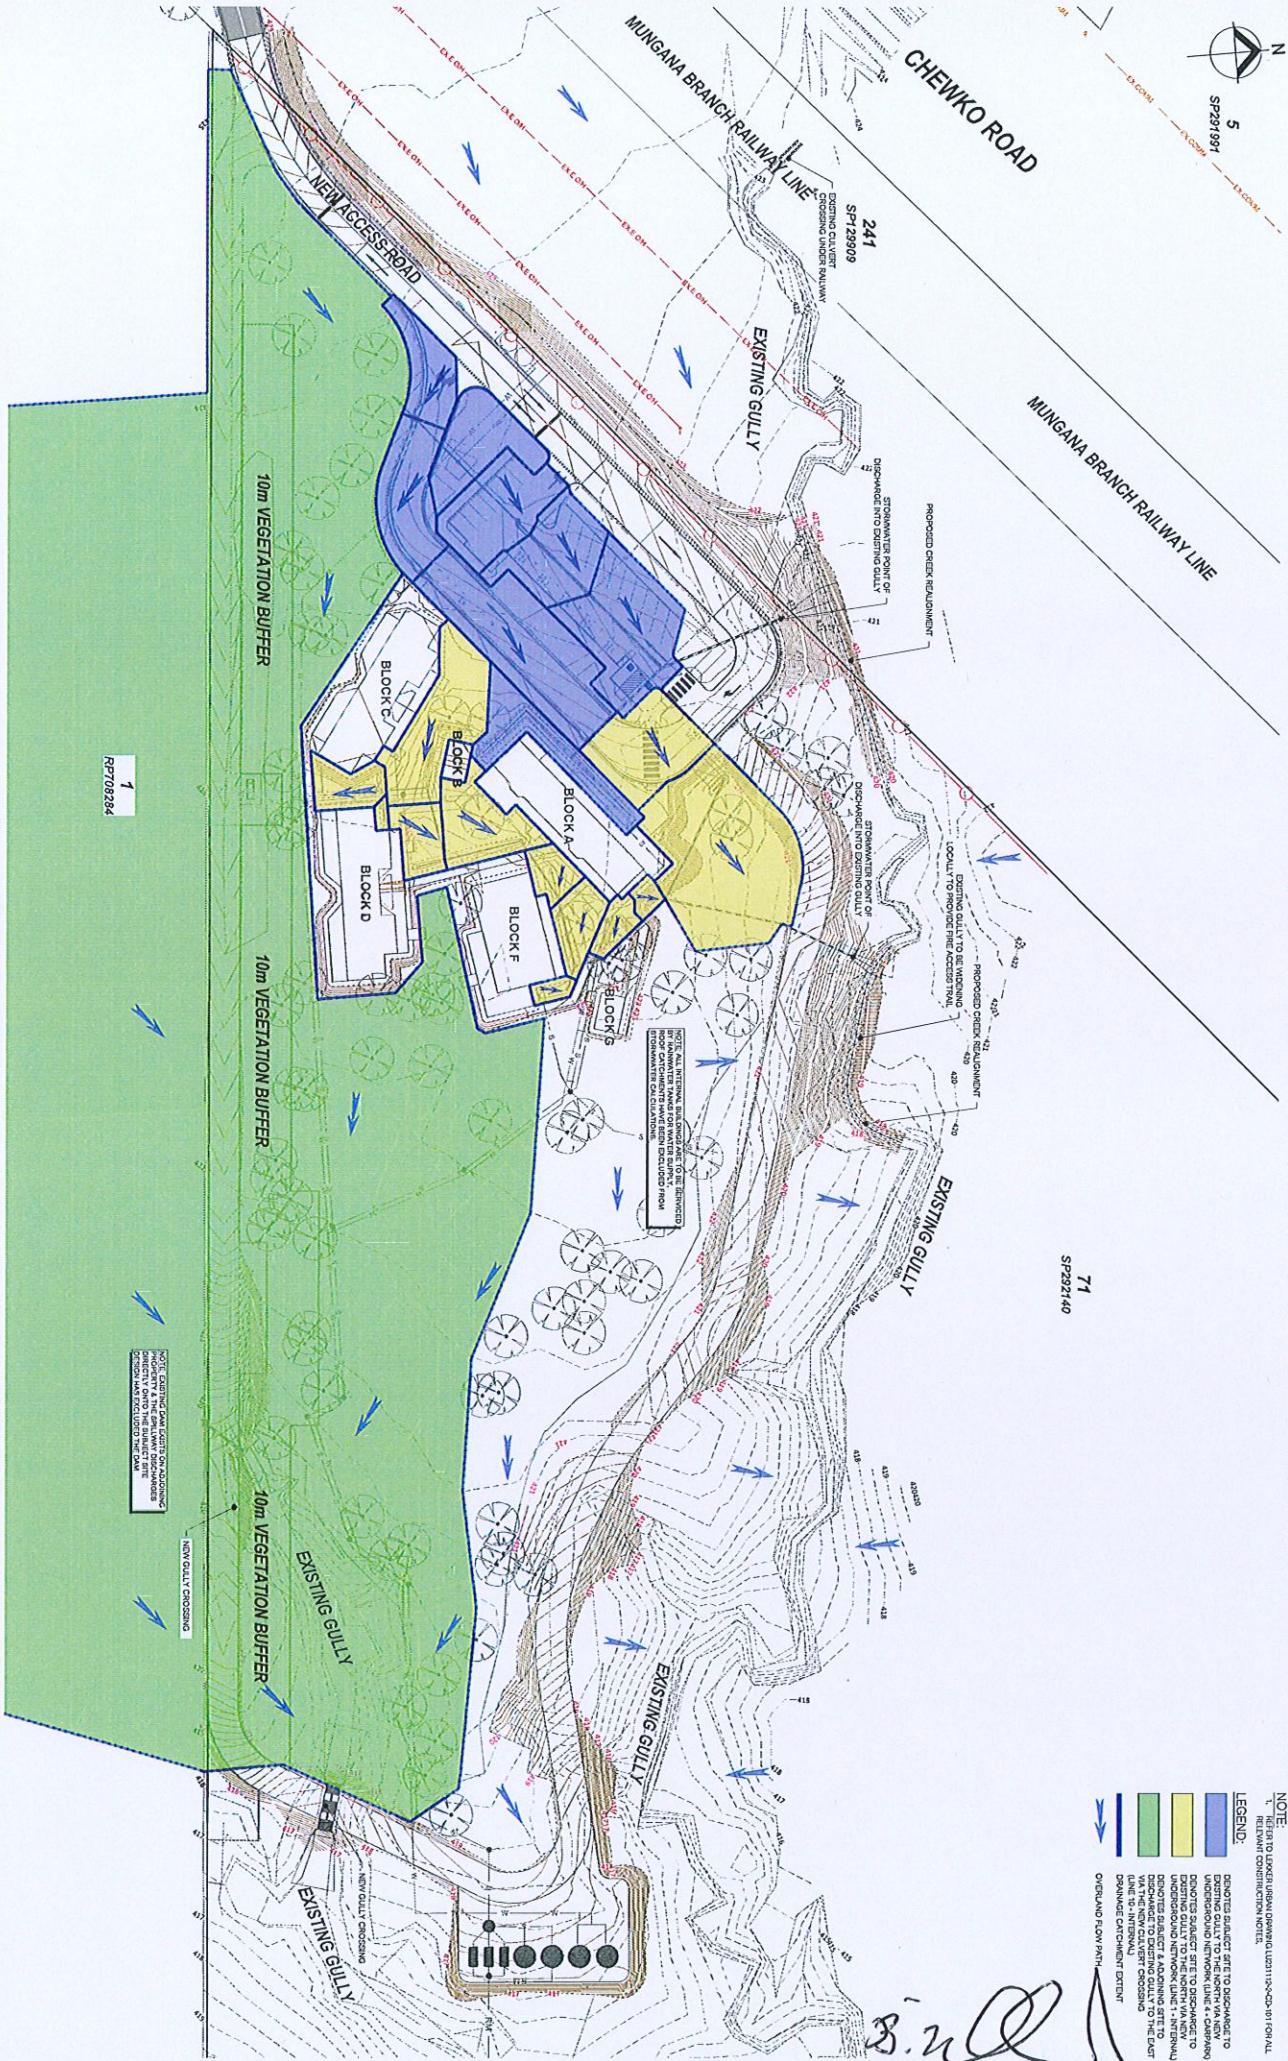

NOTE: REFER TO LOKKER URBAN DRAWING LU23112-CD-501 FOR ALL RELEVANT CONSTRUCTION NOTES.


LEGEND:

- DENOTES SUBJECT SITE TO DISCHARGE TO DRAFFING GULLY TO THE NORTH VIA A NEW UNDERGROUND NETWORK LINE + APPENDIX
- DENOTES SUBJECT SITE TO DISCHARGE TO UNDERGROUND NETWORK LINE + INTERNAL DRAINAGE DITCH & DRAINING SITE TO DRAFFING GULLY TO THE EAST
- LINK TO INTERNAL DRAINAGE DITCH
- DRAINAGE DITCH




OVERLAND FLOW PATH

B.M. Q.D.
21/8/2025

TWO RIVERS COMMUNITY SCHOOL STAGE 1 & 2 - INTERNAL CIVIL WORKS STORMWATER CATCHMENT LAYOUT PLAN (100mm AERIAL EVENT) POST-DEVELOPMENT CHEWKO ROAD & 267 MIVER ROAD, MAREBBA QLD ON BEHALF OF TWO RIVERS COMMUNITY SCHOOL	
REV: 1 DATE: 20/04/2025 APPROVED: J.L.A RELEASER: J.L.A	
A	100% DESIGN ISSUE FOR APPROVAL
Releasor	Releasable
Approved	Date

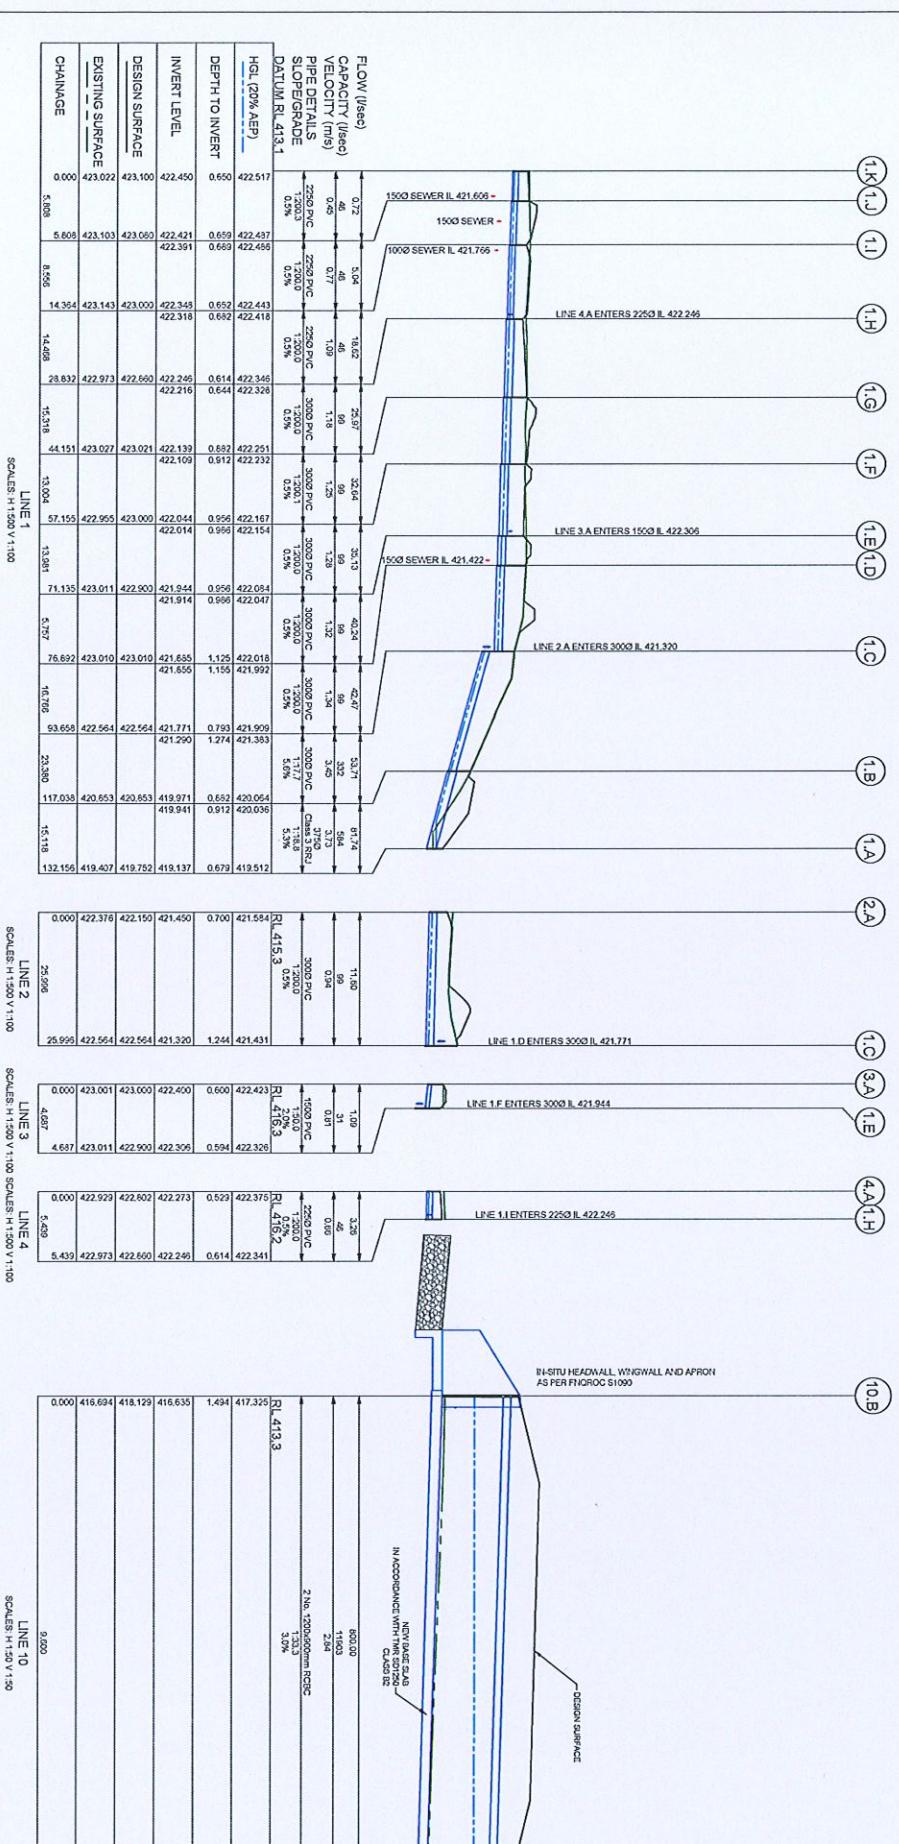

8.2.21
21/8/2025

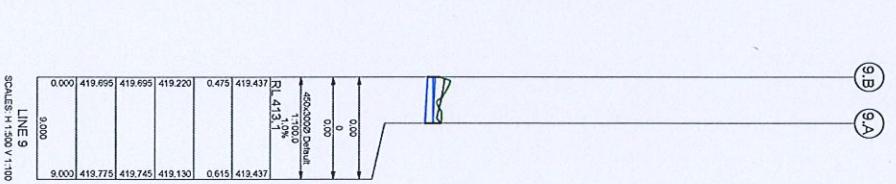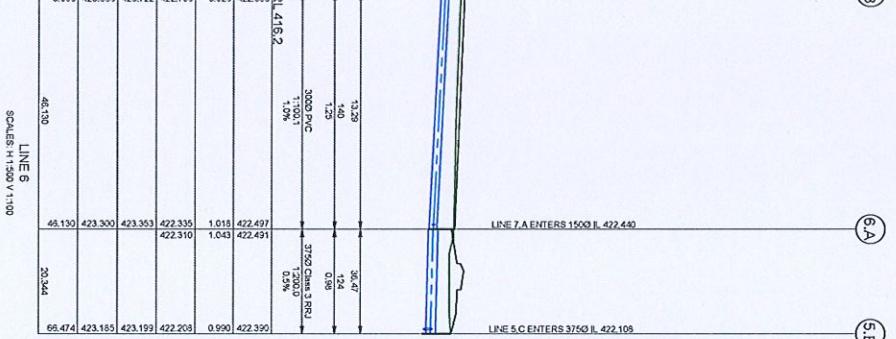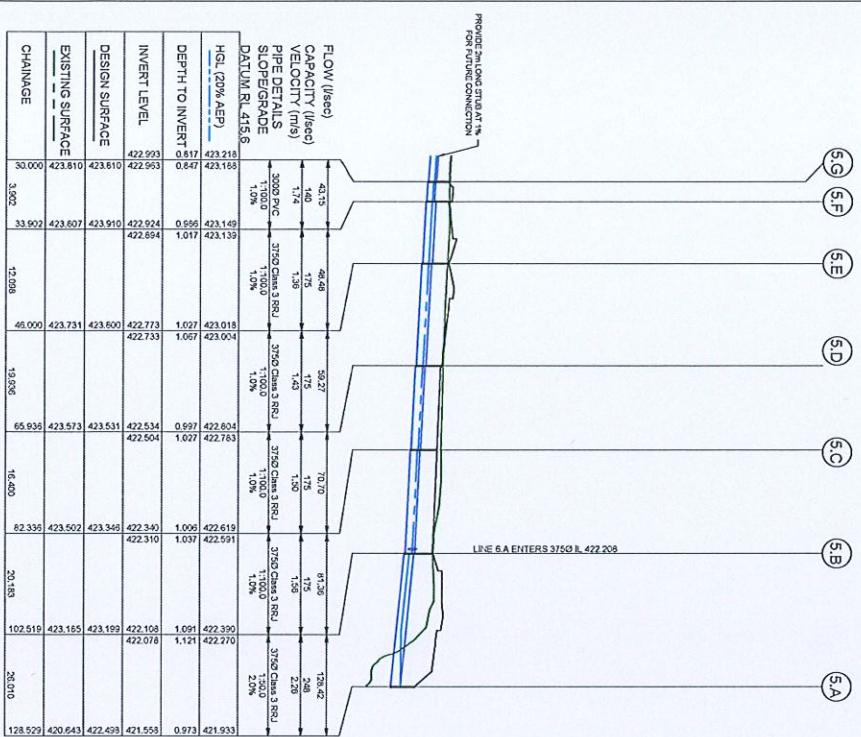

100% DESIGN ISSUE FOR APPROVAL	Approved
Assessor	J.L.A
Date	20/04/2025

Lekker Urban.
LEKKER URBAN CONSULTING ENGINEERS PTY LTD ABN 12 123 456 789 100-102 Boundary Street, Indooroopilly, QLD 4068 Ph: +61 7 3292 1111 Fax: +61 7 3292 1112 Email: info@lekkurban.com.au

FOR APPROVAL	Approved
Approver	J.L.A
Date	29/04/2025












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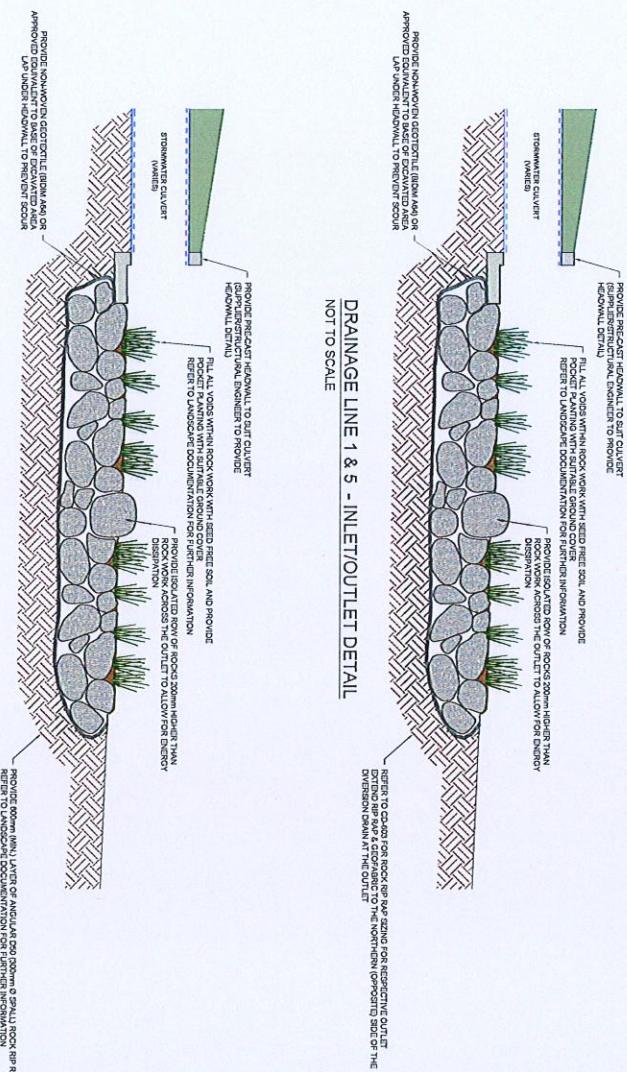
TWO RIVERS COMMUNITY SCHOOL
STAGE 1 & 2 - INTERNAL CIVIL WORKS
DRAINAGE LONGITUDINAL SECTIONS
SHEET 2 OF 2

CHEMWO ROAD & 287 MIVER ROAD, MAREEBA QLD
ON BEHALF OF TWO RIVERS COMMUNITY SCHOOL
DRAWN BY: J.L.A
CHECKED BY: J.L.A
REVIEWED BY: J.L.A

REV: 1


100%



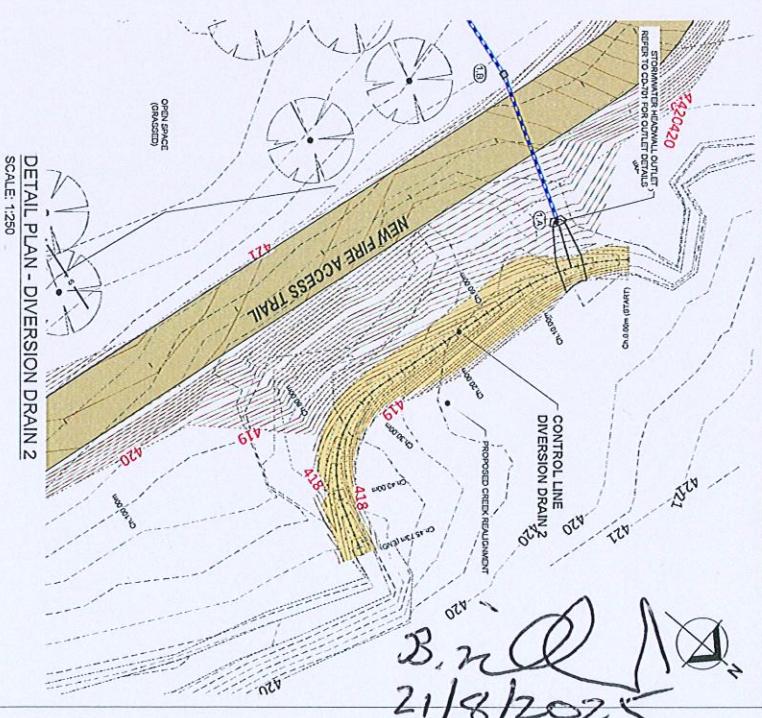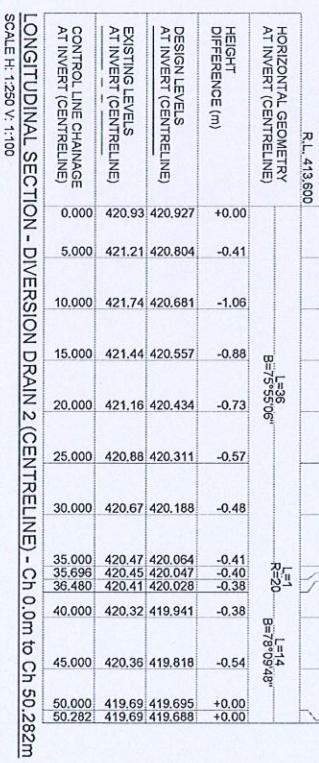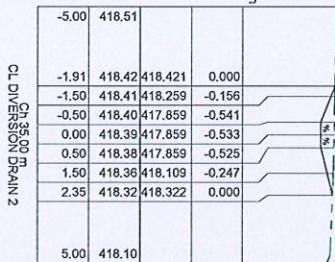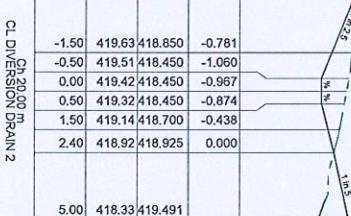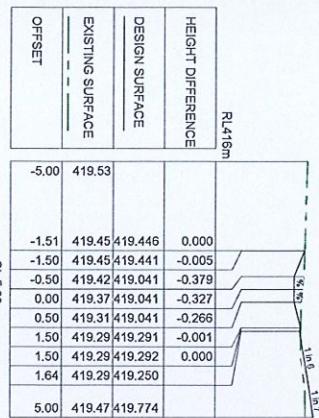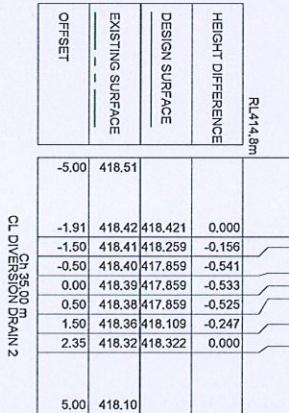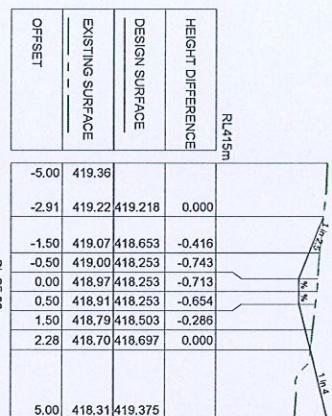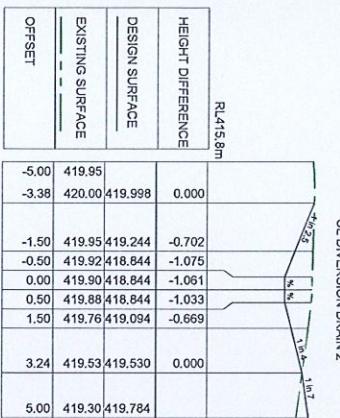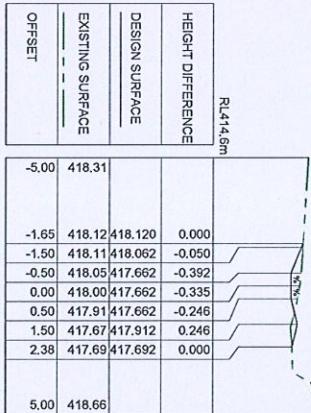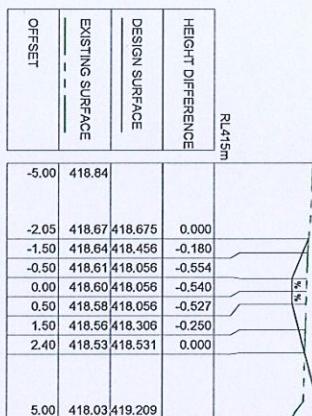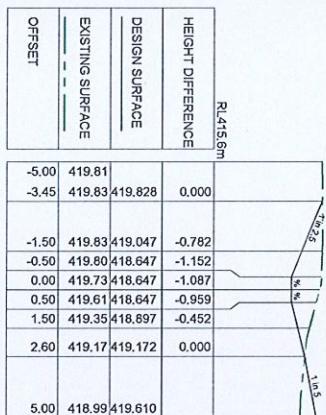

NOT TO SCALE

REINFORCED CONCRETE OR STONE DRAINAGE DITCH OR ALTERNATIVE OUTLET EXTEND RIP RAP OR GYRFAIR TO THE NORTHERN (OPPOSITE) SIDE OF THE DIVERSION DRAIN AT THE OUTLET

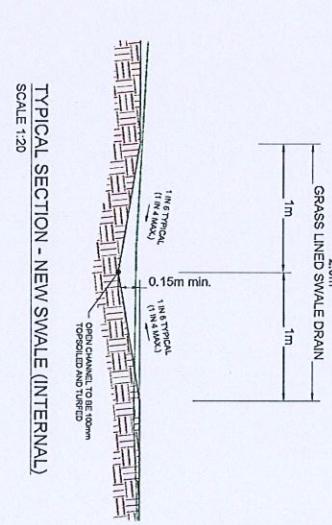

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21/8/2025

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		Designed A.P.B	Checked J.L.A
		Assumed J.L.A	Date 23/04/2025
A Review Approved		Approval Date 23/04/2025	
<p>TWO RIVERS COMMUNITY SCHOOL STAGE 1 & 2 - INTERNAL CIVIL WORKS TYPICAL CONSTRUCTION DETAILS SHEET 2 OF 2 CHEWEE ROAD & 267 MUNIVER ROAD, MAREEBA QLD ON BEHALF OF TWO RIVERS COMMUNITY SCHOOL DESIGNER: Lekker Urban Pty Ltd REV. 00000000000000000000000000000000</p> <p>FOR APPROVAL L123112-2-CD-701 A</p>			