

23 Owens Street Mareeba Q 4880, PO Box 2784 Mareeba Q 4880 Phone: 4092 2449 Mobile: 0419 172 328

Alternative siting request report

DATE: 27/11/24 APPLICANT: Reid Building C/-

Emergent Building Approvals

TO: Mareeba Shire Council NUMBER OF PAGES: 3 (Including cover sheet)

VARIATION FROM BUILDING ASSESSMENT PROVISION:

The OMP to the fascia of the duplex will be setback 3.9m from the front boundary.

Please note the development application complies with the relevant assessment benchmarks of the planning scheme.

ADDRESS: 48 Atherton Street Mareeba QLD 4880 **REAL PROPERTY DESCRIPTION:** Lot: 1 RP: 700513

REFERENCE DOCUMENTATION DWG NUMBER: Plans Job No. 24009

BACKGROUND:

The client seeks Council's consent to construct a Duplex within the front road boundary 6m setback as prescribed under the QDC MP1.2. This will be Stage 1 with the potential to build a second Duplex adjacent to the east. The siting of the duplex is constrained by the exiting sewer which truncates the property from the west and exits to the northern road boundary frontage. Previous discussion and subsequent Building Adjacent to Sewer application has been lodged with Councils Wastewater department. The duplex has been pushed as close as permissible to the sewer at the rear.

The plans don't indicate the existing building pad also has significant fall from fill edge which starts approximately 5m from the eastern side boundary which constrains the location of the second duplex into the future.


The following report will demonstrate how the proposed encroachment will have minimal impact on adjoining development. Due to the non-compliance/s nominated above the applicant hereby requests Council as the nominated Concurrence Agency under the Planning Regulation 2017, Schedule 9, Division 2 Table 3 to conduct an assessment against the relevant performance criteria of the Queensland Development Code MP 1.2 in accordance with Section 30 of the Building Act 1975.

QDC MP 1.2 -Performance Criteria- P1

The location of a building or structure facilitates an acceptable streetscape, appropriate for -

a) the bulk of the building or structure; and

The bulk of the duplex will be reduced to the road as the building pad is located some 1.2m below the height of the foot path. Elevation 3 of the plans for Duplex 1 will be mirror reversed with the gable end being closest to the western side boundary and less visible from the street and reducing its bulk.

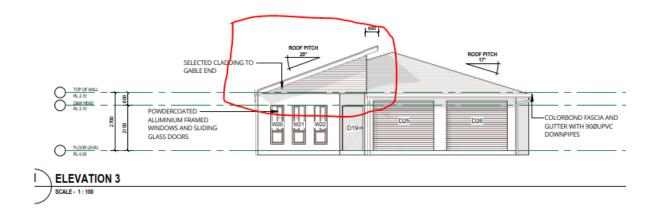

b) the road boundary setbacks of neighbouring buildings or structures; and

The average front boundary setback of adjoining Dwellings along Atherton Street appears to be approximately 4.5m on similar size allotments. The proposed design will be in keeping with the aggregate bulk/scale presented within the 6m setback along the street scape.



c) the outlook and views of neighbouring residents; and

Being located below the height of the road and with the predominant views from No.46 is to the North and is also screened by the existing shed built close to the adjoining side boundary.

d) nuisance and safety to the public.

The duplex will be provided to two covered car spaces along with two other visitor parks within the boundary giving ample on-site parking. In addition the current road configuration has on-street carparking giving ample road width for existing and entering vehicles.

Summary:

In conclusion, the above sections address the respective elements of the performance criteria which supports the endorsement of the proposal.

If you require any further clarification regarding any aspect of this submission, please don't hesitate to contact Glenn Chambers on 4092 2449 or glenn@emergnentba.com.au.

Kind Regards,



Glenn Chambers
Building Certifier Level 1 B.Bldg.Surv, RICS A80178



Our reference:

24000286

Your reference:

27 Nov 2024

Reid Building 8 Powell Road Mareeba QLD 4880 irwinreid@westnet.com.au

Attention:

Sir/Madam

Confirmation notice

This notice is to advise the applicant of the requirement to refer this application to the relevant Local Government in accordance with the DA Rules Section 2.

The development application described below was properly made to the Mareeba Shire Council on 29 Oct 2024

Applicant details

Applicant name: Reid Building

Applicant contact details: irwinreid@westnet.com.au, 0408 965 396

Location details

Street address: 48 Atherton Street, Mareeba 4880

Real property description: Lot 1 RP700513

Local government area: Mareeba Shire Council

Application details

Application number: 24000286

Approval sought: Preliminary Approval for building work assessable against the Planning

Scheme or Concurrence Agency Response

Nature of development

proposed:

New Construction

Description of the

development proposed:

of Duplex (Class 1a)

Public notification details

Part 4 of the Development Assessment Rules is not applicable to this development application.

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Referral details

Part 2 of the Development Assessment Rules is applicable to the development application.

The development application must be referred to all relevant referral agency(s) within 10 business days starting the day after receiving this notice, or a further period agreed with the assessment manager; otherwise the application will lapse under section 31 of the Development Assessment Rules.

The development application must be referred to the following referral agencies:

Mareeba Shire Council	Schedule 9, Table 3- Design and siting- Column 2-

For further information please contact Glenn Chambers, Managing Director, on 07 4092 2449 or via email glenn@emergentba.com.au who will be pleased to assist.

Yours sincerely

8.

Glenn Chambers Managing Director

DA Form 1 – Development application details

Approved form (version 1.4 effective 15 December 2023) made under section 282 of the Planning Act 2016.

This form **must** be used to make a development application **involving code assessment or impact assessment**, except when applying for development involving only building work.

For a development application involving **building work only**, use *DA Form 2 – Building work details*.

For a development application involving **building work associated with any other type of assessable development** (i.e. material change of use, operational work or reconfiguring a lot), use this form (*DA Form 1*) and parts 4 to 6 of *DA Form 2 – Building work details*.

Unless stated otherwise, all parts of this form **must** be completed in full and all required supporting information **must** accompany the development application.

One or more additional pages may be attached as a schedule to this development application if there is insufficient space on the form to include all the necessary information.

This form and any other form relevant to the development application must be used to make a development application relating to strategic port land and Brisbane core port land under the *Transport Infrastructure Act 1994*, and airport land under the *Airport Assets (Restructuring and Disposal) Act 2008*. For the purpose of assessing a development application relating to strategic port land and Brisbane core port land, any reference to a planning scheme is taken to mean a land use plan for the strategic port land, Brisbane port land use plan for Brisbane core port land, or a land use plan for airport land.

Note: All terms used in this form have the meaning given under the Planning Act 2016, the Planning Regulation 2017, or the Development Assessment Rules (DA Rules).

PART 1 - APPLICANT DETAILS

1) Applicant details	
Applicant name(s) (individual or company full name)	J & C Gostelow Superannuation Fund Pty Ltd TTE J & C Superannuation Fund C/- Emergent Building Approvals
Contact name (only applicable for companies)	
Postal address (P.O. Box or street address)	PO Box 2784
Suburb	Mareeba
State	Q
Postcode	4880
Country	
Contact number	40922449
Email address (non-mandatory)	carmel@emergentba.com.au
Mobile number (non-mandatory)	
Fax number (non-mandatory)	
Applicant's reference number(s) (if applicable)	

2) Owner's consent
2.1) Is written consent of the owner required for this development application?
☐ Yes – the written consent of the owner(s) is attached to this development application☐ No – proceed to 3)



PART 2 - LOCATION DETAILS

3) Location of the premises (complete 3.1) or 3.2), and 3.3) as applicable) Note: Provide details below and attach a site plan for any or all premises part of the development application. For further information, see <u>DA</u>									
Forms Guide: Relevant plans.									
3.1) Street address and lot on plan ⊠ Street address AND lot on plan (all lots must be listed), or									
Street address AND lot on plan for an adjoining or adjacent property of the premises (appropriate for development in water but adjoining or adjacent to land e.g. jetty, pontoon. All lots must be listed).									
	Unit No.	Stree	t No.	Stree	et Name and	Туре			Suburb
۵)		48		Athe	rton Street				Mareeba
a)	Postcode	Lot N	lo.	Plan	Type and No	umber ((e.g. Ri	P, SP)	Local Government Area(s)
	4880	1		RP70	00513				Mareeba Shire Council
	Unit No.	Stree	t No.	Stree	et Name and	Туре			Suburb
L- \									
b)	Postcode	Lot N	lo.	Plan	Type and N	umber ((e.g. RI	P, SP)	Local Government Area(s)
	oordinates o				e for developme	ent in rem	note area	as, over part of a	a lot or in water not adjoining or adjacent to land
	g. criannei dred lace each set o				e row.				
☐ Co	ordinates of	premis	es by lon	ngitud	le and latitud	le			
Longit	ude(s)		Latitude	e(s)		Datur	n		Local Government Area(s) (if applicable)
						□w	GS84		
						☐ G	DA94		
						☐ Ot	her:		
☐ Co	ordinates of	premis	es by ea	sting	and northing)			
Eastin	g(s)	North	ning(s)		Zone Ref.	Datur	n		Local Government Area(s) (if applicable)
					☐ 54		GS84		
					<u> </u>	_	DA94 _.		
					□ 56	│	her:		
3.3) A	dditional pre	mises							
								on and the d	letails of these premises have been
	acned in a so t required	chedule	e to this d	develo	opment appli	cation			
	required								
4) Ider	ntify any of th	ne follo	wing that	t appl	v to the pren	nises a	nd pro	vide any rele	evant details
					tercourse or				
	-		-						
Name of water body, watercourse or aquifer: On strategic port land under the <i>Transport Infrastructure Act 1994</i>									
	plan descrip								
	of port author		•	,,,,,,					
	a tidal area	, 13							
_		ernmer	nt for the	tidal :	area (if applica	able).			
	_								
Name of port authority for tidal area (if applicable): On airport land under the Airport Assets (Restructuring and Disposal) Act 2008									
Name of airport:									

Listed on the Environmental Management Register (EMR) under the Environmental Protection Act 1994				
EMR site identification:				
Listed on the Contaminated Land Register (CLR) unde	r the Environmental Protection Act 1994			
CLR site identification:				
5) Are there any existing easements over the premises? Note: Easement uses vary throughout Queensland and are to be identified correctly and accurately. For further information on easements and how they may affect the proposed development, see <u>DA Forms Guide</u> .				
 ☐ Yes – All easement locations, types and dimensions are included in plans submitted with this development application ☒ No 				

PART 3 – DEVELOPMENT DETAILS

Section 1 – Aspects of development

6.1) Provide details about the	first development aspect						
a) What is the type of development? (tick only one box)							
	Reconfiguring a lot	Operational work	☐ Building work				
b) What is the approval type?	(tick only one box)						
□ Development permit	☐ Preliminary approval	☐ Preliminary approval that	includes a variation approval				
c) What is the level of assessr	ment?						
☐ Code assessment	☐ Impact assessment (require	es public notification)					
d) Provide a brief description of lots):	of the proposal (e.g. 6 unit apartr	ment building defined as multi-unit dw	relling, reconfiguration of 1 lot into 3				
Duplex							
e) Relevant plans Note: Relevant plans are required to Relevant plans.	be submitted for all aspects of this o	levelopment application. For further in	nformation, see <u>DA Forms guide:</u>				
⊠ Relevant plans of the prop	osed development are attach	ed to the development applica	ation				
6.2) Provide details about the	second development aspect						
a) What is the type of develop	ment? (tick only one box)						
☐ Material change of use	Reconfiguring a lot	Operational work	Building work				
b) What is the approval type?	(tick only one box)						
□ Development permit	☐ Preliminary approval	☐ Preliminary approval that	includes a variation approval				
c) What is the level of assessr	ment?						
☐ Code assessment	☐ Impact assessment (require	es public notification)					
d) Provide a brief description of lots):	of the proposal (e.g. 6 unit aparti	ment building defined as multi-unit dw	relling, reconfiguration of 1 lot into 3				
e) Relevant plans Note: Relevant plans are required to be submitted for all aspects of this development application. For further information, see <u>DA Forms Guide:</u> Relevant plans.							
Relevant plans of the proposed development are attached to the development application							
6.3) Additional aspects of development							
		levelopment application and the manual transfer to this					

Section 2 - Further development details

- Cotton 2 Turtifor developi	noni dotana						
7) Does the proposed developm	ent application inv	olve any of the follow	ing?				
Material change of use	☐ Yes – complete division 1 if assessable against a local planning instrument						
Reconfiguring a lot	Yes – complete division 2						
Operational work	☐ Yes – complete division 3						
Building work	☐ Yes – complet	e DA Form 2 – Buildir	ng work deta	ails			
D							
Division 1 – Material change of Note: This division is only required to be co		the development application	an involvoo o n	notorial change of use o	accachla against s		
local planning instrument.	ompleted if any part of	тте иечеторттетт аррпсато	on involves a n	laterial Criange of use as	sessable against a		
8.1) Describe the proposed mate	erial change of us	е					
Provide a general description of proposed use		the planning scheme ach definition in a new row,		Number of dwelling units (if applicable)	g Gross floor area (m²) (if applicable)		
Duplex				2 (attached)	284		
8.2) Does the proposed use invo	olve the use of exi	sting buildings on the	premises?				
Yes							
⊠ No							
Division 2 – Reconfiguring a lot		the development emplication	an involves res	anfiguring a lat			
Note: This division is only required to be co 9.1) What is the total number of			on involves rec	oringuring a lot.			
	3	5 1 1					
9.2) What is the nature of the lot	reconfiguration?	(tick all applicable boxes)					
Subdivision (complete 10))	-	☐ Dividing land in	nto parts by	agreement (complete	÷ 11))		
☐ Boundary realignment (comple	ete 12))		Creating or changing an easement giving access to a lot				
		from a construc	cted road (co	omplete 13))			
40) Oal Hairin							
10) Subdivision							
10.1) For this development, how	-						
Intended use of lots created	Residential	Commercial	Industrial	Other, plea	ase specify:		
Number of lots created							
10.2) Will the subdivision be started and Yes – provide additional detarted No							
How many stages will the works	include?						
What stage(s) will this developm apply to?							

11) Dividing land int parts?	o parts by	agreement – ho	w many parl	ts are being o	created and what	is the intended use of the	
Intended use of par	ed use of parts created Residential Co		Com	mercial	Industrial	Other, please specify:	
Number of parts cre	eated						
7.1					I		
12) Boundary realig	nment						
12.1) What are the		•	s for each lo	t comprising	•		
	Currer					osed lot	
Lot on plan descrip	tion	Area (m²)		Lot on plan	description	Area (m²)	
12.2) What is the re	acon for t	ho houndary roal	ianmont?				
12.2) What is the re	ason ior i	ne boundary rear	igninent?				
13) What are the di			y existing ea	asements bei	ing changed and/	or any proposed easement?	
Existing or proposed?	Width (m		Purpose of pedestrian a	of the easeme	ent? (e.g.	Identify the land/lot(s) benefitted by the easement	
Division 2 Operati	المصيد لمصما	l.					
Division 3 – Operati <i>Note: This division is only i</i>			art of the develo	opment applicati	ion involves operation	nal work.	
14.1) What is the na							
☐ Road work			Stormwate	er	☐ Water inf	rastructure	
☐ Drainage work			☐ Earthwork			infrastructure	
Landscaping		L	Signage		☐ Clearing	vegetation	
Other – please s	•		114 4 41	<i>v</i> : 6	1.1.0		
14.2) Is the operation		·	litate the cre	eation of new	IOIS? (e.g. subdivis	ion)	
Yes – specify nu	imber of n	iew iots:					
☐ No	t	alua af tha muana	and amountin	mal wards? "			
14.3) What is the m	onetary va	alue of the propos	sed operation	onai work? (in	iciude GST, materiais	and labour)	
Ψ							
PART 4 – ASSI	ESSME	ENT MANAG	ER DET	AILS			
15) Identify the ass	ocemont n	nanagar(s) who y	vill bo accas	sing this dov	olonmont applica	tion	
15) Identify the assessment manager(s) who will be assessing this development application Emergent Building Approvals							
16) Has the local government agreed to apply a superseded planning scheme for this development application?							
	Yes – a copy of the decision notice is attached to this development application						
☐ The local govern				•	• •	equest – relevant documents	
attached ⊠ No							

PART 5 – REFERRAL DETAILS

17) Does this development application include any aspects that have any referral requirements? Note: A development application will require referral if prescribed by the Planning Regulation 2017.
No, there are no referral requirements relevant to any development aspects identified in this development application − proceed to Part 6
Matters requiring referral to the Chief Executive of the Planning Act 2016:
☐ Clearing native vegetation
Contaminated land (unexploded ordnance)
☐ Environmentally relevant activities (ERA) (only if the ERA has not been devolved to a local government)
Fisheries – aquaculture
Fisheries – declared fish habitat area
☐ Fisheries – marine plants
Fisheries – waterway barrier works
☐ Hazardous chemical facilities
☐ Heritage places – Queensland heritage place (on or near a Queensland heritage place)
☐ Infrastructure-related referrals – designated premises
☐ Infrastructure-related referrals – state transport infrastructure
☐ Infrastructure-related referrals – State transport corridor and future State transport corridor
☐ Infrastructure-related referrals – State-controlled transport tunnels and future state-controlled transport tunnels
☐ Infrastructure-related referrals – near a state-controlled road intersection
☐ Koala habitat in SEQ region – interfering with koala habitat in koala habitat areas outside koala priority areas
☐ Koala habitat in SEQ region – key resource areas
☐ Ports – Brisbane core port land – near a State transport corridor or future State transport corridor
☐ Ports – Brisbane core port land – environmentally relevant activity (ERA)
☐ Ports – Brisbane core port land – tidal works or work in a coastal management district
☐ Ports – Brisbane core port land – hazardous chemical facility
☐ Ports – Brisbane core port land – taking or interfering with water
☐ Ports – Brisbane core port land – referable dams
☐ Ports – Brisbane core port land – fisheries
Ports – Land within Port of Brisbane's port limits (below high-water mark)
☐ SEQ development area
SEQ regional landscape and rural production area or SEQ rural living area – tourist activity or sport and recreation activity
☐ SEQ regional landscape and rural production area or SEQ rural living area – community activity
SEQ regional landscape and rural production area or SEQ rural living area – community activity
SEQ regional landscape and rural production area or SEQ rural living area – indoor recreation SEQ regional landscape and rural production area or SEQ rural living area – urban activity
SEQ regional landscape and rural production area or SEQ rural living area – combined use
SEQ northern inter-urban break – tourist activity or sport and recreation activity
SEQ northern inter-urban break – community activity
SEQ northern inter-urban break – community activity
☐ SEQ northern inter-urban break – urban activity☐ SEQ northern inter-urban break – combined use
☐ Tidal works or works in a coastal management district
Reconfiguring a lot in a coastal management district or for a canal
☐ Erosion prone area in a coastal management district
Urban design
☐ Water-related development – taking or interfering with water
Water-related development – removing quarry material (from a watercourse or lake)
Water-related development – referable dams
Water-related development –levees (category 3 levees only)
☐ Wetland protection area

Matters requiring referral to the local government:						
Airport land						
 Environmentally relevant activities (ERA) (only if the ERA has been devolved to local government) Heritage places – Local heritage places 						
Matters requiring referral to the Chief Executive of the di	stribution entity or transmis	ssion entity:				
☐ Infrastructure-related referrals – Electricity infrastructur	e					
Matters requiring referral to:						
The Chief Executive of the holder of the licence, if The holder of the licence if the holder of the licence.						
 The holder of the licence, if the holder of the licence Infrastructure-related referrals – Oil and gas infrastruct 						
Matters requiring referral to the Brisbane City Council :						
Ports – Brisbane core port land						
Matters requiring referral to the Minister responsible for	administering the <i>Transpor</i>	t Infrastructure Act 1994:				
Ports – Brisbane core port land (where inconsistent with the	Brisbane port LUP for transport reas	ons)				
Ports – Strategic port land						
Matters requiring referral to the relevant port operator , if Ports – Land within Port of Brisbane's port limits (below)	• • • • • • • • • • • • • • • • • • • •					
	<u> </u>					
Matters requiring referral to the Chief Executive of the re Ports – Land within limits of another port (below high-wate	•					
Matters requiring referral to the Gold Coast Waterways A	·					
☐ Tidal works or work in a coastal management district (in						
Matters requiring referral to the Queensland Fire and Em	ergency Service:					
☐ Tidal works or work in a coastal management district (in	nvolving a marina (more than six ves	sel berths))				
18) Has any referral agency provided a referral response t						
☐ Yes – referral response(s) received and listed below ar☒ No	e attached to this developme	nt application				
Referral requirement Referral agency Date of referral response						
Identify and describe any changes made to the proposed development application that was the subject of the referral response and this development application, or include details in a schedule to this development application (if applicable).						
PART 6 – INFORMATION REQUEST						

19) Information request under Part 3 of the DA Rules					
☑ I agree to receive an information request if determined necessary for this development application	☐ I agree to receive an information request if determined necessary for this development application				
☐ I do not agree to accept an information request for this development application					
Note: By not agreeing to accept an information request I, the applicant, acknowledge:					
 that this development application will be assessed and decided based on the information provided when making this development application and the assessment manager and any referral agencies relevant to the development application are not obligated under the language Rules to accept any additional information provided by the applicant for the development application unless agreed to by the relevant parties 	DΑ				
 Part 3 of the DA Rules will still apply if the application is an application listed under section 11.3 of the DA Rules. 					
Further advice about information requests is contained in the <u>DA Forms Guide</u> .					

PART 7 – FURTHER DETAILS

20) Are there any associated	development applications or	current appr	ovals? (e.g. a preli	minary approval)			
· •	w or include details in a sched	dule to this d	evelopment app	lication			
⊠ No							
List of approval/development	Reference number	Date		Assessment			
application references				manager			
☐ Approval							
☐ Development application							
☐ Approval							
☐ Development application							
	·	·					
21) Has the portable long ser operational work)	vice leave levy been paid? (or	nly applicable to	development applic	eations involving building work or			
Yes – a copy of the receip	ted QLeave form is attached	to this devel	opment applicati	on			
	rovide evidence that the porta						
assessment manager dec	ides the development applicat	tion. I ackno	wledge that the a	assessment manager may			
	val only if I provide evidence t	•	~	·			
☐ Not applicable (e.g. buildir	ng and construction work is le	ss than \$150	0,000 excluding	GST)			
Amount paid	Date paid (dd/mm/yy)		QLeave levy no	umber (A, B or E)			
\$2718	25/10/2024		S396772				
22) Is this development applic	cation in response to a show o	cause notice	or required as a	result of an enforcement			
notice?							
☐ Yes – show cause or enfo	rcement notice is attached						
⊠ No							
23) Further legislative require	ments						
Environmentally relevant a	ctivities						
23.1) Is this development app	olication also taken to be an a	pplication for	an environment	tal authority for an			
	Activity (ERA) under section ²						
Yes – the required attachr	ment (form ESR/2015/1791) fo	or an applica	tion for an envir	onmental authority			
accompanies this develop	ment application, and details a	are provided	in the table belo	ow .			
⊠ No							
	tal authority can be found by searchir to operate. See <u>www.business.qld.go</u>			m at <u>www.qld.gov.au</u> . An ERA			
Proposed ERA number:		Proposed E	RA threshold:				
Proposed ERA name:							
☐ Multiple ERAs are applicable to this development application and the details have been attached in a schedule to this development application.							
Hazardous chemical faciliti							
23.2) Is this development app		mical facilit	y ?				
Yes – Form 69: Notificatio	n of a facility exceeding 10%	of schedule	15 threshold is a	attached to this development			
application							
No Note: See www.business.ald.gov.au for further information about hazardous chemical notifications							

Clearing native vegetation
23.3) Does this development application involve clearing native vegetation that requires written confirmation that the chief executive of the <i>Vegetation Management Act 1999</i> is satisfied the clearing is for a relevant purpose under section 22A of the <i>Vegetation Management Act 1999</i> ?
☐ Yes – this development application includes written confirmation from the chief executive of the <i>Vegetation Management Act 1999</i> (s22A determination)
 No Note: 1. Where a development application for operational work or material change of use requires a s22A determination and this is not included, the development application is prohibited development. 2. See https://www.qld.gov.au/environment/land/vegetation/applying for further information on how to obtain a s22A determination.
Environmental offsets
23.4) Is this development application taken to be a prescribed activity that may have a significant residual impact on a prescribed environmental matter under the <i>Environmental Offsets Act 2014</i> ?
 Yes – I acknowledge that an environmental offset must be provided for any prescribed activity assessed as having a significant residual impact on a prescribed environmental matter No
Note: The environmental offset section of the Queensland Government's website can be accessed at www.qld.gov.au for further information on environmental offsets.
Koala habitat in SEQ Region
23.5) Does this development application involve a material change of use, reconfiguring a lot or operational work which is assessable development under Schedule 10, Part 10 of the Planning Regulation 2017?
☐ Yes – the development application involves premises in the koala habitat area in the koala priority area
Yes – the development application involves premises in the koala habitat area outside the koala priority area
No Note: If a koala habitat area determination has been obtained for this premises and is current over the land, it should be provided as part of this development application. See koala habitat area guidance materials at www.des.qld.gov.au for further information.
Water resources
23.6) Does this development application involve taking or interfering with underground water through an
artesian or subartesian bore, taking or interfering with water in a watercourse, lake or spring, or taking overland flow water under the <i>Water Act 2000</i> ?
overland flow water under the Water Act 2000? ☐ Yes – the relevant template is completed and attached to this development application and I acknowledge that a relevant authorisation or licence under the Water Act 2000 may be required prior to commencing development ☐ No
overland flow water under the Water Act 2000? ☐ Yes – the relevant template is completed and attached to this development application and I acknowledge that a relevant authorisation or licence under the Water Act 2000 may be required prior to commencing development ☐ No Note: Contact the Department of Natural Resources, Mines and Energy at www.dnrme.qld.gov.au for further information.
overland flow water under the Water Act 2000? ☐ Yes – the relevant template is completed and attached to this development application and I acknowledge that a relevant authorisation or licence under the Water Act 2000 may be required prior to commencing development ☐ No
overland flow water under the Water Act 2000? ☐ Yes — the relevant template is completed and attached to this development application and I acknowledge that a relevant authorisation or licence under the Water Act 2000 may be required prior to commencing development ☐ No Note: Contact the Department of Natural Resources, Mines and Energy at www.dnrme.qld.gov.au for further information. DA templates are available from https://planning.dsdmip.qld.gov.au/. If the development application involves: Taking or interfering with underground water through an artesian or subartesian bore: complete DA Form 1 Template 1 Taking or interfering with water in a watercourse, lake or spring: complete DA Form1 Template 2
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Quarry materials from a wat	tercourse or lake				
23.9) Does this development a under the <i>Water Act 2000?</i>	application involve the remo v	val of quarry materials fro	om a watercourse or lake		
	a quarry material allocation n	otice must be obtained price	or to commencing development		
	No Note: Contact the Department of Natural Resources, Mines and Energy at www.dnrme.qld.gov.au and www.business.qld.gov.au for further information.				
Quarry materials from land	under tidal waters				
23.10) Does this development under the <i>Coastal Protection</i> a		oval of quarry materials f	rom land under tidal water		
☐ Yes – I acknowledge that a ☐ No	a quarry material allocation n	otice must be obtained pric	or to commencing development		
Note: Contact the Department of Env	rironment and Science at <u>www.des.c</u>	<u>qld.gov.au</u> for further information.			
Referable dams					
23.11) Does this development section 343 of the <i>Water Supp</i>					
	g a Failure Impact Assessme his development application	ent' from the chief executive	e administering the Water		
No Note: See guidance materials at www	v.dnrme.qld.gov.au for further inforn	nation.			
Tidal work or development					
23.12) Does this development	t application involve tidal wo	ork or development in a co	pastal management district?		
Yes – the following is inclu	ded with this development a	pplication:	•		
Evidence the proposal meets the code for assessable development that is prescribed tidal work (only required if application involves prescribed tidal work)					
☐ A certificate of title					
No No					
Note: See guidance materials at www. Queensland and local herita		10n.			
	t application propose develor		ce entered in the Queensland ister?		
_	ge place are provided in the t				
⊠ No					
Note: See guidance materials at www Name of the heritage place:	<u>w.des.qid.gov.au</u> for information requ	Place ID:	or Queensiand neritage places.		
3 1		Place ID.			
Brothels	Committee (Committee Committee Committee Committee Committee Committee Committee Committee Committee Committee		- (I IO		
23.14) Does this development	• •	_			
Yes – this development ap application for a brothel unNo	oplication demonstrates now the prosting of th		le for a development		
Decision under section 62 o	of the <i>Transport Infrastruct</i>	ure Act 1994			
23.15) Does this development			controlled road?		
Yes – this application will b	• • •	for a decision under section	n 62 of the <i>Transport</i>		

Walkable neighbourhoods assessment benchmarks under Schedule 12A of the Planning Regulation
23.16) Does this development application involve reconfiguring a lot into 2 or more lots in certain residential zones (except rural residential zones), where at least one road is created or extended?
Yes – Schedule 12A is applicable to the development application and the assessment benchmarks contained in schedule 12A have been considered
No Note: See guidance materials at www.planning.dsdmip.qld.gov.au for further information.

PART 8 - CHECKLIST AND APPLICANT DECLARATION

24) Development application checklist	
I have identified the assessment manager in question 15 and all relevant referral	
requirement(s) in question 17	⊠ Yes
Note: See the Planning Regulation 2017 for referral requirements	
If building work is associated with the proposed development, Parts 4 to 6 of <u>DA Form 2 –</u>	⊠ Yes
Building work details have been completed and attached to this development application	☐ Not applicable
Supporting information addressing any applicable assessment benchmarks is with the	
development application	
Note : This is a mandatory requirement and includes any relevant templates under question 23, a planning report and any technical reports required by the relevant categorising instruments (e.g. local government planning	⊠ Yes
schemes, State Planning Policy, State Development Assessment Provisions). For further information, see DA	
Forms Guide: Planning Report Template.	
Relevant plans of the development are attached to this development application	=
Note: Relevant plans are required to be submitted for all aspects of this development application. For further	⊠ Yes
information, see <u>DA Forms Guide: Relevant plans.</u>	<u> </u>
The portable long service leave levy for QLeave has been paid, or will be paid before a	⊠ Yes
development permit is issued (see 21)	☐ Not applicable
25) Applicant declaration	
By making this development application, I declare that all information in this development correct	application is true and
☑ Where an email address is provided in Part 1 of this form, I consent to receive future elec	tronic communications
from the assessment manager and any referral agency for the development application w	
is required or permitted pursuant to sections 11 and 12 of the <i>Electronic Transactions Ac</i>	± 2001
Note: It is unlawful to intentionally provide false or misleading information.	
Privacy – Personal information collected in this form will be used by the assessment manag	
assessment manager, any relevant referral agency and/or building certifier (including any prowhich may be engaged by those entities) while processing, assessing and deciding the deve	
All information relating to this development application may be available for inspection and p	
The intermediation relating to this development application may be available for interestion and p	areriace, arrazer
published on the assessment manager's and/or referral agency's website.	
published on the assessment manager's and/or referral agency's website. Personal information will not be disclosed for a purpose unrelated to the <i>Planning Act 2016</i> ,	Planning
	Planning
Personal information will not be disclosed for a purpose unrelated to the <i>Planning Act 2016</i> , Regulation 2017 and the DA Rules except where: • such disclosure is in accordance with the provisions about public access to documents of	ontained in the <i>Planning</i>
 Personal information will not be disclosed for a purpose unrelated to the <i>Planning Act 2016</i>, Regulation 2017 and the DA Rules except where: such disclosure is in accordance with the provisions about public access to documents of <i>Act 2016</i> and the Planning Regulation 2017, and the access rules made under the <i>Planna</i> 	ontained in the <i>Planning</i>
 Personal information will not be disclosed for a purpose unrelated to the <i>Planning Act 2016</i>, Regulation 2017 and the DA Rules except where: such disclosure is in accordance with the provisions about public access to documents of <i>Act 2016</i> and the Planning Regulation 2017, and the access rules made under the <i>Plann</i> Planning Regulation 2017; or 	ontained in the <i>Planning</i>
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 Personal information will not be disclosed for a purpose unrelated to the <i>Planning Act 2016</i>, Regulation 2017 and the DA Rules except where: such disclosure is in accordance with the provisions about public access to documents of <i>Act 2016</i> and the Planning Regulation 2017, and the access rules made under the <i>Plann</i> Planning Regulation 2017; or 	ontained in the <i>Planning</i> ing Act 2016 and

PART 9 - FOR COMPLETION OF THE ASSESSMENT MANAGER - FOR OFFICE **USE ONLY**

Date received: Reference numb	per(s):
Notification of engagement of alternative assessment man	ager
Prescribed assessment manager	
Name of chosen assessment manager	
Date chosen assessment manager engaged	
Contact number of chosen assessment manager	
Relevant licence number(s) of chosen assessment manager	

QLeave notification and payment Note: For completion by assessment manager if applicable				
Description of the work		Duplex		
QLeave project number		S396772		
Amount paid (\$) 2718		Date paid (dd/mm/yy) 25/10/2024		
Date receipted form sighted by assessment manager		15/11/2024		
Name of officer who sighted the form		Glenn Chambers		



Version: 1, Version Date: 13/12/2024



PROPOSED MULTIPLE DWELLINGS

JOB NUMBER - 24009

CLIENT - COLIN & JOANNE GOSTELOW

SITE ADDRESS - Lot 1 on RP700513

48 ATHERTON STREET

MAREEBA

CONSTRUCTION

SHEET No. SHEET NAME SCALE REVISION COVER SHEET NTS 00 01 CONSTRUCTION NOTES NTS 02 SITE PLAN 1:200 03 **DUPLEX 1 FLOOR PLAN** 1:100 DUPLEX 2 FLOOR PLAN 1:100 **ELEVATIONS** 1:100 ELEVATIONS 1:100 07 PERSPECTIVE VIEWS NTS SECTION 1:50 SECTION AS NOTED 09 **DUPLEX 1 FOOTINGS PLAN** 1:100 10 **DUPLEX 2 FOOTINGS PLAN** 1:100 11 12 FOOTING DETAILS 1:100 13 RETAINING WALLS AS NOTED DUPLEX 1 STARTER BAR LAYOUT 1:100 **DUPLEX 2 STARTER BAR LAYOUT** 1:100 **ROOF LAYOUT** 1:100 17 ELECTRICAL PLAN 1:100

DRAINAGE PLAN

1:100

DRAWING SCHEDULE

General Notes

- 1. Do not scale drawings. All dimensions to be confirmed on site. Notify Superior Steel of any discrepancies.
- 2. All workmanship and materials to be in accordance with relevant Australian standards, the Building Code 2. of Australia and local authority regulations.
- 3. The structure is to be maintained in a stable condition at all times.

General Construction

- 1. The sub-floor space of a dwelling must be ventilated in accordance with the relevant codes and standards.
- 2. All glazing to comply with relevant codes & standards & must be designed for the wind loads specific to
- 3. Smoke alarms must be installed in accordance with relevant codes & standards, be connected to mains power & comply with relevant codes & standards. Positions shown on plans are to be used as a guide only, actual position is to be in accordance with relevant codes & standards.
- 4. All balustrades and handrails to have a minimum height of 1000mm above finished floor level (i.e. top of tiles, carpet etc.) and have no opening greater than 125mm, in accordance with the building code of

Termite

- 1. Termite treatment to be as required by AS 3660.1, the Building Code of Australia and the Qld Master Builders Association's "Home Owners Guide for Termite Management".
- 2. Termite protection generally shall be by:
- a. Ground floor slab as barrier and exposed edge of slab as visual barrier;
- Termi-mesh or similar approved collars to slab penetrations; &
- Termite resistant (hazard level H2) timber framing, trim and arch 3. Where ground floor slab is the barrier, no less than 75mm of the slab edge must be exposed above
- finished ground level, it must be not concealed by render, tiles, claddings or flashings. 4. Builder to provide access for clear visual inspections to the entire perimeter of the building and the
- exposed edge of concrete slabs. 5. A durable notice showing full details of termite treatment used and the date provided to be posted inside
- the meter box or similar approved location. 6. Owner to maintain access for clear visual inspections and make periodic inspections.

Site Notes

- 1. Earthworks to be in accordance with AS 3798
- 2. Site preparation shall generally consist of clearing of vegetation followed by excavation of topsoils and material to suit final design levels.
- 3. All water to be drained away from buildings during and after construction to avoid ponding of water adiacent to external walls.
- 4. Finished slab levels to be min 150mm above finished ground level u.n.o
- 5. All levels to be confirmed on site.

Footing and Slab Notes

- 1. Footings have been designed for specified soil classification. Builder to verify site conditions prior to
- 2. Natural foundations to be scrubbed out and free of organic matter and debris and compacted to \min 5% SRDD at -5% to +2% of optimum moisture content or not less than 70% density index for cohesionless soils
- 3. Fill to slab and foundations shall be an approved non-plastic material compacted in max 200mm ayers to in 5% SRDD at -5% to +2% of optimum moisture content or not less than 70% density index or cohesionless soils.
- 4. Footing trenches to be clean and dry at the time of casting with any softened material removed. ase of all footings to be founded on firm natural ground with min safe bearing capacity of 100 kPa.
- 5. Pour slab on 200um damp proof membrane laid on 50mm of compacted sand.
- 6. Concrete slab and footings N20. Vibrate concrete and cure slab for min 7 days. Concrete cover to be maintained by the use of approved chairs spaced at approx. 750mm centres. Conduits and pipes shall not be placed within cover concrete.

Slab Height

Minimum finished slab height must be determined for each individual project and is dependent upon design factors such as:

- 1. U.N.O on plan minimum finished slab heights to be 150mm above adjacent finished ground level or 100mm above sandy, well-drained areas or 50mm above paved or concreted areas which fall away from the dwelling for 50mm over the first 1m.
- 2. Masonry veneer construction where DPC's must be 150mm minimum above adjacent ground level and require a slab edge recess as per BCA part 3.3.4.5 – 170mm above adjacent finished ground level or 70mm above adjacent paved or concreted area which fall away from the wall and are protected from the weather by a carport, verandah or the like. These dimensions assume a 20mm slab edge recess.
- 3. Level relative to drainage ORG as per AS 3500, plumbing and drainage code 150mm minimum above top of org to lowest fixture point (i.e. floor waste or shower drain) level of ORG must be 75mm minimum above finished ground level.
- 4. Standard building regulations require the level if all habitable rooms be 300mm minimum above the Q100 flood level or as determined by the local authority.
- 5. Local town planning schemes may specify levels relative to the finished surfaces in rural areas.

Concrete

- Concrete generally in accordance with AS3600.
- Concrete specification unless noted otherwise:

Agg Max Slump
nm 80mm
nm 80mm
nm 230mm
ו

- 3. Reinforcement notation
 - 'N' denotes Grade D500N hot rolled rebar to AS4671
 - 'S' denotes Grade D250N hot rolled rebar to AS4671
 - 'R' denotes Grade R250N hot rolled plain round to AS4671 'L' denotes Grade R500L cold drawn round wire to AS4671
 - 'DW' denotes Grade D500L cold drawn ribbed wire to AS4671
- 'RL', 'SL', 'L TM' denotes Grade D500 deformed wire meshes to AS4671
- Additives shall not be used without the Superintendent's approval.
- Mechanically vibrate concrete in the form to give maximum compaction without segregation of the concrete.
- Cure concrete as required by Section 19 of AS3600.
- Concrete sizes shown are minimum and do not include applied finishes.
- Do not reduce or hole concrete without Superintendent's approval.
- Do not place conduits, pipes and the like within the cover concrete.
- Formwork shall generally comply with AS3610.
- 8. Stripping of formwork shall comply with Section 19 of AS3600.

Stripping times (Ground Slab/Footings):

Removal of forms 3 days Removal of props 14 days

Stripping times (Suspended Slabs):

Removal of forms 14 days Removal of props 14 days

(Such floor shall remain unloaded for 28 days)

Pathways & Driveways

- 1. All pathways and payements shall have a minimum fall of 1 in 100 (1%) and maximum fall of 1 in 5
- 2. Check with local authority requirements prior to construction any driveways, pathways or crossovers between the property boundary and road kerb.

Structural Timber

- Timber generally to AS 1684 and AS 1720.
- Min stress grade F14 unless noted otherwise.
- Min bolt size M12 unless noted otherwise.
- 4. Timber framing:
- a. 90x35 MGP-12 (H2) framing
- Studs @ 450 ctrs, 1 row nogging
- Single bottom plate, double top plate
- d. M12 cyclone rods at ends, corners, beside openings and otherwise at max 1200mm ctrs e. Lintels 150x75 F14 hwd unless noted otherwise
- 5. Wall bracing (unless noted otherwise): 4mm F27 structural ply fixed with 2.8Øx30 gal flathead nails @
- 100 ctrs at top & bottom plate, @ 150 ctrs at vertical edges and @ 300 ctrs at intermediate studs.
- Fix wall bottom plate to joists with M12 bolts @ 900 ctrs.
- Fix wall top plate to trusses with 125x75x6 angle bracket, 1/M12 bolt top plate and truss.
- Where bracing wall is parallel to joists or trusses, provide 50x75 F14 hwd nogging @ 900 ctrs fixed with 2/75mm batten screws each end. 1/M12 bolt thru nogging and wall top plate.

Steelwork

- Generally in accordance with AS 4100, AS 1554.1 and AS 1538.
- 2. Unless noted otherwise, the following materials shall be used:
- a. Hot rolled sections Grade C300 plus to AS 3679.1
- b. Steel hollow sections Grade C350 to AS 1163
- c. Cold formed steel sections Grade 450 to AS 1397
- d. Bolts Grade 4.6/S to AS 1111 generally and Grade 8.8/S to AS 1252 $\,$
- Galvanised bolts to AS 1214
- f. Welding to comply with AS 1554.1 3. Unless noted otherwise use:
 - a. 10mm thick cleats, gussets, fins and end plates
- b. All bolts to be galvanised to AS 1214 6mm continuous fillet welds to AS 1554.1
- d. All structural steelwork galvanised or system painted to equivalent protection

1. Any exposed structural timber which has any area in contact with another material and which will be inaccessible after fixing is to be given a coat of primer before fixing

NOTE: (1). VERIFY ALL DIMENSIONS AND LEVELS BEFORE COMMENCING ANY WORK. (2). VERIFY ALL ON SITE DIMENSIONS TO TAKE PRECEDENCE OVER SCALED MEASUREMENTS. (4). ALL WORK TO COMPLY WITH LOCAL AUTHORITY REQUIREMENTS, THE STANDARD

Roofing

- 1. Roof trusses and roof bracing in accordance with manufacturer's specification for specified wind classification.
- 2. Roof battens (U.N.O) 2 @ 600 ctrs at ridges and eaves, otherwise 850 ctrs
- a. 75x38 F11 hwd battens fix with 1-No. 14 Type 17 75mm batten screw.
- Topspan 40 battens fix with 2-No. M6-11x25 Zips
- 3. Roof sheeting fixed in accordance with manufacturer's specification for specified wind classification

Roof Drainage

- 1. All roof water drainage must be connected to a stormwater drainage system complying with the relevant codes & standards. Or roof water to be discharged onto a concrete splash pad at ground level with site surface sloping to channel and kerb.
- Roof drainage system must have an overflow system to prevent the backflow of water into the building.
- The area specific rainfall intensity must be selected form the relevant codes & standards.
- Gutters & downpipes must be selected from relevant codes & standards.
- Gutter to be installed with a fall not less than 1 in 500 with support brackets at 1.2m maximum ctrs. 6. Box gutters must be installed with a fall not less than 1 in 100, in accordance with relevant codes &
- standards. 7. Valley gutter width shall be in accordance with relevant codes & standards. Refer to roof sheeting
- manufactures specifications for limitations on sheet overhangs into valley gutters. Valley gutters on roof pitches less than 12.5° must be designed as a box gutter
- 8. Downpipe positions are calculated using the Stramit QLD guide in conjunction with AS 2179 & AS 3500.3 U.N.O.
- 9. Unless noted otherwise, downpipes and gutters to be installed using the following:
- a. Downpipes should not exceed spacings of 1.2m, if downpipe is more than 1.2m from valley gutter provisions should be made for an overflow system.
- b. Minimum fall of eave gutters = 1:500
- Minimum for box gutters = 1:100

Bathrooms & Wet Areas

- Bathrooms and wet areas are to be treated in accordance with BCA.
- 2. Doors to toilets which swing 'in' are to have lift-off hinges. Adequate clearance should be, provided at top of door to suit hinges
- 3. All timber or steel framed walls to wet areas to be lined with FC or approved wet area cladding, fixed in accordance with manufactures specifications.
- 4. All timber to steel framed floors to have wet area flooring in wet areas, fixed in accordance with manufactures specifications

Sustainability Requirements

5-Star Energy Rating

Class 1 buildings and attached enclosed class 10a buildings will require a 5-star energy rating. Achieving 5 stars will be by compliance with the provisions of part 3.12 of the building code of Australia.

Concessions apply to buildings which have an outdoor living space which is directly accessible from a living area such as a lounge, kitchen, dining or family room. The outdoor living space must have a minimum area of 12m² and a minimum dimension of 2.5m.

In climate zones 1 & 2 buildings with a conforming outdoor living space will be required to be not less than 4.5stars, where the roof of the outdoor living space achieves a total R-value of 1.5 downwards the building will require a minimum 4.25-stars and where the outdoor living space is fitted with a 900mm diameter minimum ceiling fan and roof achieves a total R-value of 1.5 downwards, 4-stars.

A minimum of 80% of all internal fixed lighting must be energy efficient lighting.

All hard-wired; new and replacement air-conditioners to have an energy efficiency ratio of at least 2.9.

In areas serviced by a water service provider, all shower roses to have a minimum 3-star water efficiency labelling and standards (WELS) rating.

Dual flush 4-star (WELS) Toilet

In areas serviced by a water service provider, all toilets cisterns must be dual flush 4-star (WELS) rated and must be compatible with the size of the toilet bowl.

3-star (WELS) Tapware

In areas serviced by a water service provider, all tapware serving laundry troughs, kitchen sinks and bathroom basins must have a minimum 3-star (WELS) rating.

Ultimate and Serviceability Limit State Design Wind Pressures

Wind	Design Gust Wind Speed (m/s)		Design Pressures for Windows (kPa) Greater than 1.2m from Up to 1.2m from the			
Classification	Vh,u	Vh,s	corners		corner	
	ULS	SLS	ULS	SLS	ULS	SLS
C1	50	32	±1.80	±0.55	-2.70	-0.83
C2	61	39	±2.68	±0.82	-4.02	-1.23
C3	74	47	±5.33	±1.63	-7.99	-2.45

KFB Engineers Civil & Structura 1/38-42 Pease St, Cairns | PO Box 927, Cairns Q 4870 P: 07 40320492 | F: 07 40320092 | E: 977ail@kfbeng.c 23/9/24 Date: Signed:

RPEQ No:

K-13174

Job No:

CERTIFIED AS

STRUCTURALLY ADEQUATE

THIS DRAWING IS COPYRIGHT ©

B 20/09/24 CONSTRUCTION ISSUE A 21/04/24 PRELIMINARY ISSUE No. DATE **DESCRIPTION**

VARIATIONS INCLUDED IN THIS DRAWING

CONSTRUCTION ISSUE

PROPOSED MULTIPLE DWELLINGS Lot 1 on RP700513 **48 ATHERTON STREET** MAREEBA

CLIENT **COLIN & JOANNE GOSTELOW**

CONSTRUCTION **NOTES**

SHEET NO.

DRAWN BY:

01 SCALE:

IOB NUMBER:


NTS AT A3

24009


DESIGN WIND SPEED: C2 SOIL CLASSIFICATION

20/09/2024 1:26:12 PM

BUILDING BY-LAWS, THE BUILDING CODE OF AUSTRALIA AND RELEVANT AUSTRALIAN STANDARDS. (5). SUBSTITUTION OF ANY STRUCTRAL MEMBERS, & OR VARIATIONS TO ANY PART OF THE DESIGNALL VOID ANY RESPONSIBILITIES OF THE BUILDING DESIGNER FOR THE STRUCTURAL INTEGRITY & PERFORMANCE OF THE BUILDING DOCUMENT SET ID: 4443120

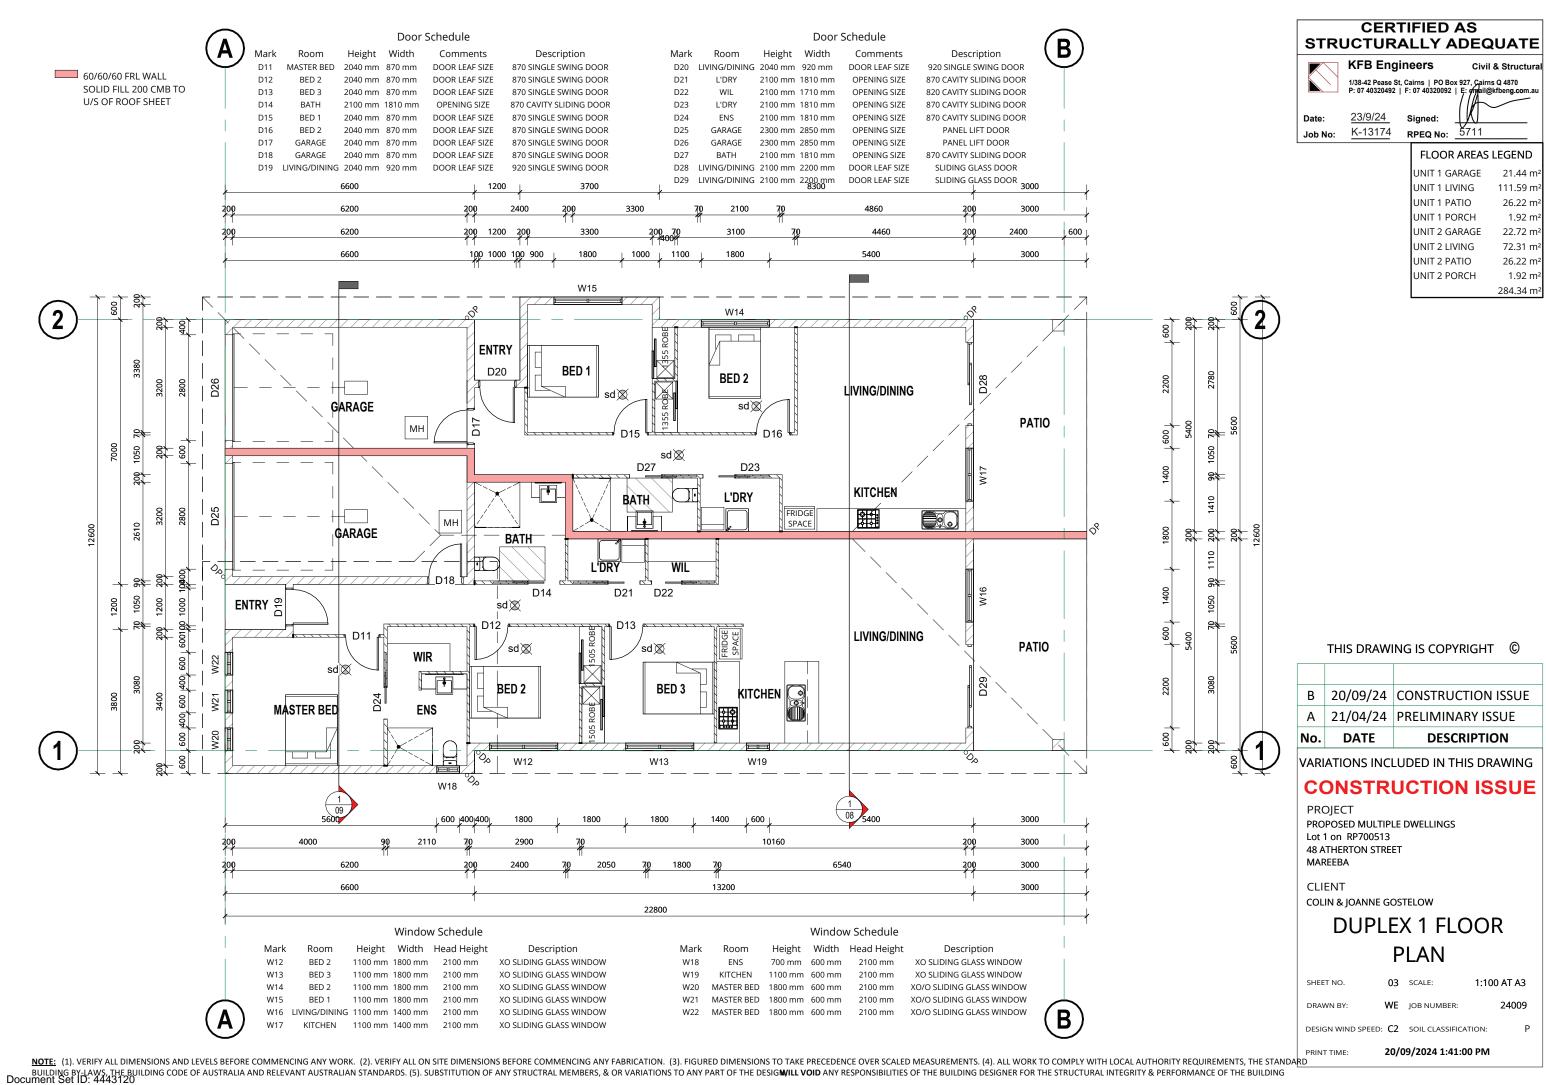


Version: 1, Version Date: 13/12/2024

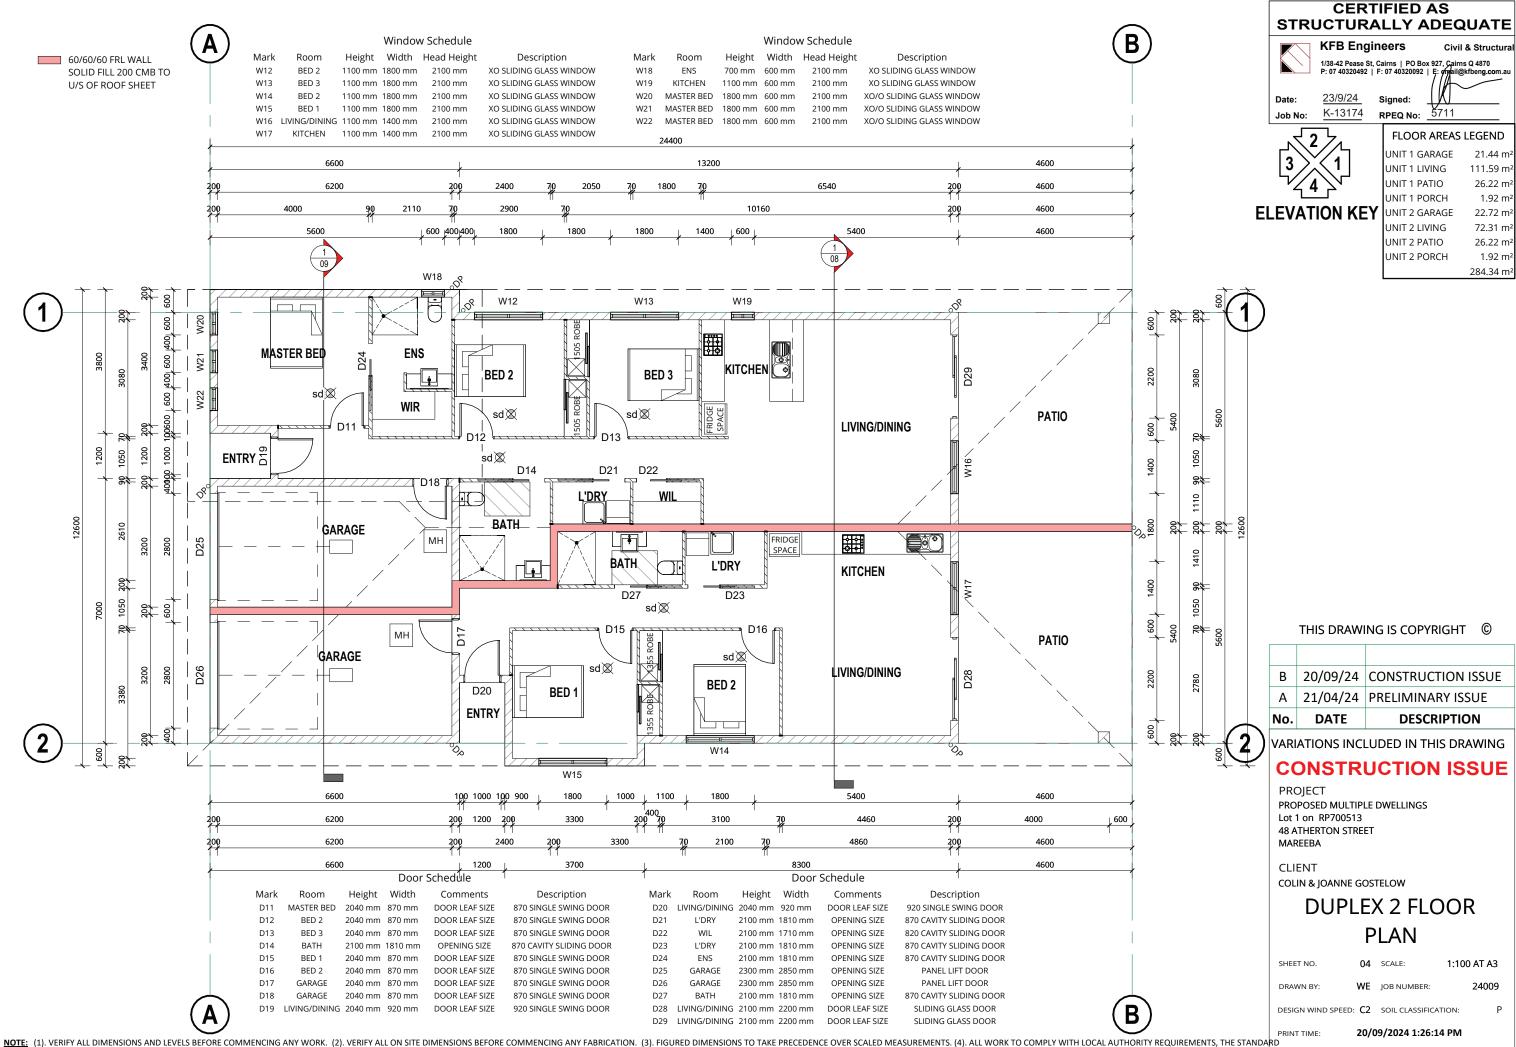


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ELEVATION 1

SCALE - 1:100

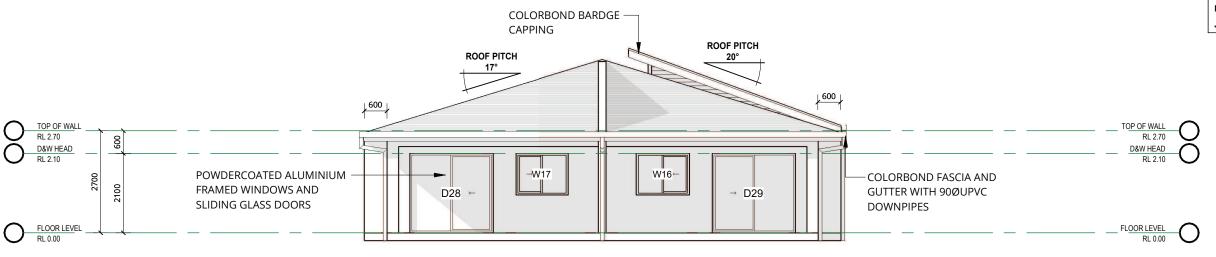

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PROJECT PROPOSED MULTIPLE DWELLINGS Lot 1 on RP700513 **48 ATHERTON STREET** MAREEBA

CLIENT

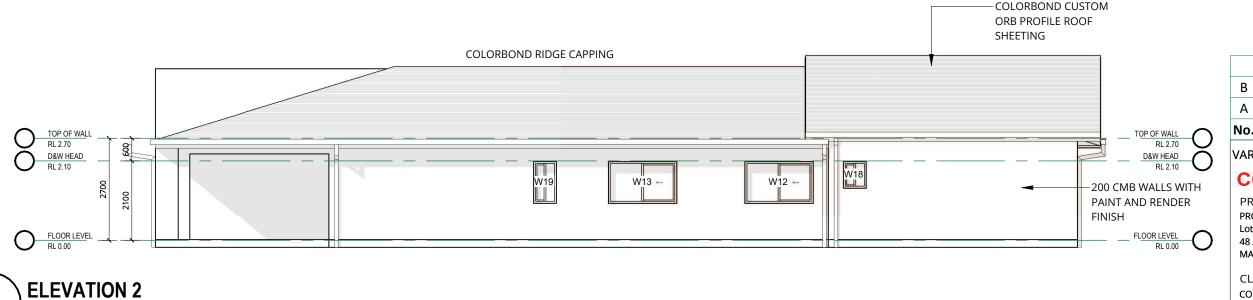COLIN & JOANNE GOSTELOW

ELEVATIONS

SHEET NO.

05 SCALE:

1:100 AT A3

DRAWN BY:


WE JOB NUMBER:

24009

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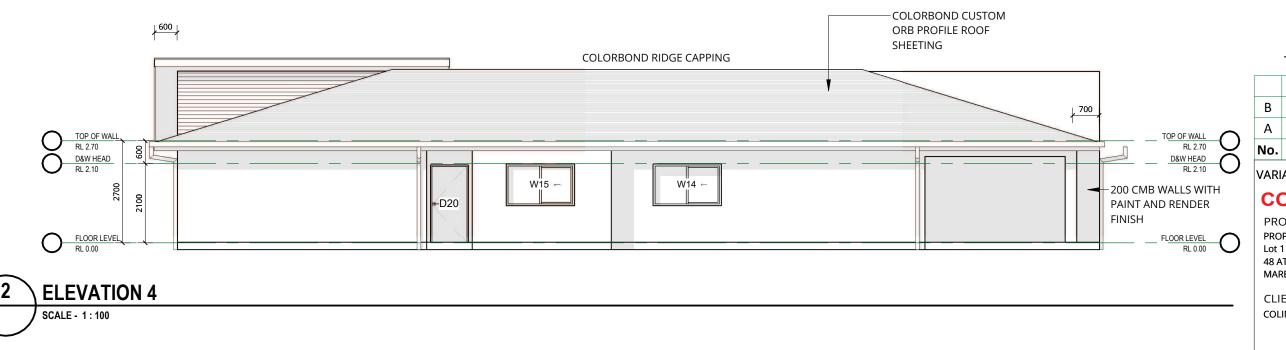
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NOTE: (1). VERIFY ALL DIMENSIONS AND LEVELS BEFORE COMMENCING ANY WORK. (2). VERIFY ALL ON SITE DIMENSIONS BEFORE COMMENCING ANY HORSIONS TO TAKE PRECEDENCE OVER SCALED MEASUREMENTS. (4). ALL WORK TO COMPLY WITH LOCAL AUTHORITY REQUIREMENTS, THE STANDARD BUILDING BY-LAWS, THE BUILDING CODE OF AUSTRALIA AND RELEVANT AUSTRALIAN STANDARDS. (5). SUBSTITUTION OF ANY STRUCTRAL MEMBERS, & OR VARIATIONS TO ANY PART OF THE DESIGNILL VOID ANY RESPONSIBILITIES OF THE BUILDING DESIGNER FOR THE STRUCTURAL INTEGRITY & PERFORMANCE OF THE BUILDING DOcument Set ID: 4443120





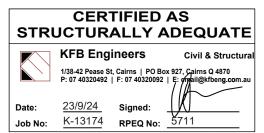



B 20/09/24 CONSTRUCTION ISSUE A 21/04/24 PRELIMINARY ISSUE DATE **DESCRIPTION** VARIATIONS INCLUDED IN THIS DRAWING **CONSTRUCTION ISSUE** PROJECT PROPOSED MULTIPLE DWELLINGS Lot 1 on RP700513 **48 ATHERTON STREET** MAREEBA CLIENT **COLIN & JOANNE GOSTELOW ELEVATIONS** SHEET NO. 1:100 AT A3 06 SCALE:

WE IOB NUMBER:

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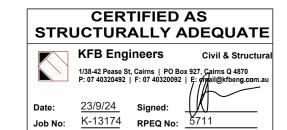
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No.	DATE	DESCRIPTION
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В	20/09/24	CONSTRUCTION ISSUE

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CONSTRUCTION ISSUE

PROPOSED MULTIPLE DWELLINGS Lot 1 on RP700513 48 ATHERTON STREET MAREEBA

CLIENT

COLIN & JOANNE GOSTELOW

PERSPECTIVE VIEWS


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DRAWN BY: WE JOB NUMBER:

DESIGN WIND SPEED: C2 SOIL CLASSIFICATION:

20/09/2024 1:26:19 PM



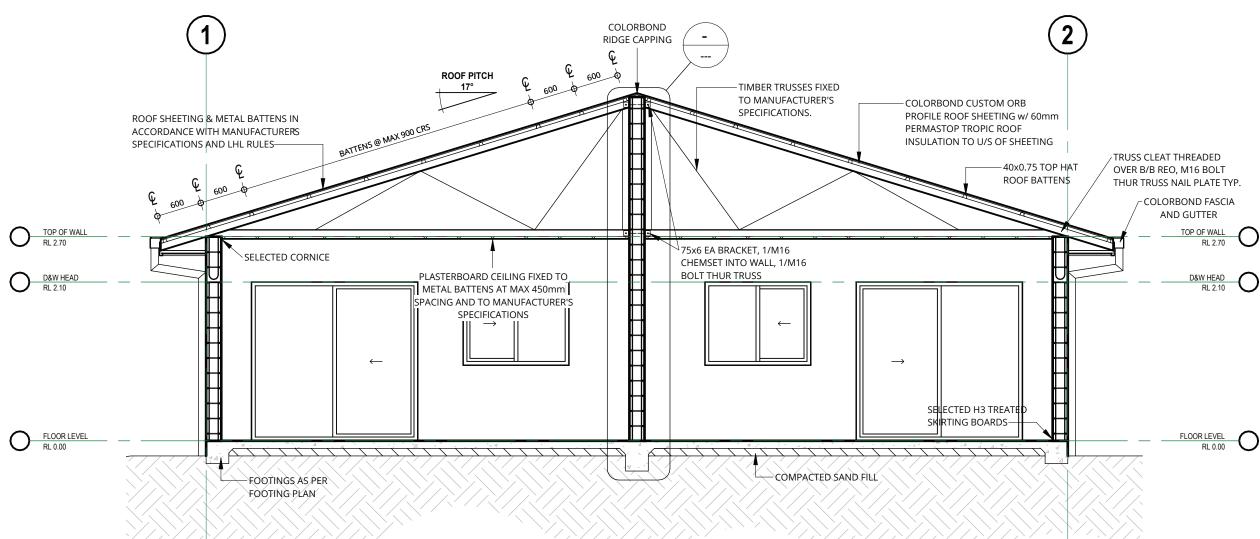

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CONSTRUCTION ISSUE

PROJECT
PROPOSED MULTIPLE DWELLINGS
Lot 1 on RP700513
48 ATHERTON STREET
MAREEBA

CLIENT

COLIN & JOANNE GOSTELOW

SECTION

SHEET NO.

08 SCALE:

1:50 AT A3 24009

DRAWN BY:


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DESIGN WIND SPEED: C2 SOIL CLASSIFICATION:

TIME: 20/09/2024 1:26:20 PM

NOTE: (1). VERIFY ALL DIMENSIONS AND LEVELS BEFORE COMMENCING ANY WORK. (2). VERIFY ALL ON SITE DIMENSIONS BEFORE COMMENCING ANY FABRICATION. (3). FIGURED DIMENSIONS TO TAKE PRECEDENCE OVER SCALED MEASUREMENTS. (4). ALL WORK TO COMPLY WITH LOCAL AUTHORITY REQUIREMENTS, THE STANDARD BUILDING BY LAWS, THE BUILDING CODE OF AUSTRALIA AND RELEVANT AUSTRALIAN STANDARDS. (5). SUBSTITUTION OF ANY STRUCTRAL MEMBERS, & OR VARIATIONS TO ANY PART OF THE DESIGNABLE VOID ANY RESPONSIBILITIES OF THE BUILDING DESIGNER FOR THE STRUCTURAL INTEGRITY & PERFORMANCE OF THE BUILDING DOCUMENT Set ID: 4443120



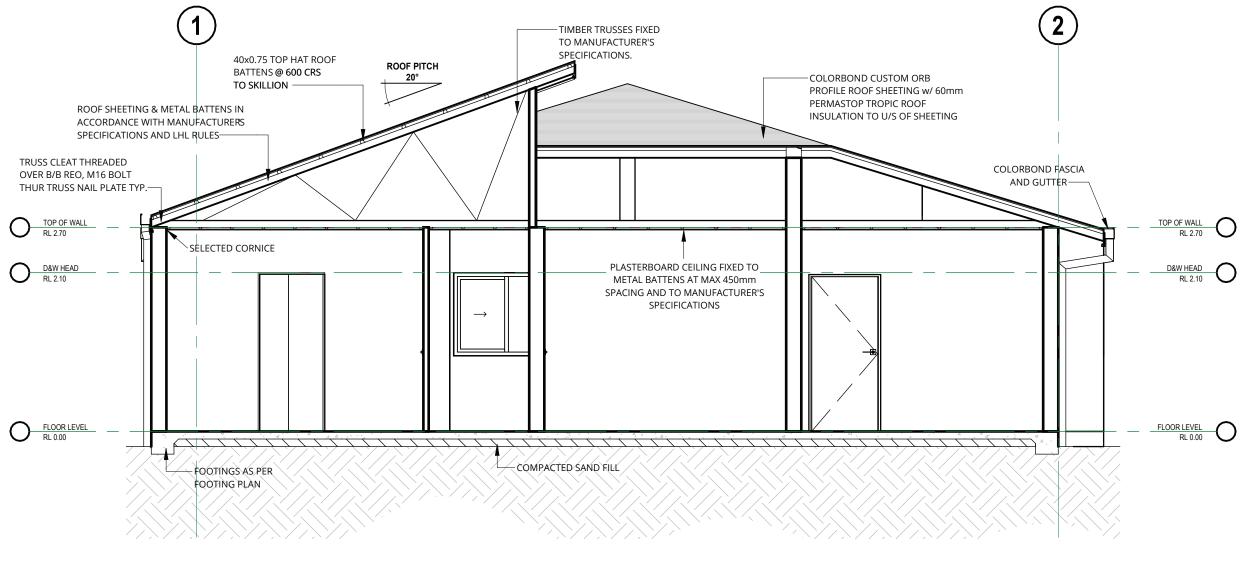

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PROJECT
PROPOSED MULTIPLE DWELLINGS
Lot 1 on RP700513
48 ATHERTON STREET
MAREEBA

CLIENT

COLIN & JOANNE GOSTELOW

SECTION

SHEET NO. 09 SCALE: AS NOTED AT A3

DRAWN BY: WE JOB NUMBER: 24009


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DESIGN WIND SPEED: C2 SOIL CLASSIFICATION:

NOTE: (1). VERIFY ALL DIMENSIONS AND LEVELS BEFORE COMMENCING ANY WORK. (2). VERIFY ALL ON SITE DIMENSIONS BEFORE COMMENCING ANY FABRICATION. (3). FIGURED DIMENSIONS TO TAKE PRECEDENCE OVER SCALED MEASUREMENTS. (4). ALL WORK TO COMPLY WITH LOCAL AUTHORITY REQUIREMENTS, THE STANDARD BUILDING BY LAWS, THE BUILDING CODE OF AUSTRALIA AND RELEVANT AUSTRALIAN STANDARDS. (5). SUBSTITUTION OF ANY STRUCTRAL MEMBERS, & OR VARIATIONS TO ANY PART OF THE DESIGNAL VOID ANY RESPONSIBILITIES OF THE BUILDING DESIGNER FOR THE STRUCTURAL INTEGRITY & PERFORMANCE OF THE BUILDING DOCUMENT Set 1D: 4443120


SECTION 2

SCALE - 1:50

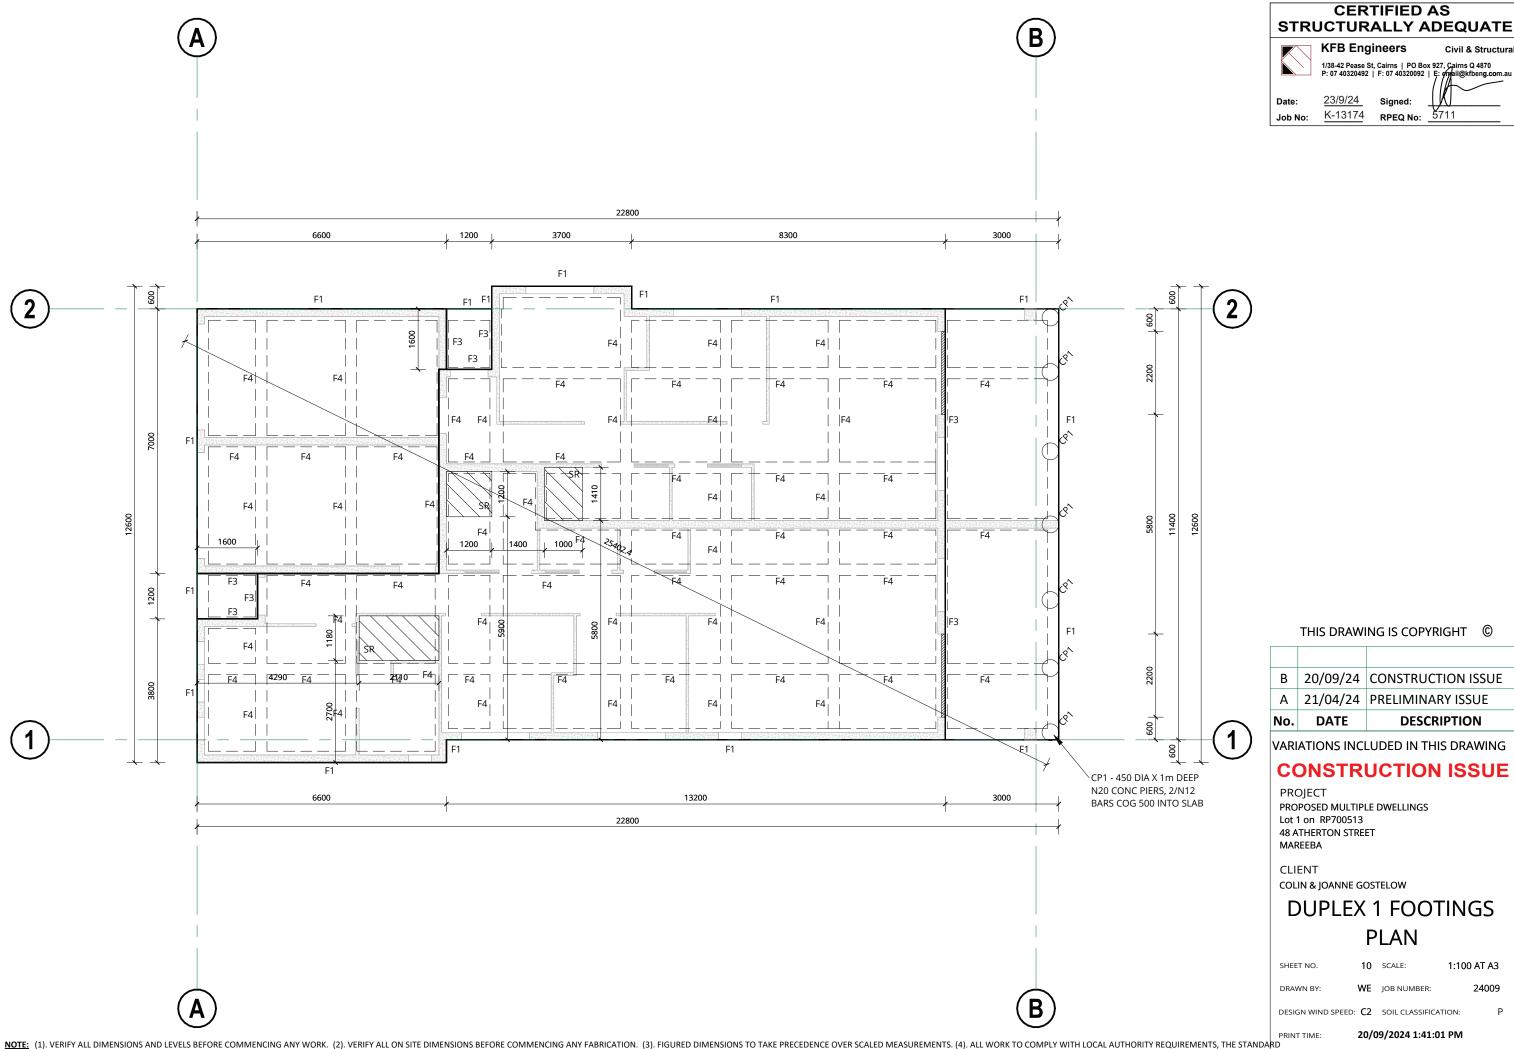



Version: 1, Version Date: 13/12/2024


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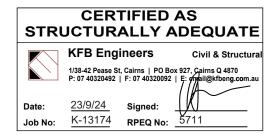

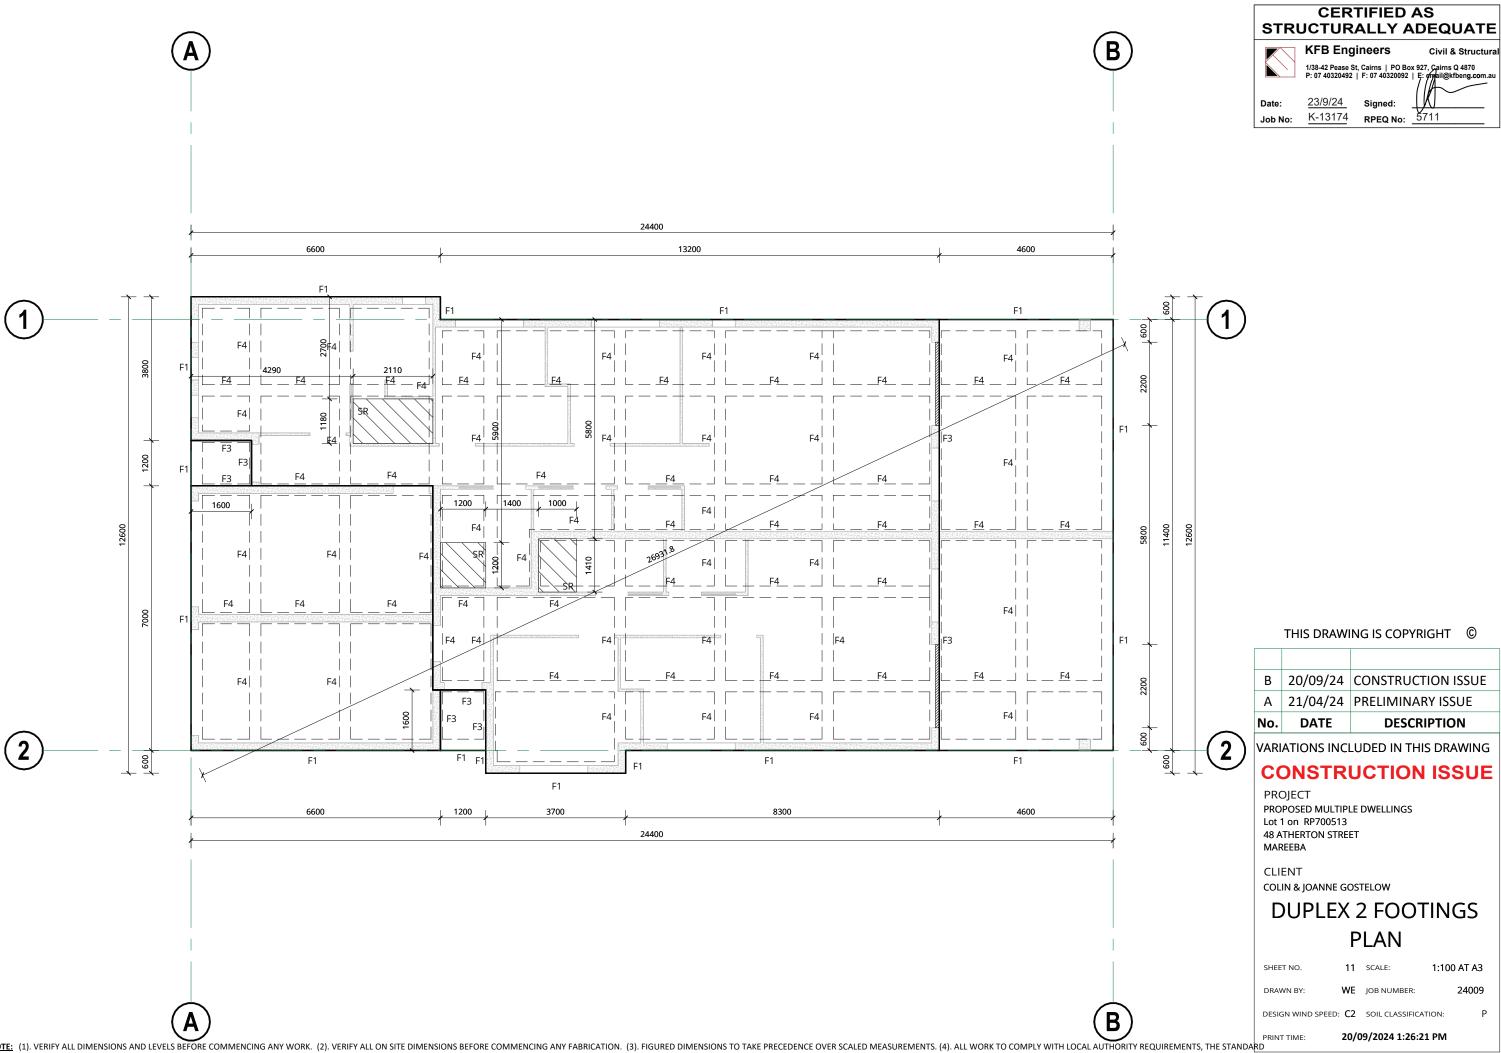
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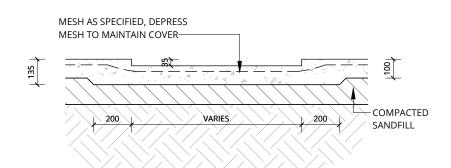





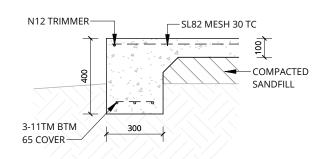

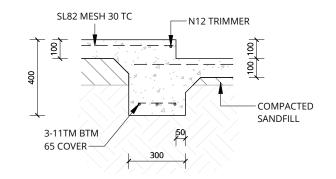

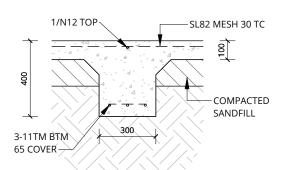





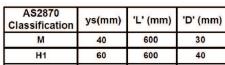

EJ - EXPANSION JOINT

SEJ - SWIVEL AND EXPANSION JOINT

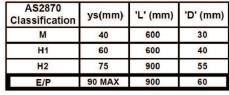

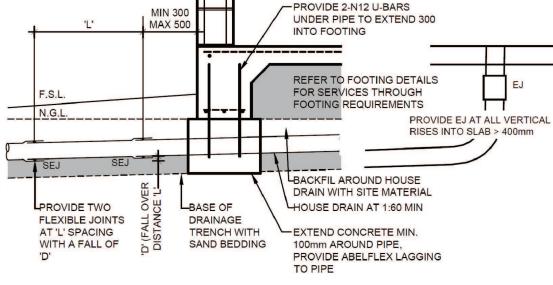

OPTIONAL SHOWER RECESS

DRAINAGE UNDER SLABS

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PROJECT PROPOSED MULTIPLE DWELLINGS Lot 1 on RP700513 **48 ATHERTON STREET** MAREEBA

CLIENT


COLIN & JOANNE GOSTELOW


FOOTING DETAILS

SHEET NO. 12 SCALE: 1:100 AT A3 24009 DRAWN BY: WE IOB NUMBER: DESIGN WIND SPEED: C2 SOIL CLASSIFICATION:

20/09/2024 1:26:22 PM

NOTE: (1). VERIFY ALL DIMENSIONS AND LEVELS BEFORE COMMENCING ANY WORK. (2). VERIFY ALL ON SITE DIMENSIONS BEFORE COMMENCING ANY FABRICATION. (3). FIGURED DIMENSIONS TO TAKE PRECEDENCE OVER SCALED MEASUREMENTS. (4). ALL WORK TO COMPLY WITH LOCAL AUTHORITY REQUIREMENTS, THE STANDARD BUILDING BY-LAWS, THE BUILDING CODE OF AUSTRALIA AND RELEVANT AUSTRALIAN STANDARDS. (5). SUBSTITUTION OF ANY STRUCTRAL MEMBERS, & OR VARIATIONS TO ANY PART OF THE DESIGNILL VOID ANY RESPONSIBILITIES OF THE BUILDING DESIGNER FOR THE STRUCTURAL INTEGRITY & PERFORMANCE OF THE BUILDING DOcument Set ID: 4443120

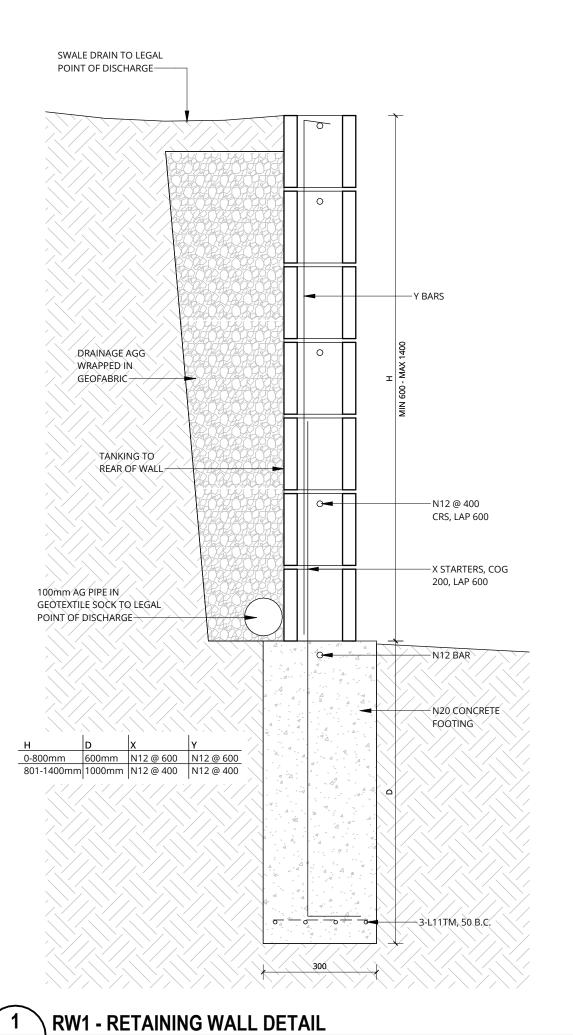

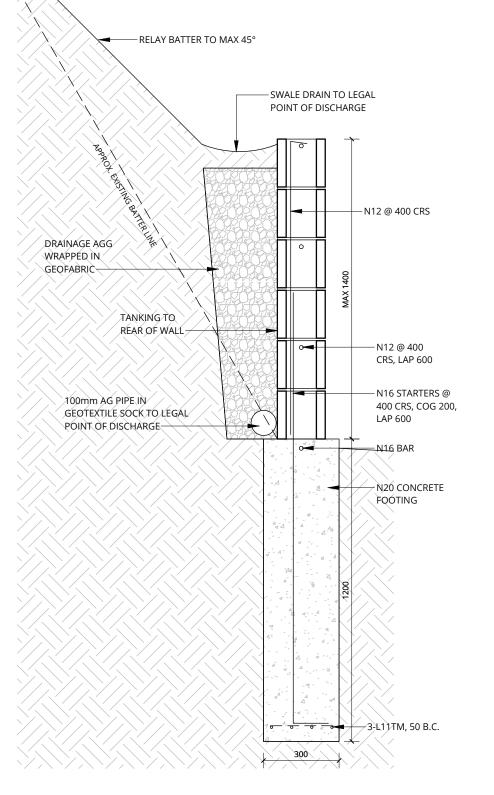



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No. DATE DESCRIPTION

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PROJECT
PROPOSED MULTIPLE DWELLINGS
Lot 1 on RP700513
48 ATHERTON STREET
MAREEBA

2 RW2 - RETAINING WALL DETAIL

SCALE - 1 : 15

PRINT TIME: 22/09/2024 4:12:41 PM
THE STANDARD
BUILDING

CLIENT

SHEET NO.

DRAWN BY:

COLIN & JOANNE GOSTELOW

RETAINING WALLS


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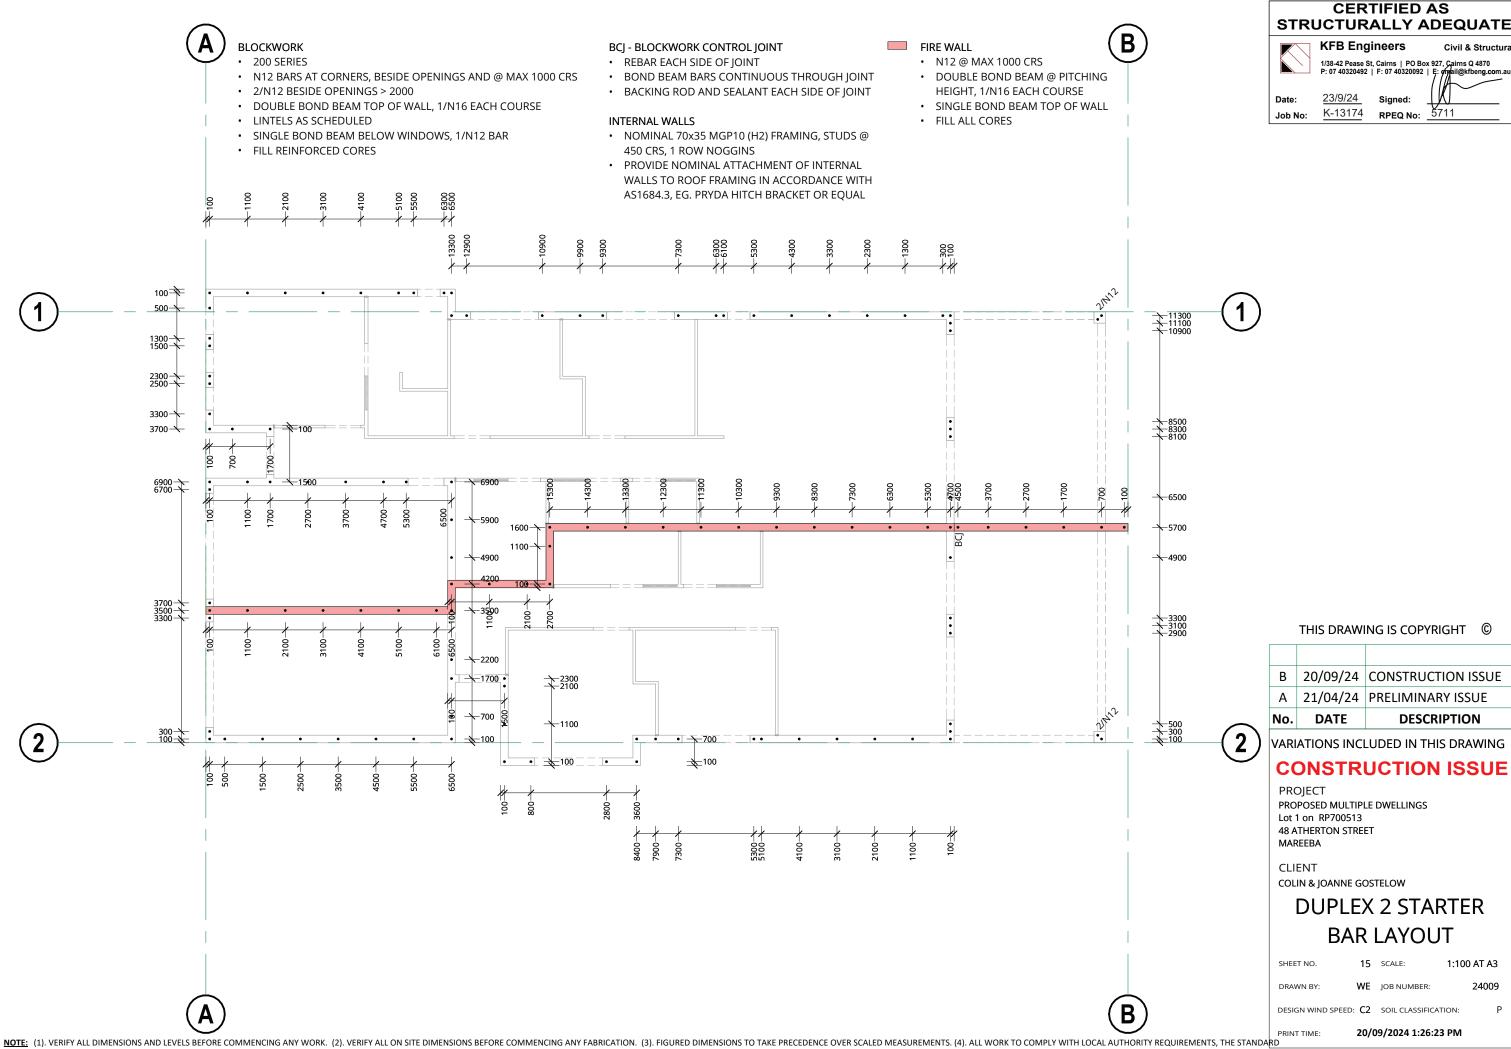
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13 SCALE: AS NOTED AT A3

24009


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Version: 1, Version Date: 13/12/2024


BUILDING BY-LAWS, THE BUILDING CODE OF AUSTRALIA AND RELEVANT AUSTRALIAN STANDARDS. (5). SUBSTITUTION OF ANY STRUCTRAL MEMBERS, & OR VARIATIONS TO ANY PART OF THE DESIGNILL VOID ANY RESPONSIBILITIES OF THE BUILDING DESIGNER FOR THE STRUCTURAL INTEGRITY & PERFORMANCE OF THE BUILDING DOcument Set ID: 4443120

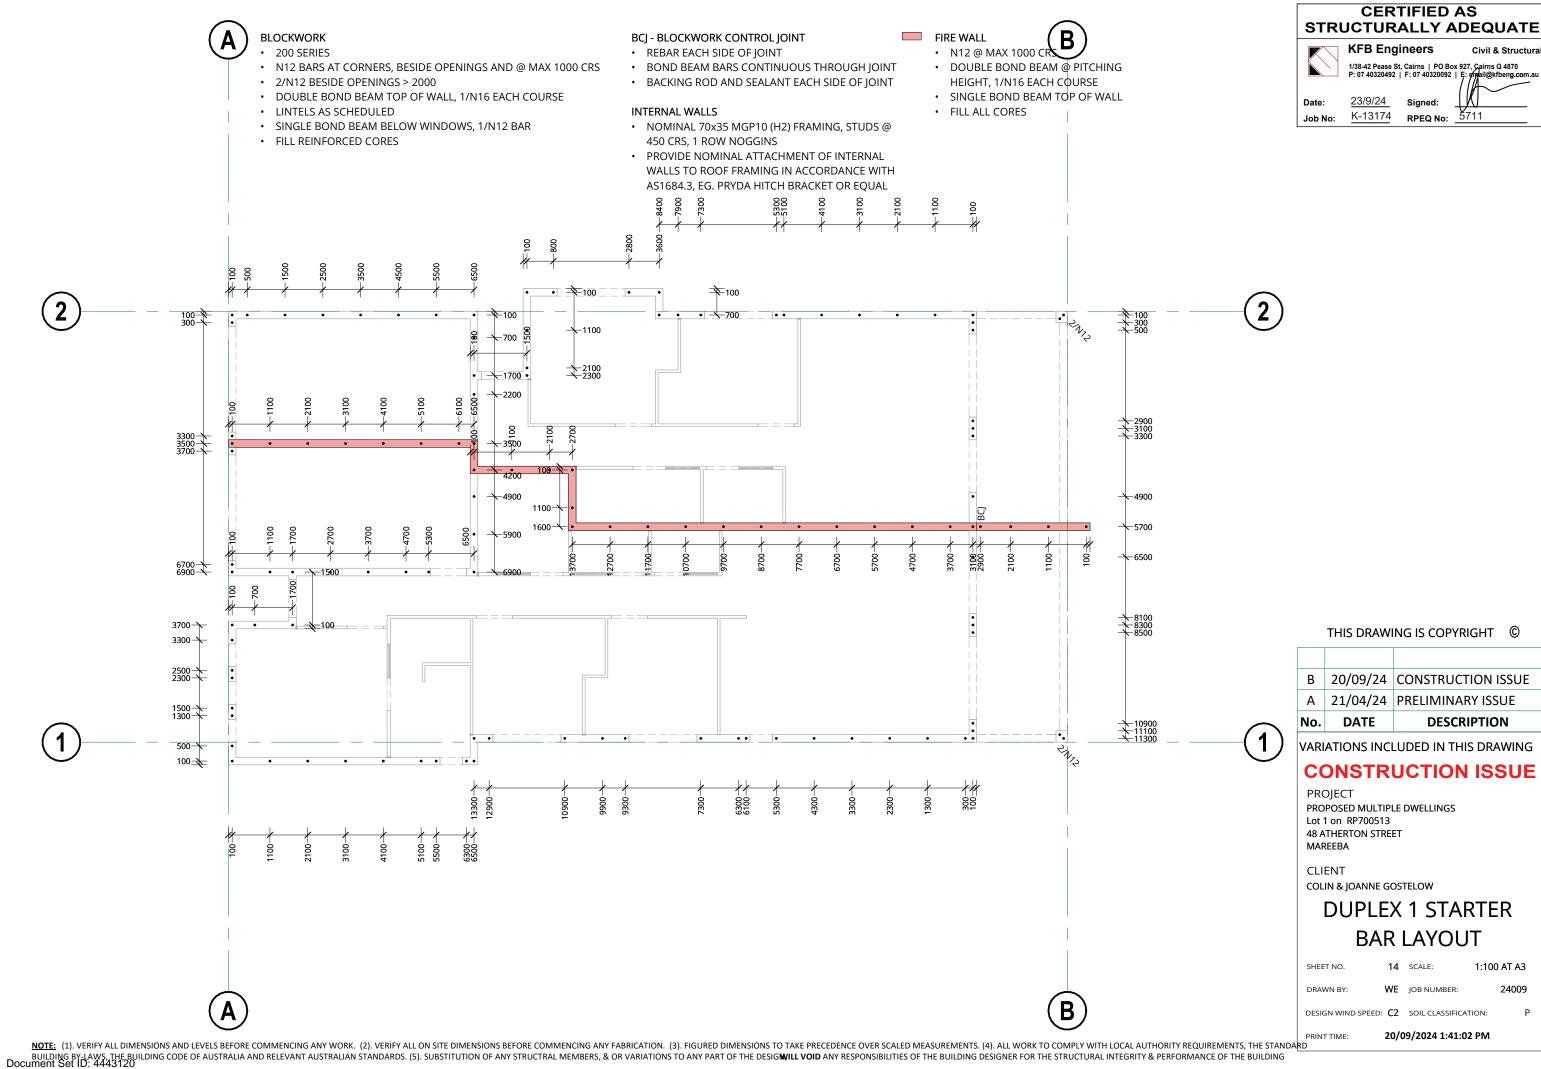

Version: 1, Version Date: 13/12/2024



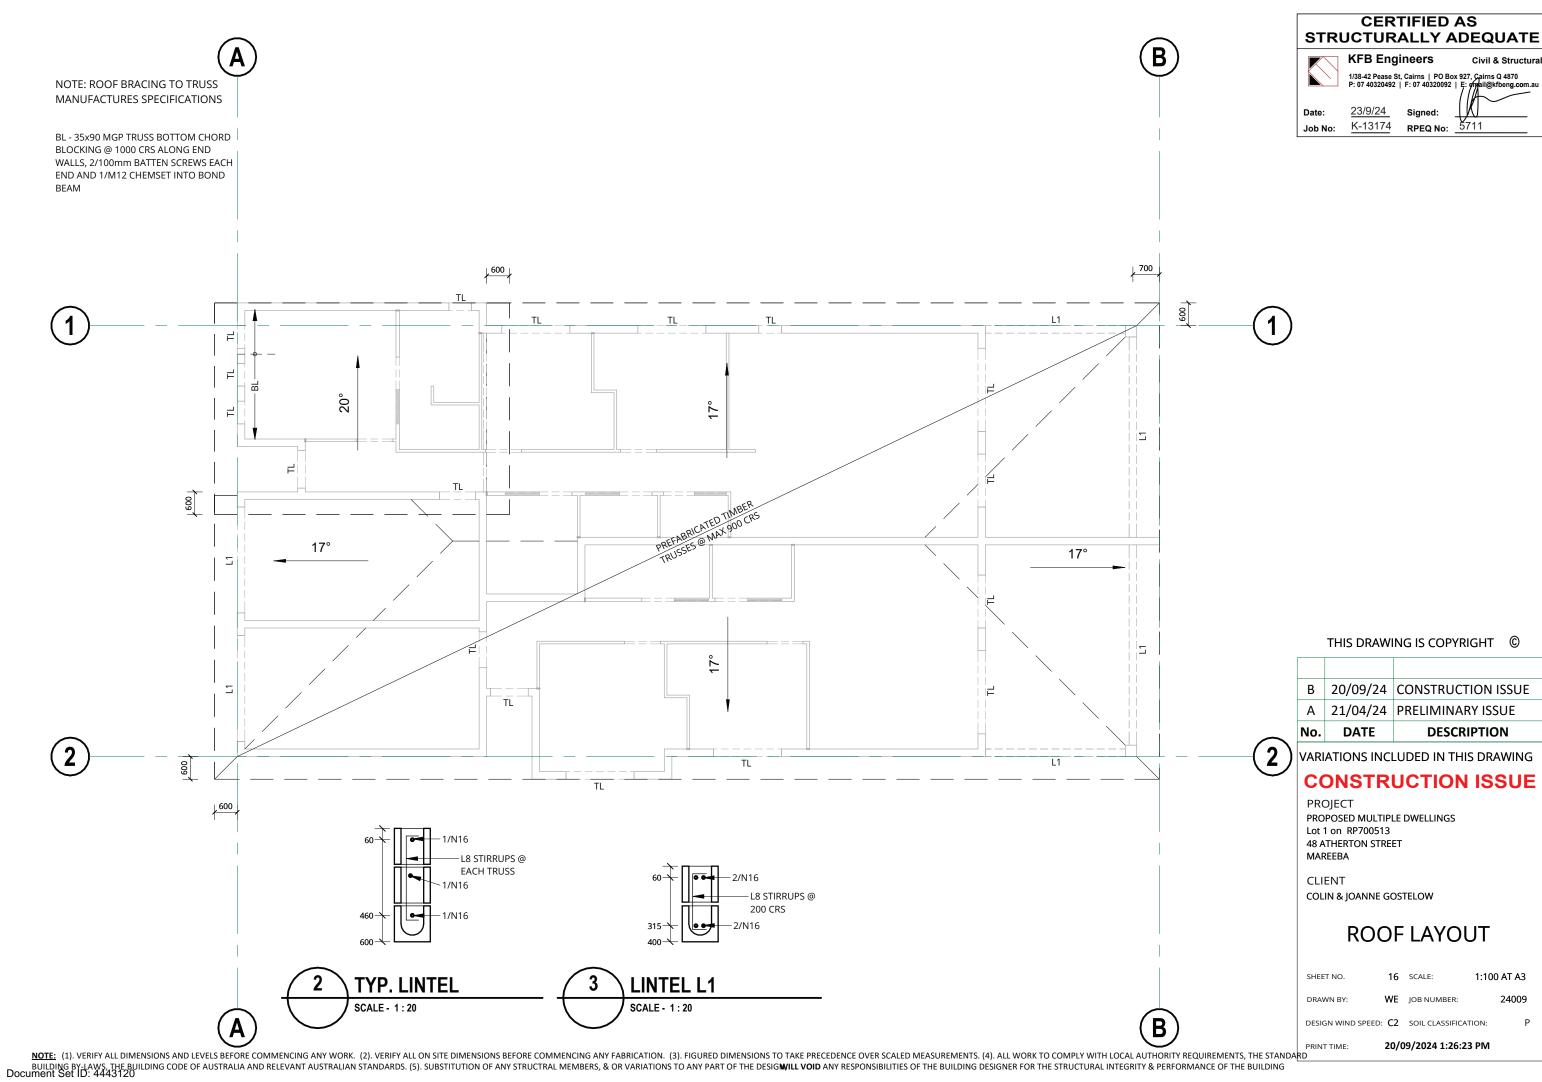

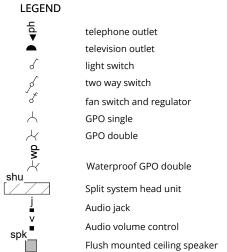

Data outlet

Metre Box

Split System Mechine



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CERTIFIED AS STRUCTURALLY ADEQUATE

Signed:

RPEQ No:

1/38-42 Pease St, Cairns | PO Box 927, Cairns Q 4870 P: 07 40320492 | F: 07 40320092 | E: email@kfbeng.com.ar

Civil & Structura

KFB Engineers

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CONSTRUCTION ISSUE

PROJECT

PROPOSED MULTIPLE DWELLINGS Lot 1 on RP700513 48 ATHERTON STREET MAREEBA

CLIENT


COLIN & JOANNE GOSTELOW

ELECTRICAL PLAN

1:100 AT A3 SHEET NO. 17 SCALE: 24009 DRAWN BY: WE JOB NUMBER:

DESIGN WIND SPEED: C2 SOIL CLASSIFICATION: 20/09/2024 1:26:24 PM

NOTE: (1). VERIFY ALL DIMENSIONS AND LEVELS BEFORE COMMENCING ANY WORK. (2). VERIFY ALL ON SITE DIMENSIONS BEFORE COMMENCING ANY FABRICATION. (3). FIGURED DIMENSIONS TO TAKE PRECEDENCE OVER SCALED MEASUREMENTS. (4). ALL WORK TO COMPLY WITH LOCAL AUTHORITY REQUIREMENTS, THE STANDARD BUILDING BY-LAWS, THE BUILDING CODE OF AUSTRALIA AND RELEVANT AUSTRALIAN STANDARDS. (5). SUBSTITUTION OF ANY STRUCTRAL MEMBERS, & OR VARIATIONS TO ANY PART OF THE DESIGNILL VOID ANY RESPONSIBILITIES OF THE BUILDING DESIGNER FOR THE STRUCTURAL INTEGRITY & PERFORMANCE OF THE BUILDING DOcument Set ID: 4443120

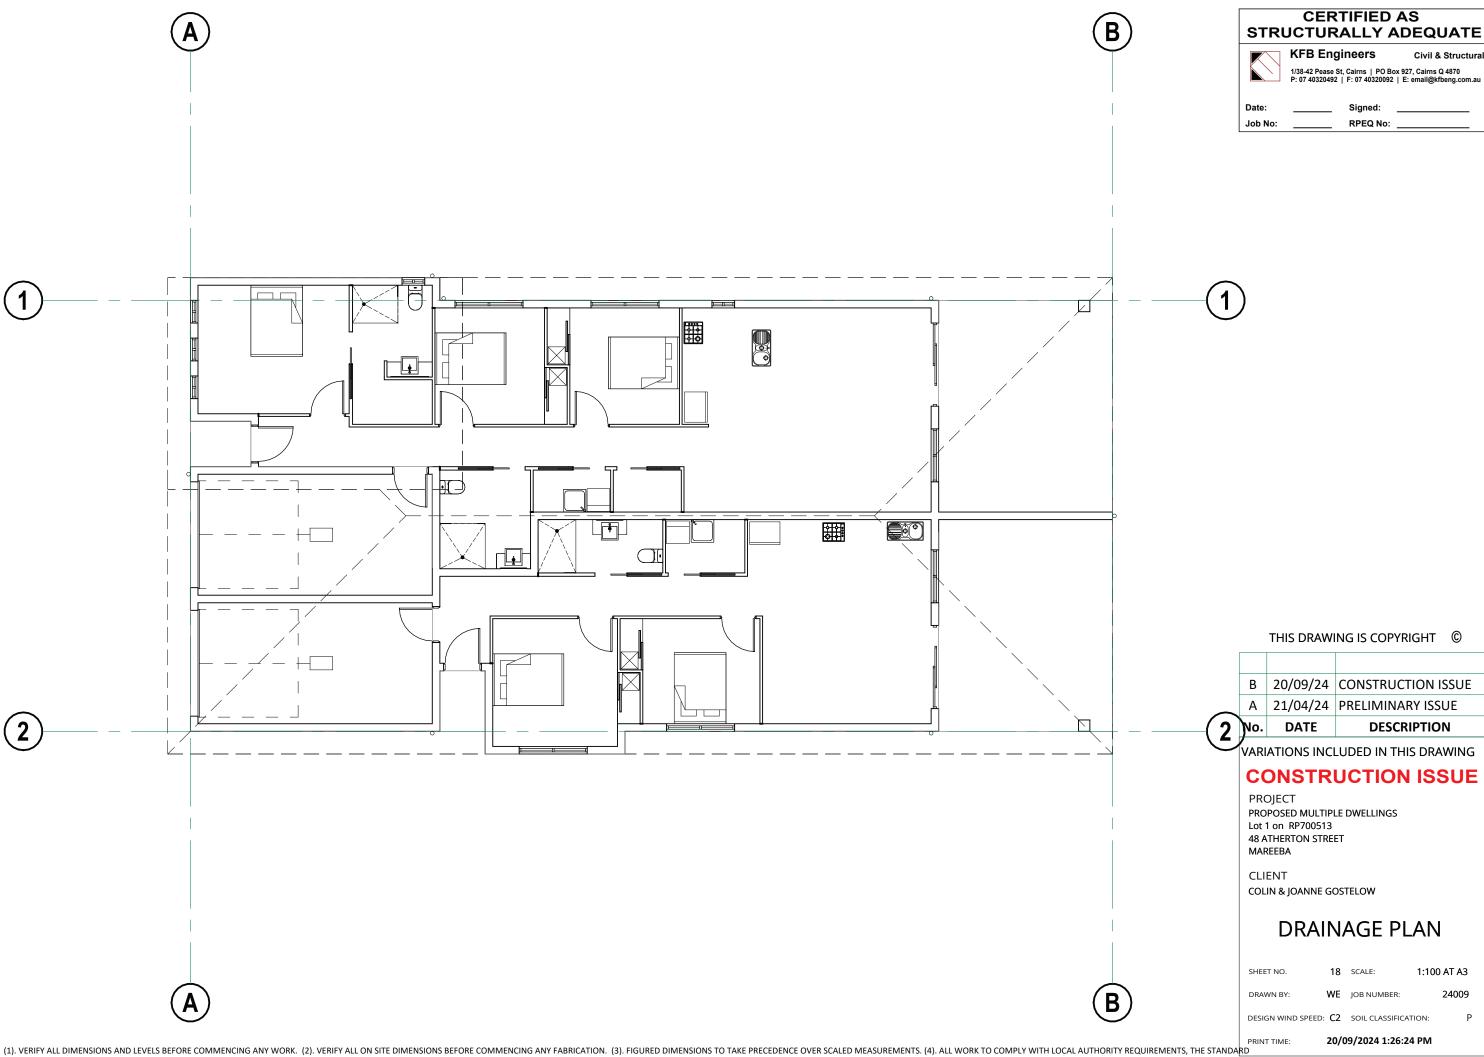

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DA Form 2 – Building work details

Approved form (version 1.2 effective 7 February 2020) made under Section 282 of the Planning Act 2016.

This form must be used to make a development application involving building work.

For a development application involving **building work only**, use this form (*DA Form 2*) only. The DA Forms Guide provides advice about how to complete this form.

For a development application involving **building work associated and any other type of assessable development** (i.e. material change of use, operational work or reconfiguring a lot), use *DA Form 1 – Development application details* **and** parts 4 to 6 of this form (*DA Form 2*).

Unless stated otherwise, all parts of this form **must** be completed in full and all required supporting information **must** accompany the development application.

One or more additional pages may be attached as a schedule to this development application if there is insufficient space on the form to include all the necessary information.

This form and any other form relevant to the development application must be used to make a development application relating to strategic port land and Brisbane core port land under the *Transport Infrastructure Act 1994*, and airport land under the *Airport Assets (Restructuring and Disposal) Act 2008*. For the purpose of assessing a development application relating to strategic port land and Brisbane core port land, any reference to a planning scheme is taken to mean a land use plan for the strategic port land, Brisbane port land use plan for Brisbane core port land, or a land use plan for airport land.

Note: All terms used in this form have the meaning given under the Planning Act 2016, the Planning Regulation 2017, or the Development Assessment Rules (DA Rules).

PART 1 – APPLICANT DETAILS

1) Applicant details	
Applicant name(s) (individual or company full name)	Reid Building
Contact name (only applicable for companies)	
Postal address (PO Box or street address)	8 Powell Road
Suburb	Mareeba
State	QLD
Postcode	4880
Country	Australia
Contact number	0408 965 396
Email address (non-mandatory)	irwinreid@westnet.com.au
Mobile number (non-mandatory)	
Fax number (non-mandatory)	
Applicant's reference number(s) (if applicable)	

PART 2 – LOCATION DETAILS



Unit No.	Street No.	Street Name and Type	Suburb	
	48	Atherton Street	Mareeba	
Postcode	Lot No.	Plan Type and Number (e.g. RP,	SP) Local Governi	ment Area(s)
4880	1	RP 700513	MSC	
2.2) Additional	premises			
Additional p	remises are rele	vant to this development applicat	ion and the details of the	ese premises have been
		s development application		
Not required ■ Not required ■ Not required ■ Not required ■ Not required Not req	d			
		ents over the premises?		
hote: Easement u	ses vary throughout (ct the proposed deve	Queensland and are to be identified corre lopment, see the <u>DA Forms Guide</u>	ctly and accurately. For furthe	r information on easements and
		s, types and dimensions are inclu	ided in plans submitted v	with this development
application		•	·	·
⊠ No				
PART 3 – F	URTHER DE	ETAILS		
4) Is the applic	ation only for buil	ding work assessable against the	e building assessment p	rovisions?
⊠ Yes – proce	ed to 8)			
☐ No				
5) Identify the a	assessment man	ager(s) who will be assessing thi	s development application	on
6) Has the loca	al government ag	reed to apply a superseded plani	ning scheme for this dev	elopment application?
· ·	•	notice is attached to this develop		
The local go	overnment is take	en to have agreed to the superse	ded planning scheme re	quest – relevant documents
□ No				
7) Information	request under Pa	rt 3 of the DA Rules		
,		tion request if determined neces	sary for this developmer	nt application
		nformation request for this develo	•	n approation
	•	rmation request I, the applicant, acknowle	•	
		will be assessed and decided based on the		
application and the assessment manager and any referral agencies relevant to the development application are not obligated under the DA Rules to accept any additional information provided by the applicant for the development application unless agreed to by the relevant				
parties.				
 Part 3 of the DA Rules will still apply if the application is an application listed under section 11.3 of the DA Rules. Further advice about information requests is contained in the <u>DA Forms Guide</u>. 				
The state of the s				
8) Are there any associated development applications or current approvals?				
Yes – provide details below or include details in a schedule to this development application				
⊠ No		15.6	.	
List of approva application	ı/development	Reference	Date	Assessment manager
Approval				
	nt application			
Approval				

☐ Development application

9) Has the portable long servi	ice leave levy been paid?				
⊠ Yes – a copy of the receip	ted QLeave form is attached	to this development app	olication		
			evy has been paid before the		
			t the assessment manager may		
	•		ervice leave levy has been paid		
	ng and construction work is le	· ·			
Amount paid	Date paid (dd/mm/yy)	QLeave levy	number (A, B or E)		
\$2718.00	25/10/2024	S396772			
10) Is this development applic	cation in response to a show	cause notice or required	d as a result of an enforcement		
notice?					
Yes – show cause or enfo	rcement notice is attached				
⊠ No					
11) Identify any of the followir	ng further legislative requiren	nents that apply to any a	spect of this development		
application					
☐ The proposed developmen					
	age Register . See the guida the development of a Queer		s.qld.gov.au about the		
	the development of a Queer				
Name of the heritage place:		Place ID:			
PART 4 – REFERRAL	DETAILS				
12) Does this development a	nnlication include any huildin	g work aspects that have	e any referral requirements?		
Yes – the <i>Referral checklis</i>	st for building work is attached	ed to this development a	pplication		
□ No – proceed to Part 5					
42)		San Alain alas salam manantan ma	- li 4i O		
13) Has any referral agency p	•	· · · · · · · · · · · · · · · · · · ·			
1 = ' ' ' '	received and listed below a	e attached to this develo	opment application		
⊠ No		T			
Referral requirement		Referral agency	Date referral response		
Identify and describe any cha	inges made to the proposed	development application	that was the subject of the		
Identify and describe any changes made to the proposed development application that was the subject of the referral response and this development application, or include details in a schedule to this development application					
(if applicable)	, ,,				
PART 5 – BUILDING V	NORK DETAILS				
14) Owner's details					
	the owner and proceed to 1	E) Othonuica marida th	a following information		
THE FICK II THE ADDITIONALIS AISC	The owner and proceed to 1	31. Otherwise, provide tr	ie ionowina imormation.		

Superannuation Fund

PO Box 224

Mareeba

J & C Gostelow Superannuation Fund Pty Ltd TTE J & C

Page 3 DA Form 2 – Building work details Version 1.2— 7 February 2020

Suburb

Name(s) (individual or company full name)

Contact name (applicable for companies)

Postal address (P.O. Box or street address)

State		QLD		
Postcode		4880		
Country		Australia		
Contact number		0458 220 279		
Email address (non-mandatory)		colingostelow57	@gmail.com	
Mobile number (non-mandatory)				
Fax number (non-mandatory)				
15) Builder's details				
☐ Tick if a builder has not yet be following information.	een engaged	d to undertake the	work and proceed to 1	6). Otherwise provide the
Name(s) (individual or company full n	ame)	Reid Building		
Contact name (applicable for compa	anies)			
QBCC licence or owner – builde	er number	15092798		
Postal address (P.O. Box or street a	address)	8 Powell Road		
Suburb		Mareeba		
State		QLD		
Postcode		4880		
Contact number		0408 965 396		
Email address (non-mandatory)		irwinreid@westnet.com.au		
Mobile number (non-mandatory)				
Fax number (non-mandatory)				
16) Provide details about the pro	•	ing work		
What type of approval is being s	sought?			
Development permit				
Preliminary approval				
b) What is the level of assessme	ent?			
Code assessment				
Impact assessment (requires public notification)				
c) Nature of the proposed building work (tick all applicable boxes) New building or structure Repairs, alterations or additions				
Change of building classification (involving build		huilding work)		pool and/or pool fence
Demolition		bullaring work)		'
Demolition Relocation or removal d) Provide a description of the work below or in an attached schedule.				
New construction of duplex				
e) Proposed construction materials				
e, reposed construction mater	Double I	brick	Steel	Curtain glass
External walls	Brick ve		☐ Timber	Aluminium
	Stone/co	oncrete	Fibre cement	Other
Framo			Steel	Aluminium
Frame	Other			
Floor			Timber	☐ Other
Roof covering	☐ Slate/co		Tiles	☐ Fibre cement
1.001 covering	☐ Aluminium		⊠ Steel	Other

f) Existing building use/classification? (if applicable)

g) New building use/classification? (if applicable)
1a & 10a
h) Relevant plans
Note: Relevant plans are required to be submitted for all aspects of this development application. For further information, see <u>DA Forms Guide</u> : <u>Relevant plans</u> .
Relevant plans of the proposed works are attached to the development application
17) What is the monetary value of the proposed building work?
\$520 000.00
18) Has Queensland Home Warranty Scheme Insurance been paid?

18) Has Queensland Home Warranty Scheme Insurance been paid? ☐ Yes – provide details below ☐ No Amount paid Date paid (dd/mm/yy) Reference number \$2988.40 21/10/2024 014858285

PART 6 – CHECKLIST AND APPLICANT DECLARATION

19) Development application checklist	
The relevant parts of Form 2 – Building work details have been completed	⊠ Yes
This development application includes a material change of use, reconfiguring a lot or operational work and is accompanied by a completed <i>Form 1 – Development application details</i>	☐ Yes ☑ Not applicable
Relevant plans of the development are attached to this development application Note: Relevant plans are required to be submitted for all aspects of this development application. For further information, see <u>DA Forms Guide</u> : Relevant plans.	⊠ Yes
The portable long service leave levy for QLeave has been paid, or will be paid before a development permit is issued (see 9)	☑ Yes☑ Not applicable

20) Applicant declaration	
🗵 By making this development application, I declare that all information in this development application is	true and
correct	
Where an email address is provided in Part 1 of this form, I consent to receive future electronic commu	nications
from the assessment manager and any referral agency for the development application where written	
information is required or permitted pursuant to sections 11 and 12 of the Electronic Transactions Act 2	2001
Note: It is unlawful to intentionally provide false or misleading information.	

Privacy – Personal information collected in this form will be used by the assessment manager and/or chosen assessment manager, any referral agency and/or building certifier (including any professional advisers which may be engaged by those entities) while processing, assessing and deciding the development application. All information relating to this development application may be available for inspection and purchase, and/or published on the assessment manager's and/or referral agency's website.

Personal information will not be disclosed for a purpose unrelated to the *Planning Act 2016*, Planning Regulation 2017 and the DA Rules except where:

- such disclosure is in accordance with the provisions about public access to documents contained in the *Planning Act 2016* and the Planning Regulation 2017, and the access rules made under the *Planning Act 2016* and Planning Regulation 2017; or
- required by other legislation (including the Right to Information Act 2009); or
- otherwise required by law.

This information may be stored in relevant databases. The information collected will be retained as required by the *Public Records Act 2002.*

PART 7 – FOR COMPLETION BY THE ASSESSMENT MANAGER – FOR OFFICE USE ONLY

Date received:	Reference	numbers:	
For completion by the bu	uildina certifier		
Classification(s) of appro			
1a & 10a			
Name		QBCC Certification Licence number	QBCC Insurance receipt number
		A80178	014858285
Notification of engageme	ent of alternative assessm	ent manager	
Prescribed assessment			
Name of chosen assessi			
Date chosen assessmen	it manager engaged		
Contact number of chose	en assessment manager		
Relevant licence number manager	r(s) of chosen assessmen	t	
	quired by the local govern	ment	
Confirm proposed constr			
Fotom done	Double brick	☐ Steel	☐ Curtain glass
External walls	☐ Brick veneer ☐ Stone/concret	☐ Timber e ☐ Fibre cement	☐ Aluminium ☐ Other
	☐ Storie/concret	Steel	Aluminium
Frame	☐ Other	∐ Steer	☐ Aluminium
Floor		☐ Timber	☐ Other
Roof covering	☐ Slate/concrete	e 🔲 Tiles	☐ Fibre cement
Troor covering	Aluminium	⊠ Steel	☐ Other
QLeave notification and Note: For completion by asses	. •		
Description of the work			
QLeave project number			
Amount paid (\$)		Date paid (dd/mm/yy)	
Date receipted form sighted by assessment manager		ger	
Name of officer who sigh	ted the form		
Additional building details	s required for the Australia	an Bureau of Statistics	
Existing building use/class	· · · · · · · · · · · · · · · · · · ·	an Baroda of Statistics	
New building use/classifi	. , , , , , , , , , , , , , , , , , , ,	1a & 10a	
Site area (m²)	2023	Floor area (m²)	284