DA Form 1 – Development application details

Approved form (version 1.1 effective 22 JUNE 2018) made under section 282 of the Planning Act 2016.

This form **must** be used to make a development application **involving code assessment or impact assessment**, except when applying for development involving building work.

For a development application involving building work only, use DA Form 2 – Building work details.

For a development application involving building work associated with any other type of assessable development (i.e. material change of use, operational work or reconfiguring a lot), use this form (*DA Form 1*) and parts 4 to 6 of *DA Form 2 – Building work details.*

Unless stated otherwise, all parts of this form **must** be completed in full and all required supporting information **must** accompany the development application.

One or more additional pages may be attached as a schedule to this development application if there is insufficient space on the form to include all the necessary information.

This form and any other form relevant to the development application must be used to make a development application relating to strategic port land and Brisbane core port land under the *Transport Infrastructure Act 1994*, and airport land under the *Airport Assets (Restructuring and Disposal) Act 2008*. For the purpose of assessing a development application relating to strategic port land and Brisbane core port land, any reference to a planning scheme is taken to mean a land use plan for the strategic port land, Brisbane port land use plan for Brisbane core port land, or a land use plan for airport land.

Note: All terms used in this form have the meaning given under the Planning Act 2016, the Planning Regulation 2017, or the Development Assessment Rules (DA Rules).

PART 1 – APPLICANT DETAILS

1) Applicant details	
Applicant name(s) (individual or company full name)	Terence Neville Wallace C/- Northern Building Approvals
Contact name (only applicable for companies)	Kenton Byrne
Postal address (P.O. Box or street address)	3b Margherita Close
Suburb	Mareeba
State	QLD
Postcode	4880
Country	Australia
Contact number	0447 865 265
Email address (non-mandatory)	kentonstella@bigpond.com
Mobile number (non-mandatory)	
Fax number (non-mandatory)	
Applicant's reference number(s) (if applicable)	DA/22/0042

2) Owner's consent

2.1) Is written consent of the owner required for this development application?

 \Box Yes – the written consent of the owner(s) is attached to this development application

No – proceed to 3)



PART 2 – LOCATION DETAILS

3) Location of the premises (complete 3.1) or 3.2), and 3.3) as applicable) Note : Provide details below and attach a site plan for any or all premises part of the development application. For further information, see <u>DA</u> <u>Forms Guide: Relevant plans</u> .								
3.1) Street address and lot on plan								
Street address AND lot on plan (all lots must be listed), or Street address AND lot on plan for an adjoining or adjacent property of the premises (appropriate for development in water but adjoining or adjacent to land e.g. jetty, pontoon; all lots must be listed).								
	Unit No.	Street I	vo. St	treet Name and	Туре	Suburb		
2)		231	W	alsh Street		Mareeba		
a)	Postcode	Lot No.	PI	Plan Type and Number (e.g. RP, SP)		Local Government Area(s)		
	4880	1	RI	P708211		Mareeba Shire Council		
	Unit No.	Street I	No. St	treet Name and	Туре	Suburb		
b)								
b)	Postcode	Lot No.	PI	an Type and Nu	mber (e.g. RP, SP)	Local Government Area(s)		
e.g. cha	nnel dredging i	n Moreton	Bay)		nt in remote areas, over part of a set of coordinates is required for	lot or in water not adjoining or adjacent to land r this part.		
				itude and latitud				
Longit			Latitude		Datum	Local Government Area(s) (if applicable)		
					WGS84			
					GDA94			
					Other:			
	ordinates of	premise	s by east	ing and northing				
Eastin	g(s)	North	ing(s)	Zone Ref.	Datum	Local Government Area(s) (if applicable)		
				54	WGS84			
$\Box 55 \qquad \Box \text{ GDA94}$								
3.3) Additional premises 56 Other:								
			relevant	to this develop	nent application and their	details have been attached in a		
	ule to this ap				nent application and their t	details have been attached in a		
🛛 Not	required	-						
4) Ider	ntify any of tl	ne follow	ing that a	apply to the pren	nises and provide any rele	vant details		
🗌 In c	or adjacent t	o a wate	r body or	watercourse or	in or above an aquifer			
Name	of water boo	dy, water	course o	r aquifer:				
🗌 On	strategic po	ort land u	nder the	Transport Infras	tructure Act 1994			
Lot on plan description of strategic port land:								
Name	of port auth	ority for t	he lot:					
🗌 In a	a tidal area							
Name of local government for the tidal area (if applicable):								
Name of port authority for tidal area (if applicable):								
□ On	On airport land under the Airport Assets (Restructuring and Disposal) Act 2008							

Name of airport:

Listed on the Environmental Management Register (EMR) under the Environmental Protection Act 1994					
EMR site identification:					
Listed on the Contaminated Land Register (CLR) under the Environmental Protection Act 1994					
CLR site identification:					

5) Are there any existing easements over the premises?

Note: Easement uses vary throughout Queensland and are to be identified correctly and accurately. For further information on easements and how they may affect the proposed development, see <u>DA Forms Guide</u>.

Yes – All easement locations,	types and dimensions are included in plans submitted with this development
application	

🛛 No

PART 3 – DEVELOPMENT DETAILS

Section 1 – Aspects of development

a) What is the type of development? (tick only one box)								
a) What is the type of development? (tick only one box)								
☐ Material change of use ☐ Reconfiguring a lot ☐ Operational work ⊠ Building work								
b) What is the approval type? (tick only one box)								
Development permit Preliminary approval Preliminary approval Preliminary approval Development permit								
a variation approval								
c) What is the level of assessment?								
Code assessment Impact assessment (requires public notification)								
d) Provide a brief description of the proposal (e.g. 6 unit apartment building defined as multi-unit dwelling, reconfiguration of 1 lot in lots):								
Proposed Duplex within the Side and Rear Planning Scheme Setbacks								
e) Relevant plans Note : Relevant plans are required to be submitted for all aspects of this development application. For further information, see <u>DA Forms guide</u> <u>Relevant plans.</u>								
Relevant plans of the proposed development are attached to the development application								
6.2) Provide details about the second development aspect								
a) What is the type of development? (tick only one box)								
Material change of use Reconfiguring a lot Operational work Building work								
b) What is the approval type? (tick only one box)								
Development permit Preliminary approval Preliminary approval that includes a variation approval								
c) What is the level of assessment?								
Code assessment Impact assessment (requires public notification)								
d) Provide a brief description of the proposal (e.g. 6 unit apartment building defined as multi-unit dwelling, reconfiguration of 1 lot into 3 lots):								
e) Relevant plans Note : Relevant plans are required to be submitted for all aspects of this development application. For further information, see <u>DA Forms Guide:</u> <u>Relevant plans.</u>								
Relevant plans of the proposed development are attached to the development application								

6.3) Additional aspects of development

Additional aspects of development are relevant to this development application and the details for these aspects that would be required under Part 3 Section 1 of this form have been attached to this development application Not required

Section 2 - Further development details

7) Does the proposed development application involve any of the following?				
Material change of use	Yes – complete division 1 if assessable against a local planning instrument			
Reconfiguring a lot	Yes – complete division 2			
Operational work	Yes – complete division 3			
Building work	X Yes – complete DA Form 2 – Building work details			

Division 1 – Material change of use **Note**: This division is only required to be completed if any part of the development application involves a material change of use assessable against a local planning instrument.

8.1) Describe the proposed material char	nge of use				
Provide a general description of the proposed use		anning scheme definiti inition in a new row)		Number of dwelling units <i>(if applicable)</i>	Gross floor area (m ²)
					(if applicable)
8.2) Does the proposed use involve the u	ise of existing b	ouildings on the premis	ses?		
🗌 Yes					
□ No					

Division 2 – Reconfiguring a lot **Note**: This division is only required to be completed if any part of the development application involves reconfiguring a lot.

9.1) What is the total number of existing lots making up the premises?
9.2) What is the nature of the lot reconfiguration? (tick all applicable boxes)

0.2) What is the nature of the lot reconfiguration (liek an applicable boxes)				
Subdivision (complete 10))	Dividing land into parts by agreement (complete 11))			
Boundary realignment (complete 12))	Creating or changing an easement giving access to a lot from a construction road <i>(complete 13))</i>			

10) Subdivision 10.1) For this development, how many lots are being created and what is the intended use of those lots:							
Intended use of lots created	Residential	Commercial	Industrial	Other, please specify:			
Number of lots created	Number of lots created						
10.2) Will the subdivision be staged?							
Yes – provide additional details below							
No							
How many stages will the works include?							
What stage(s) will this development application apply to?							

11) Dividing land into parts by agreement – how many parts are being created and what is the intended use of the parts?							
Intended use of parts created	Residential	Commercial	Industrial	Other, please specify:			
Number of parts created							

12) Boundary realignment								
12.1) What are the current and proposed areas for each lot comprising the premises?								
Current lot Proposed lot								
Lot on plan description	Area (m ²)	Lot on plan description Area (m ²)						
12.2) What is the reason for the boundary realignment?								

13) What are the dimensions and nature of any existing easements being changed and/or any proposed easement? (attach schedule if there are more than two easements)				
Existing or proposed?	Width (m)	Length (m)	Purpose of the easement? (e.g. pedestrian access)	Identify the land/lot(s) benefitted by the easement

Division 3 – Operational work

Note: This division is only required to be completed if any part of the development application involves operational work.

14.1) What is the nature of the operational work?				
Road work	Stormwater	Water infrastructure		
Drainage work	Earthworks	Sewage infrastructure		
Landscaping	🗌 Signage	Clearing vegetation		
Other – please specify:				
14.2) Is the operational work necessary to	facilitate the creation of I	new lots? (e.g. subdivision)		
Yes – specify number of new lots:				
No				
14.3) What is the monetary value of the proposed operational work? (include GST, materials and labour)				
\$				

PART 4 – ASSESSMENT MANAGER DETAILS

15) Identify the assessment manager(s) who will be assessing this development application

Mareeba Shire Council

16) Has the local government agreed to apply a superseded planning scheme for this development application?

Yes – a copy of the decision notice is attached to this development application

Local government is taken to have agreed to the superseded planning scheme request – relevant documents attached

🛛 No

PART 5 - REFERRAL DETAILS

17) Do any aspects of the proposed development require referral for any referral requirements? <i>Note:</i> A development application will require referral if prescribed by the Planning Regulation 2017.
☑ No, there are no referral requirements relevant to any development aspects identified in this development application – proceed to Part 6
Matters requiring referral to the Chief Executive of the Planning Regulation 2017:
Clearing native vegetation
Contaminated land (unexploded ordnance)
Environmentally relevant activities (ERA) (only if the ERA have not been devolved to a local government)
Fisheries – aquaculture
Fisheries – declared fish habitat area
Fisheries – marine plants
Fisheries – waterway barrier works
Hazardous chemical facilities
Queensland heritage place (on or near a Queensland heritage place)
Infrastructure – designated premises
Infrastructure – state transport infrastructure
Infrastructure – state transport corridors and future state transport corridors
Infrastructure – state-controlled transport tunnels and future state-controlled transport tunnels
Infrastructure – near a state-controlled road intersection
On Brisbane core port land near a State transport corridor or future State transport corridor
On Brisbane core port land – ERA
On Brisbane core port land – tidal works or work in a coastal management district
On Brisbane core port land – hazardous chemical facility
On Brisbane core port land – taking or interfering with water
On Brisbane core port land – referable dams
On Brisbane core port land - fisheries
Land within Port of Brisbane's port limits
SEQ development area
SEQ regional landscape and rural production area or SEQ rural living area – tourist activity or sport and recreation activity
SEQ regional landscape and rural production area or SEQ rural living area – community activity
SEQ regional landscape and rural production area or SEQ rural living area – indoor recreation
SEQ regional landscape and rural production area or SEQ rural living area – urban activity
SEQ regional landscape and rural production area or SEQ rural living area – combined use
Tidal works or works in a coastal management district
Reconfiguring a lot in a coastal management district or for a canal
Erosion prone area in a coastal management district
Urban design
Water-related development – taking or interfering with water
Water-related development – removing quarry material (from a watercourse or lake)
Water-related development – referable dams
Water-related development – construction of new levees or modification of existing levees (category 3 levees only)
Wetland protection area
Matters requiring referral to the local government:
Airport land
Environmentally relevant activities (ERA) (only if the ERA have been devolved to local government)
Local heritage places

Matters requiring referral to the chief executive of the distribution entity or transmission entity:
Matters requiring referral to:
The Chief executive of the holder of the licence, if not an individual
The holder of the licence, if the holder of the licence is an individual
Oil and gas infrastructure
Matters requiring referral to the Brisbane City Council:
Brisbane core port land
Matters requiring referral to the Minister under the Transport Infrastructure Act 1994:
Brisbane core port land (inconsistent with Brisbane port LUP for transport reasons)
Strategic port land
Matters requiring referral to the relevant port operator:
Land within Port of Brisbane's port limits (below high-water mark)
Matters requiring referral to the Chief Executive of the relevant port authority:
Land within limits of another port (below high-water mark)
Matters requiring referral to the Gold Coast Waterways Authority:
Tidal works, or work in a coastal management district in Gold Coast waters
Matters requiring referral to the Queensland Fire and Emergency Service:
Tidal works marina (more than six vessel berths)

18) Has any referral agency provided a referral response for this development application?			
 Yes – referral response(s) received and listed below are attached to this development application No 			
Referral requirement	Referral agency	Date of referral response	
Identify and describe any changes made to the proposed development application that was the subject of the referral response and the development application the subject of this form, or include details in a schedule to this development application <i>(if applicable).</i>			

PART 6 – INFORMATION REQUEST

19) Information request under Part 3 of the DA Rules

I agree to receive an information request if determined necessary for this development application

I do not agree to accept an information request for this development application

Note: By not agreeing to accept an information request I, the applicant, acknowledge:

 that this development application will be assessed and decided based on the information provided when making this development application and the assessment manager and any referral agencies relevant to the development application are not obligated under the DA Rules to accept any additional information provided by the applicant for the development application unless agreed to by the relevant parties
 Rest 2 of the DA Rules will still each will still each will still apply application is an explication index parties

• Part 3 of the DA Rules will still apply if the application is an application listed under section 11.3 of the DA Rules.

Further advice about information requests is contained in the DA Forms Guide.

PART 7 – FURTHER DETAILS

20) Are there any associated development applications or current approvals? (e.g. a preliminary approval)			
 Yes – provide details below or include details in a schedule to this development application ⋈ No 			
List of approval/development application references	Reference number	Date	Assessment manager
Approval Development application			
Approval Development application			

21) Has the portable long service leave levy been paid? (only applicable to development applications involving building work or operational work)

☐ Yes – a copy of the receipted QLeave form is attached to this development application
 ☐ No – I, the applicant will provide evidence that the portable long service leave levy has been paid before the assessment manager decides the development application. I acknowledge that the assessment manager may give a development approval only if I provide evidence that the portable long service leave levy has been paid
 ☑ Not applicable (e.g. building and construction work is less than \$150,000 excluding GST)

Amount paid	Date paid (dd/mm/yy)	QLeave levy number
\$		

22) Is this development application in response to a show cause notice or required as a result of an enforcement notice?

Yes – show cause or enforcement notice is attached
 No

23) Further legislative requirements

Environmentally relevant activities

23.1) Is this development application also taken to be an application for an environmental authority for an **Environmentally Relevant Activity (ERA)** under section 115 of the *Environmental Protection Act* 1994?

Yes – the required attachment (form ESR/2015/1791) for an application for an environmental authority accompanies this development application, and details are provided in the table below				
🛛 No				
Note : Application for an environmental authority can be found by searching "ESR/2015/1791" as a search term at <u>www.qld.gov.au</u> . An ERA requires an environmental authority to operate. See <u>www.business.qld.gov.au</u> for further information.				
Proposed ERA number:		Proposed ERA threshold:		
Proposed ERA name:				

Multiple ERAs are applicable to this development application and the details have been attached in a schedule to this development application.

Hazardous chemical facilities

23.2) Is this development application for a hazardous chemical facility?

Yes – Form 69: Notification of a facility exceeding 10% of schedule 15 threshold is attached to this development application

🛛 No

Note: See www.business.qld.gov.au for further information about hazardous chemical notifications.

Clearing native vegetation

23.3) Does this development application involve clearing native vegetation that requires written confirmation that the chief executive of the <i>Vegetation Management Act 1999</i> is satisfied the clearing is for a relevant purpose under section 22A of the <i>Vegetation Management Act 1999</i> ?
 Yes – this development application includes written confirmation from the chief executive of the <i>Vegetation</i> <i>Management Act 1999</i> (s22A determination) No
Note : 1. Where a development application for operational work or material change of use requires a s22A determination and this is not included, the development application is prohibited development. 2. See <u>https://www.qld.gov.au/environment/land/vegetation/applying</u> for further information on how to obtain a s22A determination.
Environmental offsets
23.4) Is this development application taken to be a prescribed activity that may have a significant residual impact on a prescribed environmental matter under the <i>Environmental Offsets Act 2014</i> ?
 Yes – I acknowledge that an environmental offset must be provided for any prescribed activity assessed as having a significant residual impact on a prescribed environmental matter No
Note : The environmental offset section of the Queensland Government's website can be accessed at <u>www.qld.gov.au</u> for further information on environmental offsets.
Koala conservation
23.5) Does this development application involve a material change of use, reconfiguring a lot or operational work within an assessable development area under Schedule 10, Part 10 of the Planning Regulation 2017?
No Note: See guidance materials at <u>www.des.gld.gov.au</u> for further information.
Water resources
23.6) Does this development application involve taking or interfering with underground water through an artesian or subartesian bore, taking or interfering with water in a watercourse, lake or spring, or taking overland flow water under the <i>Water Act 2000</i> ?
 ☐ Yes – the relevant template is completed and attached to this development application and I acknowledge that a relevant authorisation or licence under the <i>Water Act 2000</i> may be required prior to commencing development ☑ No
Note : Contact the Department of Natural Resources, Mines and Energy at <u>www.dnrme.qld.gov.au</u> for further information.
DA templates are available from https://planning.dsdmip.qld.gov.au/. If the development application involves:
 Taking or interfering with underground water through an artesian or subartesian bore: complete DA Form 1 Template 1 Taking or interfering with water in a watercourse, lake or spring: complete DA Form1 Template 2
 Taking or menering with water in a watercourse, race of spining, complete DA Form Femplate 2 Taking overland flow water: complete DA Form 1 Template 3.
Waterway barrier works
23.7) Does this application involve waterway barrier works?
 Yes – the relevant template is completed and attached to this development application No
DA templates are available from <u>https://planning.dsdmip.qld.gov.au/</u> . For a development application involving waterway barrier works, complete DA Form 1 Template 4.
Marine activities
23.8) Does this development application involve aquaculture, works within a declared fish habitat area or removal, disturbance or destruction of marine plants?
Yes – an associated <i>resource</i> allocation authority is attached to this development application, if required under the <i>Fisheries Act 1994</i>
No Note: See guidance materials at www.daf.gld.gov.au for further information.
Quarry materials from a watercourse or lake
23.9) Does this development application involve the removal of quarry materials from a watercourse or lake

Yes – I acknowledge that a quarry material allocation notice must be obtained prior to commencing developmen	t
No Note : Contact the Department of Natural Resources, Mines and Energy at <u>www.dnrme.qld.gov.au</u> and <u>www.business.qld.gov.au</u> for further	
information.	
Quarry materials from land under tidal waters	
23.10) Does this development application involve the removal of quarry materials from land under tidal water under the <i>Coastal Protection and Management Act</i> 1995?	
 Yes – I acknowledge that a quarry material allocation notice must be obtained prior to commencing developmen No 	t
Note: Contact the Department of Environment and Science at <u>www.des.qld.gov.au</u> for further information.	
Referable dams	
23.11) Does this development application involve a referable dam required to be failure impact assessed under section 343 of the <i>Water Supply (Safety and Reliability) Act 2008</i> (the Water Supply Act)?	
Yes – the 'Notice Accepting a Failure Impact Assessment' from the chief executive administering the Water Supply Act is attached to this development application	
No Note : See guidance materials at <u>www.dnrme.qld.gov.au</u> for further information.	
Tidal work or development within a coastal management district	
23.12) Does this development application involve tidal work or development in a coastal management district?	
Yes – the following is included with this development application:	
Evidence the proposal meets the code for assessable development that is prescribed tidal work (only required if application involves prescribed tidal work)	d
A certificate of title	
No	
No <i>Note:</i> See guidance materials at <u>www.des.qld.gov.au</u> for further information.	
No Note: See guidance materials at <u>www.des.qld.gov.au</u> for further information. Queensland and local heritage places	
No <i>Note:</i> See guidance materials at <u>www.des.qld.gov.au</u> for further information.	
 No Note: See guidance materials at <u>www.des.qld.gov.au</u> for further information. Queensland and local heritage places 23.13) Does this development application propose development on or adjoining a place entered in the Queensland 	
 No Note: See guidance materials at <u>www.des.qld.gov.au</u> for further information. Queensland and local heritage places 23.13) Does this development application propose development on or adjoining a place entered in the Queensland heritage register or on a place entered in a local government's Local Heritage Register? Yes – details of the heritage place are provided in the table below No 	
 No Note: See guidance materials at <u>www.des.qld.gov.au</u> for further information. Queensland and local heritage places 23.13) Does this development application propose development on or adjoining a place entered in the Queensland heritage register or on a place entered in a local government's Local Heritage Register? Yes – details of the heritage place are provided in the table below No No Note: See guidance materials at <u>www.des.qld.gov.au</u> for information requirements regarding development of Queensland heritage places. 	
 No Note: See guidance materials at <u>www.des.qld.gov.au</u> for further information. Queensland and local heritage places 23.13) Does this development application propose development on or adjoining a place entered in the Queensland heritage register or on a place entered in a local government's Local Heritage Register? Yes – details of the heritage place are provided in the table below No 	
 No Note: See guidance materials at <u>www.des.qld.gov.au</u> for further information. Queensland and local heritage places 23.13) Does this development application propose development on or adjoining a place entered in the Queensland heritage register or on a place entered in a local government's Local Heritage Register? Yes – details of the heritage place are provided in the table below No No Note: See guidance materials at <u>www.des.qld.gov.au</u> for information requirements regarding development of Queensland heritage places. 	
 No Note: See guidance materials at <u>www.des.qld.gov.au</u> for further information. Queensland and local heritage places 23.13) Does this development application propose development on or adjoining a place entered in the Queensland heritage register or on a place entered in a local government's Local Heritage Register? Yes – details of the heritage place are provided in the table below No Note: See guidance materials at <u>www.des.qld.gov.au</u> for information requirements regarding development of Queensland heritage places. Name of the heritage place: 	
 No Note: See guidance materials at <u>www.des.gld.gov.au</u> for further information. Queensland and local heritage places 23.13) Does this development application propose development on or adjoining a place entered in the Queensland heritage register or on a place entered in a local government's Local Heritage Register? Yes – details of the heritage place are provided in the table below No Note: See guidance materials at <u>www.des.gld.gov.au</u> for information requirements regarding development of Queensland heritage places. Name of the heritage place: Place ID: Brothels 23.14) Does this development application involve a material change of use for a brothel? Yes – this development application demonstrates how the proposal meets the code for a development application for a brothel under Schedule 3 of the <i>Prostitution Regulation 2014</i> 	
 No Note: See guidance materials at <u>www.des.qld.gov.au</u> for further information. Queensland and local heritage places 23.13) Does this development application propose development on or adjoining a place entered in the Queensland heritage register or on a place entered in a local government's Local Heritage Register? Yes – details of the heritage place are provided in the table below No Note: See guidance materials at <u>www.des.qld.gov.au</u> for information requirements regarding development of Queensland heritage places. Name of the heritage place: Place ID: Brothels 23.14) Does this development application demonstrates how the proposal meets the code for a development application demonstrates how the proposal meets the code for a development application for a brothel under Schedule 3 of the Prostitution Regulation 2014 No 	
No Note: See guidance materials at www.des.gld.gov.au for further information. Queensland and local heritage places 23.13) Does this development application propose development on or adjoining a place entered in the Queensland heritage register or on a place entered in a local government's Local Heritage Register? □ Yes – details of the heritage place are provided in the table below ○ No No Note: See guidance materials at www.des.gld.gov.au for information requirements regarding development of Queensland heritage places. Name of the heritage place: Place ID: Brothels 23.14) Does this development application demonstrates how the proposal meets the code for a development application for a brothel under Schedule 3 of the Prostitution Regulation 2014 ○ No Decision under section 62 of the Transport Infrastructure Act 1994	
No Note: See guidance materials at www.des.gld.gov.au for further information. Queensland and local heritage places 23.13) Does this development application propose development on or adjoining a place entered in the Queensland heritage register or on a place entered in a local government's Local Heritage Register? □ Yes – details of the heritage place are provided in the table below No Note: See guidance materials at www.des.gld.gov.au for information requirements regarding development of Queensland heritage places. Name of the heritage place: Place ID: Brothels 23.14) Does this development application demonstrates how the proposal meets the code for a development application for a brothel under Schedule 3 of the Prostitution Regulation 2014 ○ No Decision under section 62 of the Transport Infrastructure Act 1994 23.15) Does this development application involve new or changed access to a state-controlled road?	
No Note: See guidance materials at www.des.gld.gov.au for further information. Queensland and local heritage places 23.13) Does this development application propose development on or adjoining a place entered in the Queensland heritage register or on a place entered in a local government's Local Heritage Register? ☐ Yes – details of the heritage place are provided in the table below ⊠ No Note: See guidance materials at www.des.gld.gov.au for information requirements regarding development of Queensland heritage places. Name of the heritage place: Place ID: Brothels 23.14) Does this development application involve a material change of use for a brothel? ☐ Yes – this development application demonstrates how the proposal meets the code for a development application for a brothel under Schedule 3 of the Prostitution Regulation 2014 ☑ No Decision under section 62 of the Transport Infrastructure Act 1994 23.15) Does this development application involve new or changed access to a state-controlled road? ☐ Yes - this application will be taken to be an application for a decision under section 62 of the Transport Infrastructure Act 1994 (subject to the conditions in section 75 of the Transport Infrastructure Act 1994 being	
No Note: See guidance materials at www.des.gld.gov.au for further information. Queensland and local heritage places 23.13) Does this development application propose development on or adjoining a place entered in the Queensland heritage register or on a place entered in a local government's Local Heritage Register? □ Yes – details of the heritage place are provided in the table below No Note: See guidance materials at www.des.gld.gov.au for information requirements regarding development of Queensland heritage places. Name of the heritage place: Place ID: Brothels 23.14) Does this development application involve a material change of use for a brothel? □ Yes – this development application demonstrates how the proposal meets the code for a development application for a brothel under Schedule 3 of the Prostitution Regulation 2014 ○ No Decision under section 62 of the Transport Infrastructure Act 1994 23.15) Does this development application involve new or changed access to a state-controlled road? □ Yes - this application will be taken to be an application for a decision under section 62 of the Transport	

PART 8 – CHECKLIST AND APPLICANT DECLARATION

24) Development application checklist	
I have identified the assessment manager in question 15 and all relevant referral requirement(s) in question 17 <i>Note</i> : See the Planning Regulation 2017 for referral requirements	🛛 Yes
If building work is associated with the proposed development, Parts 4 to 6 of <i>DA Form 2</i> – <i>Building work details</i> have been completed and attached to this development application	⊠ Yes □ Not applicable
Supporting information addressing any applicable assessment benchmarks is with development application	
Note : This is a mandatory requirement and includes any relevant templates under question 23, a planning report and any technical reports required by the relevant categorising instruments (e.g. local government planning schemes, State Planning Policy, State Development Assessment Provisions). For further information, see <u>DA</u> <u>Forms Guide: Planning Report Template</u> .	🛛 Yes
Relevant plans of the development are attached to this development application Note : Relevant plans are required to be submitted for all aspects of this development application. For further information, see <u>DA Forms Guide: Relevant plans.</u>	🛛 Yes
The portable long service leave levy for QLeave has been paid, or will be paid before a	🗌 Yes
development permit is issued (see 21))	🛛 Not applicable

25) Applicant declaration

By making this development application, I declare that all information in this development application is true and correct

Where an email address is provided in Part 1 of this form, I consent to receive future electronic communications from the assessment manager and any referral agency for the development application where written information is required or permitted pursuant to sections 11 and 12 of the *Electronic Transactions Act 2001 Note: It is unlawful to intentionally provide false or misleading information.*

Privacy – Personal information collected in this form will be used by the assessment manager and/or chosen assessment manager, any relevant referral agency and/or building certifier (including any professional advisers which may be engaged by those entities) while processing, assessing and deciding the development application. All information relating to this development application may be available for inspection and purchase, and/or published on the assessment manager's and/or referral agency's website.

Personal information will not be disclosed for a purpose unrelated to the *Planning Act 2016*, Planning Regulation 2017 and the DA Rules except where:

- such disclosure is in accordance with the provisions about public access to documents contained in the *Planning Act 2016* and the Planning Regulation 2017, and the access rules made under the *Planning Act 2016* and Planning Regulation 2017; or
- required by other legislation (including the Right to Information Act 2009); or
- otherwise required by law.

This information may be stored in relevant databases. The information collected will be retained as required by the *Public Records Act 2002.*

PART 9 – FOR OFFICE USE ONLY

Date received:

Reference number(s):

Notification of engagement of alternative assessment manager	
Prescribed assessment manager	
Name of chosen assessment manager	
Date chosen assessment manager engaged	
Contact number of chosen assessment manager	

Relevant licence number(s) of chosen assessment	
manager	

QLeave notification and payment Note: For completion by assessment manager if applicable	
Description of the work	
QLeave project number	
Amount paid (\$)	
Date paid	
Date receipted form sighted by assessment manager	
Name of officer who sighted the form	

Planning Report for 231 Walsh Street, Mareeba QLD 4880 Proposed Duplex within Planning Scheme Side and Rear Boundary Setbacks

Prepared for: Terence Neville Wallace Prepared by: Northern Building Approvals

Site Description

231 Walsh Street Mareeba is located on the southern side of Mareeba Township. The property is described as Lot 1 on Plan SP217448. The subject lot is 1012m² in size. The land is currently zoned Medium Density Residential Zone under the current Mareeba Shire Planning Scheme. The property has one existing dwellings with a carport. Below is an image showing the subject land.



Development Proposal

This application is for Building Works assessable against the Mareeba Shire Planning Scheme:

- Level of Assessment -- Code Assessment
- Assessment Criteria Medium Density Residential Zone Code

Attachment 1 are the plans of the proposed duplex development.

Referrals

No referrals are required.

Planning Assessment Summary

This development is for building work; proposed duplex. The development is within the Medium Density Residential zone. The location of the proposed duplex is in the planning scheme side and rear boundary setbacks trigger.

Moreover, the proposed duplex comprises of two dwelling units in addition to the existing dwelling house. The fact is that development is appropriate for this size lot, the character and amenity of the surrounding medium density residential area. Furthermore, the development generally complies with all relevant aspects of the planning scheme, except, the side and rear setbacks. The proposed setbacks are 1.5m to the outer most projection (OMP) from the southern side boundary, 1.629m to the OMP from the northern boundary and 1.5m to the OMP from the eastern rear boundary. The siting is consistent with Queensland Development Code MP 1.3 Design and Siting Standard for Duplex Housing and surrounding development. Additionally, this siting does not overlook or limit ventilation or daylight to any neighboring properties. Moreover, the siting provides suitable access to ventilation or daylight.

The property is 1012m² which will comply with the density of accommodation of the zone for the existing dwelling house with proposed two dwelling units and contributes to housing choice and affordability of housing within the town. Your swift action to approve this development is appreciated

Mandatory Supporting Information

Assessment of application against relevant Development Codes

- The following Development Codes are considered to be applicable to the assessment of the application:
- 6.2.7 Medium density residential zone code

6.2.7 Medium density residential zone code

6.2.7.1 Application

- (1) This code applies to assessing development where:
 - (a) located in the Medium density residential zone; and
 - (b) it is identified in the assessment benchmarks for assessable development and requirements for accepted development column of an assessment table in Part 5 of the planning scheme.

6.2.7.2 Purpose

- (1) The purpose of the medium density residential zone code is to provide for medium density multiple dwellings supported by community uses and small-scale services and facilities that cater for local residents.
- (2) Mareeba Shire Council's purpose of the Medium density residential zone code is to facilitate medium residential densities and a diversity of housing which caters for a range of households in locations which are proximate to town centres, community facilities and open space.

Small lot housing is facilitated and medium density development may include Dual occupancy and Multiple dwelling development in the form of town houses, apartments and units.

- (3) The purpose of the code will be achieved through the following overall outcomes:
 - (a) Development provides a range of residential dwelling choices including Multiple dwellings in locations clustered around or near activity centres and transport networks;
 - (b) Development encourages and facilitates urban consolidation and the efficient use of physical and social infrastructure;
 - (c) Development is supported by employment nodes, community facilities and services, transport and commercial hubs where appropriate; Development provides and maintains a high level of amenity in the zone and is reflective of the desired character of the area;
 - (d) The scale and density of development facilitates an efficient land use pattern that supports safe and walkable neighbourhoods that are well connected to employment nodes, centres, open space and recreational areas, community services and educational opportunities;
 - (e) Other small-scale development that integrates personal employment and residential activities is encouraged, provided it complements local residential amenity;
 - (f) Development maintains a high level of residential amenity avoiding uses that introduce impacts associated with noise, hours of operation, traffic, advertising devices, visual amenity, privacy, lighting, odour and emissions;
 - (g) Non-residential development may be supported where such uses directly support the day to day needs of the immediate residential community; and
 - (h) Development responds to land constraints and mitigates any adverse impacts on adjacent land uses and the environment.

6.2.7.3 Criteria for assessment

 Table 6.2.7.3A—Medium density residential zone code - For accepted development

 subject to requirements and assessable development

Performance outcomes	Acceptable outcomes	Complies	Comments
For accepted development	subject to requirements ar	nd assessable dev	elopment
Height			
PO1 Building height takes into consideration and respects the following: (a) the height of existing buildings on adjoining premises; (b) the development potential, with respect to height, on adjoining premises; (c) the height of buildings in the vicinity of the site; (d) access to sunlight and daylight for the site and adjoining sites; (e) privacy and overlooking; and (f) site area and street frontage length.	AO1 Development has a maximum building height of: (a) 8.5 metres; and (b) 2 storeys above ground level.		About 4.6m
PO2 Domestic outbuildings: (a) do not dominate the lot on which they are located; and (b) are consistent with the scale and	AO2 Domestic outbuildings do not exceed: (a) 100m ² in gross floor area; and (b) 5.5 metres in height above	N/A	N/A

Performance outcomes	Acceptable outcomes	Complies	Comments
character of development in the Medium density residential zone.	natural ground level.		
Siting			
PO3 Development is sited in a manner that considers and respects: (a) the siting and use of adjoining premises; (b) access to sunlight and daylight for the site and	AO3.1 Buildings and structures include a minimum setback of: (a) 6 metres from the primary road frontage; and (b) 3 metres from any secondary road frontage.	~	>6m from road Boundary
adjoining sites; (c) privacy and overlooking; (d) opportunities for casual surveillance of adjoining public spaces; (e) air circulation and access to natural breezes; (f) appearance of building bulk; and (g) relationship with road corridors.	AO3.2 Buildings and structures include a minimum setback of 2 metres from side and rear boundaries.	×	The proposed setbacks are 1.5m to the outer most projection (OMP) from the southern side boundary, 1.629m to the OMP from the northern boundary and 1.5m to the OMP from the eastern rear boundary. The siting is consistent with Queensland Development Code MP 1.3 Design and Siting Standard for Duplex Housing and surrounding development. Additionally, this siting does not overlook or limit ventilation or daylight to

Accommodation density PO4 The density of Accommodation activities: (a) contributes to housing choice and affordability; (b) respects the nature and density of surrounding land use; (c) does not cause amenity impacts beyond the reasonable expectation of accommodation density for the zone; and (d) is commensurate to the scale and frontage of the site. Boildings and structures occupy the site in a manner that: (a) makes efficient use of land;	lies Comments
PO4 The density of Accommodation activities: (a) contributes to housing choice and affordability; (b) respects the nature and density of surrounding land use; (c) does not cause amenity impacts beyond the reasonable expectation of accommodation density for the zone; and (d) is commensurate to the scale and frontage of the site.AO4 Development provides a maximum density for Accommodation activities in compliance with Table 6.2.7.3B.Image: Compliance Accommodation activities in compliance with Table 6.2.7.3B.(c) does not cause amenity impacts beyond the reasonable expectation of accommodation density for the zone; and (d) is commensurate to the scale and frontage of the site.AO5FO5 Buildings and structures occupy the site in a manner that: (a) makes efficient use of land;AO5(a) makes efficient use of land;forss floor area does not exceed 600m².	any neighboring properties. Moreover, the siting provides suitable access to ventilation or daylight.
The density of Accommodation activities: (a) contributes to housing choice and affordability; (b) respects the nature and density of surrounding land use; (c) does not cause amenity impacts beyond the reasonable expectation of accommodation density for the zone; and (d) is commensurate to the scale and frontage of the site.Development provides a maximum density for Accommodation activities 	
PO5 AO5 Buildings and structures Gross floor area does not occupy the site in a manner exceed 600m ² . (a) makes efficient use of land;	The property is 1012m ² which will comply with the density of accommodation of the zone for the existing dwelling house with proposed two dwelling units and contributes to housing choice and affordability of housing within the town.
Buildings and structures occupy the site in a manner that: (a) makes efficient use of land;	
 (b) is consistent with the bulk and scale of surrounding buildings; and (c) appropriately balances built and natural features. 	The proposed building is 250m² in size.

Performance outcomes	Acceptable outcomes	Complies	Comments
Building design			
 PO6 Building facades are appropriately designed to: (a) include visual interest and architectural variation; (b) maintain and enhance the character of the surrounds; (c) provide opportunities for casual surveillance; (d) include a human scale; and (e) encourage occupation of outdoor space. 	AO6 Buildings include habitable space, pedestrian entrances and recreation space facing the primary road frontage.	✓	The design includes habitable space, pedestrian entrances and recreation space.
PO7 Development complements and integrates with the established built character of the Medium density residential zone, having regard to: (a) roof form and pitch; (b) eaves and awnings; (c) building materials, colours and textures; and (d) window and door size and location.	AO7 No acceptable outcome is provided.	~	The design is consistent with established built character of the Medium density residential zone.
Non-residential developme	nt		
PO8 Non-residential development: (a) is consistent with the scale of existing development;	AO8 No acceptable outcome is provided.	N/A	N/A

Performance outcomes	Acceptable outcomes	Complies	Comments
 (b) does not detract from the amenity of nearby residential uses; (c) directly supports the day to day needs of the immediate residential community; and (d) does not impact on the orderly provision of non-residential development in other locations in the shire. 			
Amenity			
PO9 Development must not detract from the amenity of the local area, having regard to: (a) noise; (b) hours of operation; (c) traffic; (d) advertising devices; (e) visual amenity; (f) privacy; (g) lighting; (h) odour; and (i) emissions.	AO9 No acceptable outcome is provided.	~	The design is consistent with established amenity of the local area
 PO10 Development must take into account and seek to ameliorate any existing negative environmental impacts, having regard to: (a) noise; (b) hours of operation; (c) traffic; (d) advertising devices; (e) visual amenity; (f) privacy; (g) lighting; (h) odour; and (i) emissions. 	AO10 No acceptable outcome is provided.	~	The design is consistent with established amenity of the local area

Table 6.2.7.3B—Maximum densities for Accommodation activities

Use	Maximum density
Dual occupancy	1 dwelling per 300m ² of site area
Multiple dwelling	 (a) 1 dwelling per 150m² of site area; and (b) 1 bedroom per 75m² of site area.
Residential care facility	1 dwelling or accommodation unit per 100m ² of site area.
Retirement facility	1 dwelling or accommodation unit per 150m ² of site area

J428 294 235 EDMONTON 4869. QUEENSLAND -RE TERZI Architectural Technology Building Design & Drafting NEV gnerMedium RiseQBCC LICENCE: 1117048-	phone: 0428 294 GREGORY G TERZI -Building Designer
"Architectural Design Not DESIGNERS WHS REPORT	WD 200 WD 200
"Structural Engineers De: TIMBER TRUSS TIE-DOWN	WD 101 WD 102
ELEVATIONS -EXTERNAL ELEVATIONS -EXTERNAL WINDOWS & EXTERNAL DOO	WD 40 WD 41
ELECTRICAL LAYOUT	WD 20
SECTIONS SECTIONS SECTIONS	WD 15 WD 17
RATION WALL	
ROOF STRUCTURES DETA	WD 10
ROOF STRUCTURES PLAN	WD 09
FOOTINGS DETAILS	WD 07
ET-OUT FLOOR PI	
FLOOR PLAN MEASURE -	WD 04
LOOR PLAN	

231 WALSH STREET 4880 MAREEBA

 \square


-NEW DUPLEX (class 1a)-at


WD 01 WD 02

WD 00


R A X IZG

Associe Diplomany Building Design & Drafting NEW DUPLEX JOB NO. SHEET No. Medium RiseQBCC LICENCE: 1117048- 0486 WD 00	PROJECT: 231 WALSH STREET DRAWING TITLE: MAREEBA 4880 IIILE	"Architectural Design Notes and Abbreviations"	"Structural Engineers Design Notes" TIMBER TRUSS TIE-DOWNS	ELEVATIONS -EXTERNAL ELEVATIONS -EXTERNAL WINDOWS & EXTERNAL DOOR SCHEDULE	ELECTRICAL LAYOUT	WALL SPECIFICATION PLAN -structural SECTIONS SECTIONS SECTIONS	UCTURES F UCTURES F CEILING PI	FLOOR PLAN MEASUREUNIT A SET-OUT FLOOR PLAN SLAB & FOOTINGS PLAN FOOTINGS DETAILS	SITE PLANS DETAIL SITE PLAN (sewer, rainwater, & service connections)	TITLE SHEET (drawing schedule)	VIND SOHEDULE
0 ISSUE	N 'A3' SHEET SHEET	A3	A3	A3	A3		A	3	A3	A3	sheet size

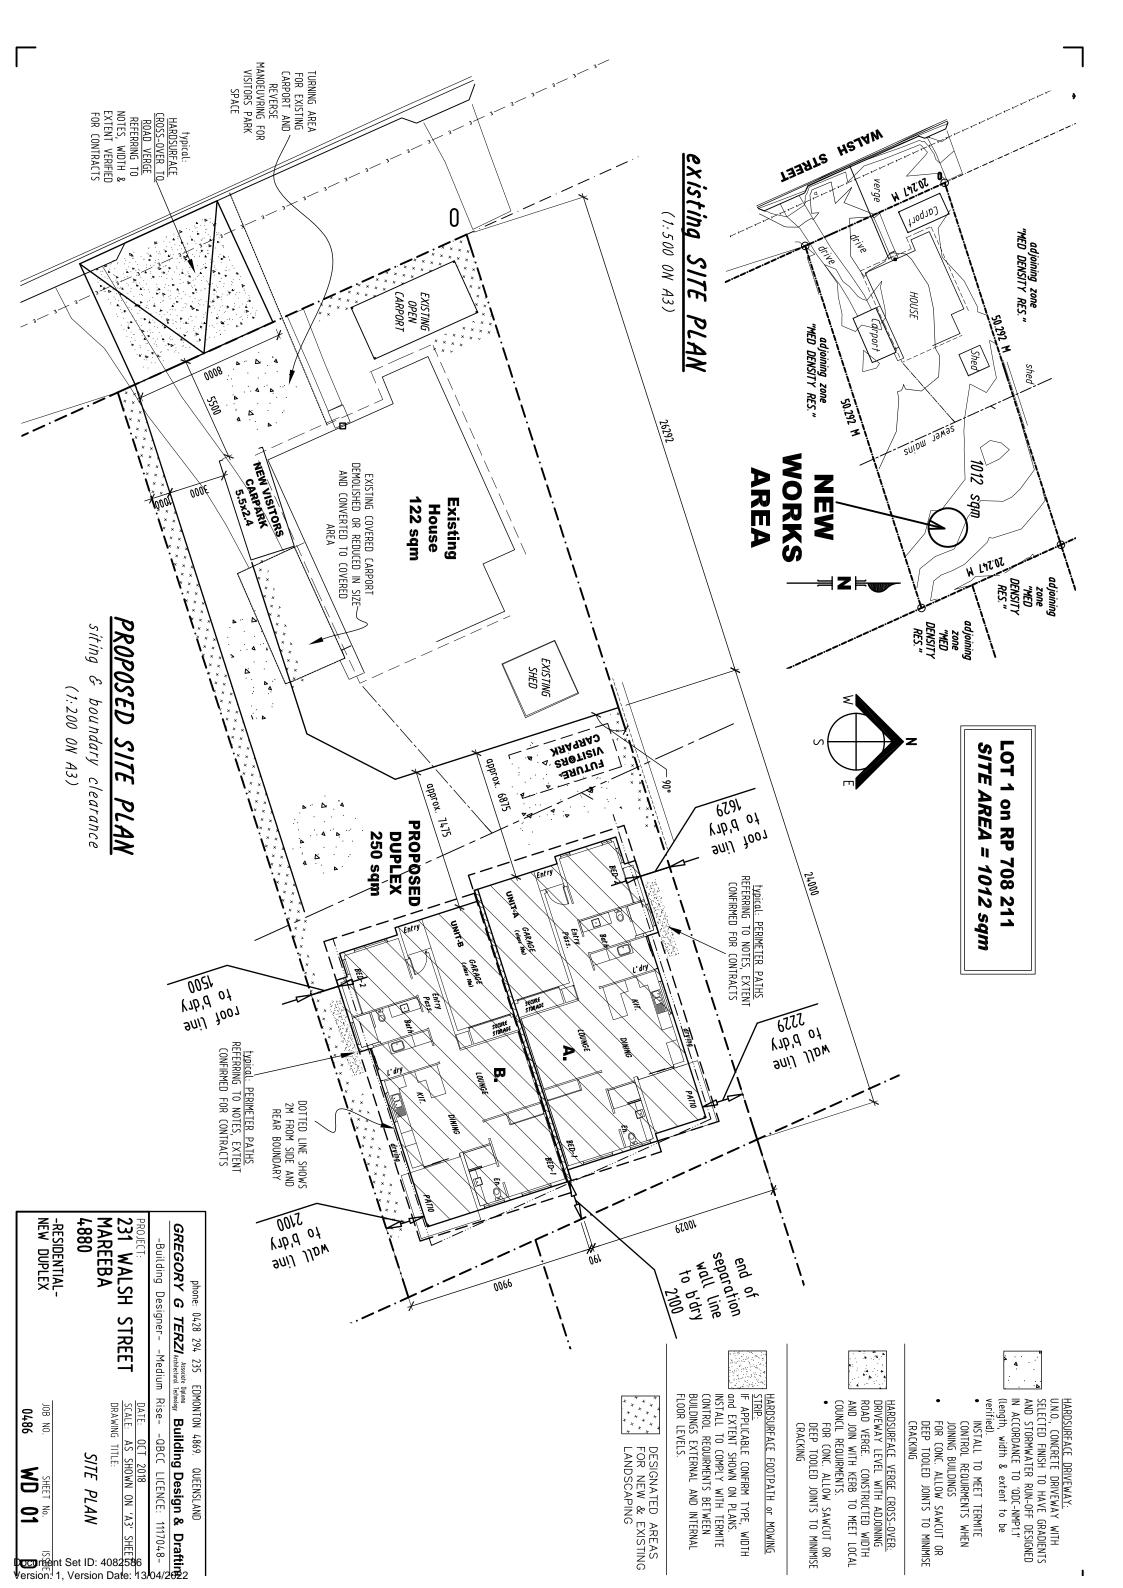

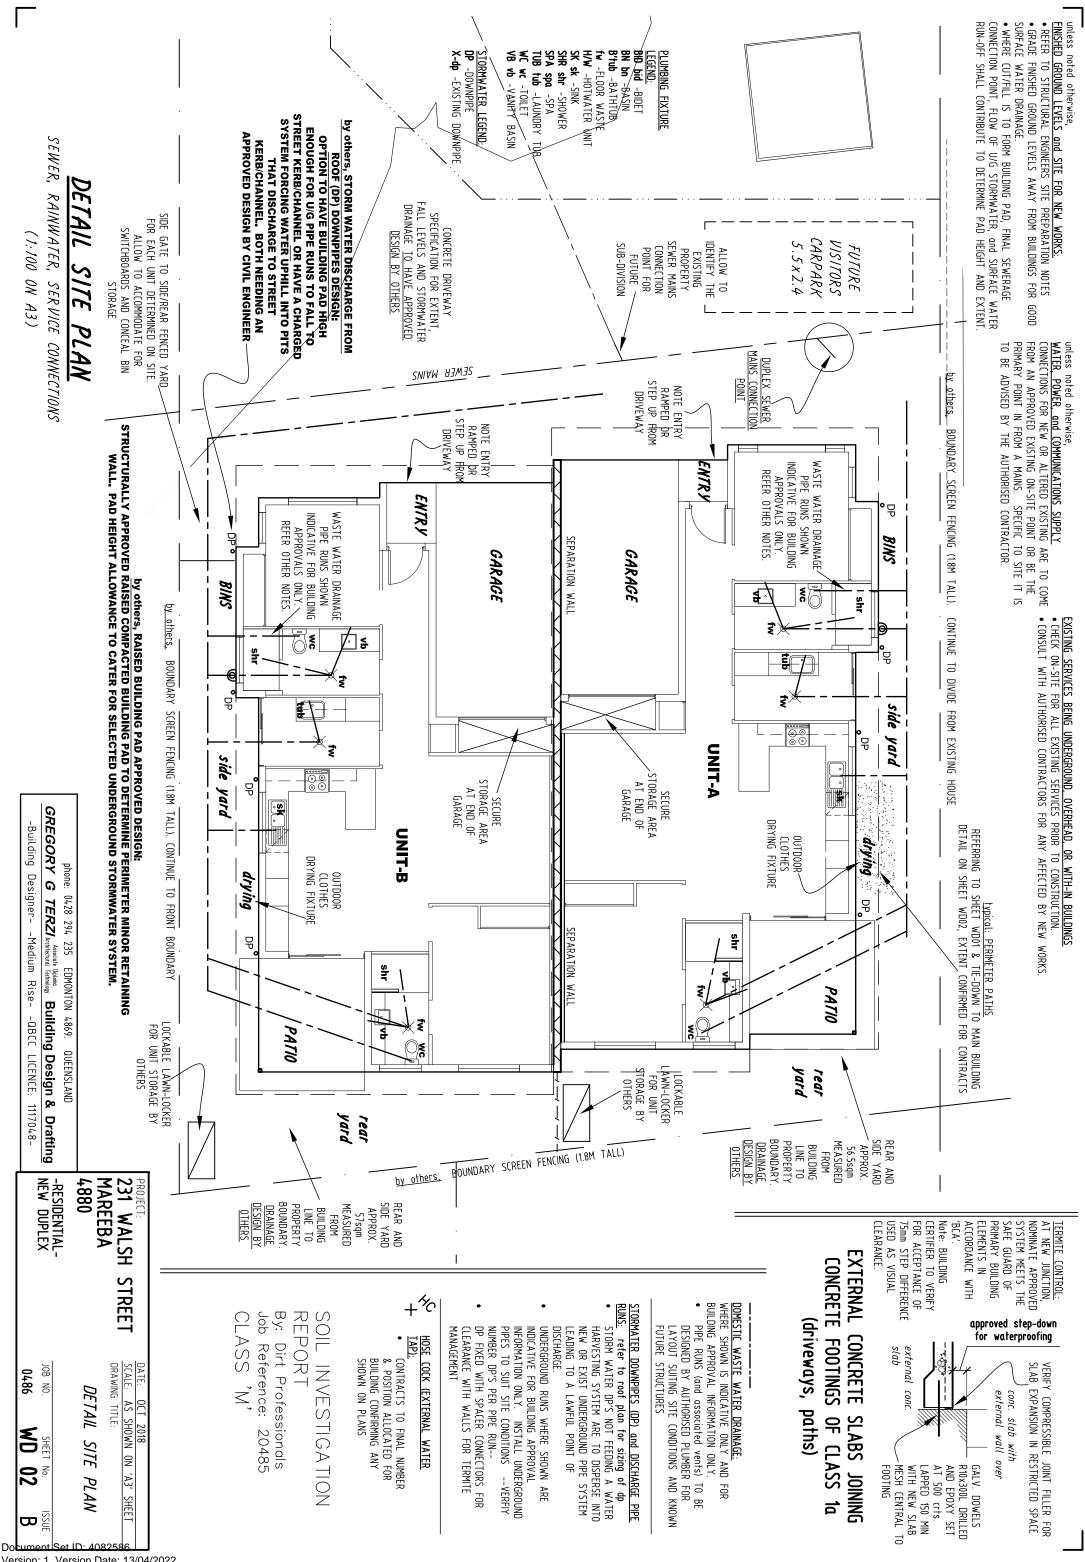

Version: 1, Version Date: 13/04/2022

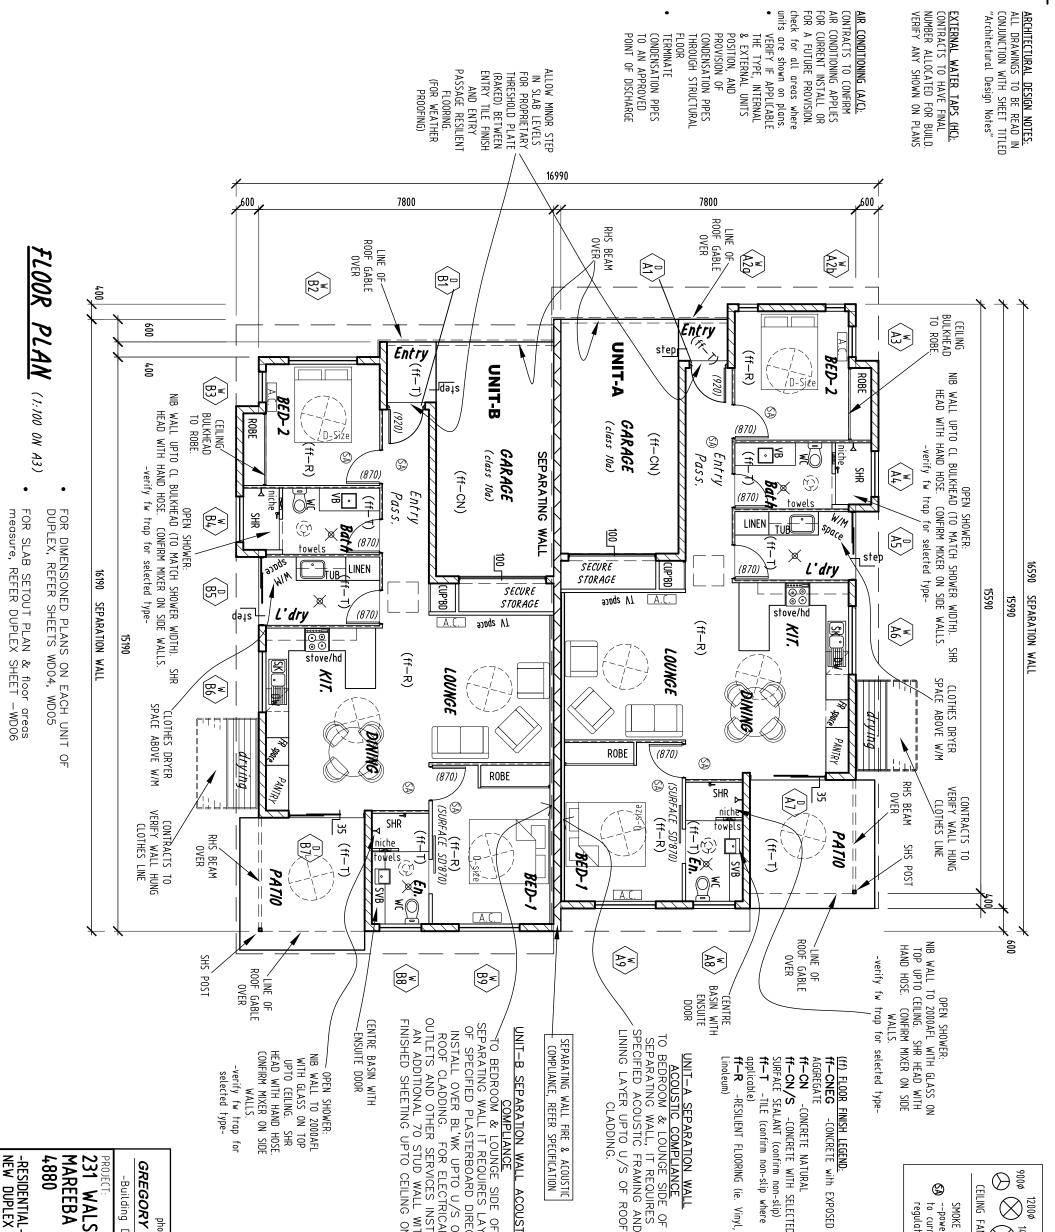

		<u>END:</u> TE with EXPOSED	AL TH SELECTED SEPARATING WALL:	VET-AREA WALL TILES: ELECTED WALLS TILING EXTENT	 CELLING CELLING LAUNDRY AND KITCHEN -TO SP OF WATER VESSELS AND CONTI LENGTH OF BENCH UPON. CON FOR THE MIN. COMPLIANT HEIGH 	phone: 0428 294 235 EDMONTON 4869. QUEENSLAND 30RY G TERZI Architectural Technology Building Design & 1.dding DesignerMedium RiseQBCC LICENCE: 111	ON WALL A COLOR VICES	SEPARATING WALL: FIRE RATING (FRL) 60/60 equal to CONCRETE BLOCI MANF. 'ADBRI'. TEST/OPIN NUMBER RR/05/3 943.Rp REFER DETAILS FOR EXTEI HEIGHT AND TERMINATION OF ROOFS SEPARATING WALL: ACOUSTIC RW+CW 50 min. equal to 'GYPROCK System which utilises block wall s an Rw value >41 ACOUSTIC SYSTEM UP TO CLADDING U/S. REFER DIA ACOUSTIC SYSTEM UP TO
END: TE with EXPOSED TE with EXPOSED TE WITH SELECTED TE WITH SELECTED FIRE RATING WALL: FIRE RATING (FRL) 60/60/	END: TE with EXPOSED NATURAL FE WITH SELECTED SEPARATING WALL: Prime non-slip FIRE RATING (FRL) 60/60/	NATURAL IF WITH SELECTED SEPARATING WALL: Prim non-slip Prim clin when	INE NATING (FAL) OU/ OU/	REFER DETAILS FOR EXTENT OF HEIGHT AND TERMINATION WITH OF ROOFS SEPARATING WALL: ACOUSTIC Rw+Cw 50 min. equal to 'GYPROCK System CSR which utilises block wall system an Rw value >41 ACOUSTIC SYSTEM UP TO ROOF CLADDING U/S. REFER DETAILS ALLOWED GAP WITH ROOF CLADI UNLESS SPECIFIED DIFFERIT BY OWNER, ALLOW 70mm ACOUSTIC BULK WALL NSULATION (R-1.7) WALLS SURROUNDING BATHROOM, TOILETS, L'DRY, ENSUITE WALLS DIVIDING A BEDROOM FROM BEDROOM, LIVING, MEDIA, KITCHEN OR CORRIDOR	ON WALL LIANCE REFER DETAILS FOR EXTENT OF HEIGHT AND TERMINATION WITH OF ROOF VGE SIDE OF T REQUIRES FRAMING AND VGE SIDE OF REQUIRES LAYER BOARD DIRECT UPTO U/S OF RELECTRICAL OF CELLING ONLY SEPARATING WALL: ACOUSTIC RW+CW 50 min. equal to 'GYPROCK System CSR which utilises block wall system an Rw value >41 ACOUSTIC CE EQUIRES LAYER BOARD DIRECT UPTO U/S OF CLADDING U/S. REFER DETAILS ALLOWED GAP WITH ROOF CLADD UPTO U/S OF CLADDING U/S. REFER DETAILS ALLOWED GAP WITH ROOF CLADD UNLESS SPECIFIED DIFFERIT BY OWNER, ALLOW 70mm ACOUSTIC BULK WALL INSULATION (R-17) • WALL SURPOUNDING BATHROOM, BEDROOM, LIVING, MEDIA, KITCHEN OR CORRIDOR • WALLS SURPOUNDING A BEDROOM FROM BEDROOM, LIVING, MEDIA, KITCHEN OR CORRIDOR • MAN BATHROOM AND ENSUITE • MAN BATHROOM AND ENSUITE	ON WALL ULANCE VGE SIDE OF T REQUIRES FRAMING AND IT REQUIRES FRAMING AND ACOUSTIC INS OF ROOF SEPARATING WALL: ACOUSTIC RW+Cw 50 min. equal to 'GYPROCK System an Rw value >41 ACOUSTIC CE NGE SIDE OF EQUIRES LAYER RECTRICAL RVICES INSTALL UD WALL WITH O CEILING ONLY SEPARATING WALL: ACOUSTIC SYSTEM UP TO ROOF CLADDING U/S. REFER DETAILS ALLOWED GAP WITH ROOF CLADD INGE SIDE OF CLADDING U/S. REFER DETAILS ALLOWED GAP WITH ROOF CLADD UNLESS SPECIFIED DIFFERIT BY OWNER, ALLOW 70m ACOUSTIC BULK WALL UNLESS SPECIFIED DIFFERIT BY OWNER, TOLETS, L'DRY, ENSUITE • WALLS SURROUNDING BATHROOM, TOLETS, L'DRY, ENSUITE • WALLS SURROUNDING BATHROOM, TOLETS, L'DRY, ENSUITE • WALLS DIVIDING A BEDROOM, KITCHEN 0 R CORRIDOR WET-AREA WALL TILLES. SELECITED WALLS TILING EXTENT • MAIN BATHROOM AND ENSUITE -UPTO CELING OF WATER VESSELS AND CONTINUE F LANDRY AND KITCHEN -TO SPLASHB OF WATER VESSELS AND CONTINUE F LENGTH OF BENCH UPON. CONFIRM CE FOR THE MIN. COMPLIANT HEIGHT NEE		to CONCRETE BLOCK 'ADBRI'. TEST/OPINIO ER RR/05/3 943.Rpt6
POSED SEPARATING WALL: SLIP) Mhere equal to CONCRETE BLOCK MANF. 'ADBRI'. TEST/OPINIO NUMBER RR/05/3 943.Rpt6	POSED SEPARATING WALL: Slip) Mhere equal to CONCRETE BLOCK MANF. 'ADBRI'. TEST/OPINIO NUMBER RR/05/3 943.Rpt6	LECTED SEPARATING WALL: FIRE RATING (FRL) 60/60/(equal to CONCRETE BLOCK MANF. 'ADBRI'. TEST/OPINIO NUMBER RR/05/3 943.Rpt6	Vinyl, NUMBER RR/05/3 943.Rpt6	SEPARATING WALL: ACOUSTIC Rw+Cw 50 min. equal to 'GYPROCK Syster which utilises block wall s an Rw value >41 ACOUSTIC SYSTEM UP TO CLADDING U/S. REFER DI ALLOWED GAP WITH ROOF UNLESS SPECIFIED DIFFERENT BY ALLOW 70mm ACOUSTIC BULK WA INSULATION (R-1.7) • WALLS SURROUNDING BATHRI TOILETS, L'DRY, ENSUITE • WALLS DIVIDING A BEDROOM BEDROOM, LIVING, MEDIA, KIT OR CORRIDOR	T REQUIRES T REQUIRES FRAMING AND I/S OF ROOF ACOUSTIC PECATION SEPARATING WALL: ACOUSTIC equal to 'GYPROCK System which utilises block walls an Rw value >41 ACOUSTIC CE NGE SIDE OF ERVICES INSTALL O CEILING ONLY O CEILING ONLY O CEILING ONLY NULL MITH	Status Status Status In the status Status Status Status Status In the status Status Status Status Status Status In the status Status		LS FOR EXTENT OF TERMINATION WITH
SED SED SEPARATING WALL: Sere equal to CONCRETE BLOCK MAS MANF. 'ADBRI'. TEST/OPINION NUMBER RR/05/3 943.Rpt6 (Rv REFER DETAILS FOR EXTENT OF HEIGHT AND TERMINATION WITH OF ROOFS	SED SEPARATING WALL: FIRE RATING (FRL) 60/60/60 equal to CONCRETE BLOCK MAS MANF. 'ADBRI'. TEST/OPINION NUMBER RR/05/3 943.Rpt6 (RN NUMBER DETAILS FOR EXTENT OF HEIGHT AND TERMINATION WITH OF ROOFS	ECTED SEPARATING WALL: pre equal to CONCRETE BLOCK MAS MANF. 'ADBRI'. TEST/OPINION NUMBER RR/05/3 943.Rpt6 (R) REFER DETAILS FOR EXTENT OF HEIGHT AND TERMINATION WITH OF ROOFS	ere equal to CONCRETE BLOCK MAS MANF. 'ADBRI'. TEST/OPINION NUMBER RR/05/3 943.Rpt6 (Rv REFER DETAILS FOR EXTENT OF HEIGHT AND TERMINATION WITH OF ROOFS	SEPARATING WALL: ACOUSTIC Rw+Cw 50 min. equal to 'GYPROCK Syster which utilises block wall s an Rw value >41 ACOUSTIC SYSTEM UP TO CLADDING U/S. REFER DI ALLOWED GAP WITH ROOF UNLESS SPECIFIED DIFFERENT BY ALLOW TOmm ACOUSTIC BULK WA INSULATION (R-1.7) WALLS SURROUNDING BATHRI TOILETS, L'DRY, ENSUITE WALLS DIVIDING A BEDROOM BEDROOM, LIVING, MEDIA, KIT OR CORRIDOR	 V/S OF ROOF SEPARATING WALL: ACOUSTIC Rw+Cw 50 min. equal to 'GYPROCK System which utilises block walls an Rw value >41 ACOUSTIC SYSTEM UP TO CLADDING U/S. REFER DI ALLOWED GAP WITH ROOF NGE SIDE OF REQUIRES LAYER NGE SIDE OF RECTRICAL ERVICES INSTALL UPTO U/S OF R ELECTRICAL UNULATION INSULATION (R-1.7) O CEILING ONLY UNULATION (R-1.7) WALLS SURROUNDING BATHRI TOLETS, L'DRY, ENSUITE WALLS SURROUM, LIVING, MEDIA, KIT OR CORRIDOR WET-AREA WALL TILES: SELECTED WALLS TILING EXTENT MAIN BATHROOM AND ENSUITION 	ACOUSTIC ACOUSTIC ACOUSTIC ACOUSTIC ACOUSTIC ACOUSTIC ACOUSTIC ACOUSTIC ACOUSTIC ACOUSTIC ACOUSTIC ACOUSTIC ACOUSTIC CE NGE SIDE OF EQUIRES LAYER BOARD DIRECT UPTO U/S OF RELECTRICAL ERVICES INSTAL UD WALL WITH O CEILING ONLY O CEILING ONLY ACOUSTIC SYSTEM UP TO ROOI CLADDING U/S. REFER DETAIL ALLOWED GAP WITH ROOF CLAI INSULATION. INSULATION. WILL WITH ALLOW TOMM ACOUSTIC BULK WALL INSULATION. WEI-AREA WALL TILES. SELECTED WALLS TILING A BEDROOM FROM BEDROOM, LIVING, MEDIA, KITCHEN OF WATER VESSELS AND CONTINUE LAUNDRY AND KITCHEN -TO SPLASI OF WATER VESSELS AND CONTINUE EENGTH OF BENCH UPON. CONFIRM FOR THE MIN. COMPLIANT HEIGHT N	NGE SIDE OF IT REQUIRES FRAMING AND	
D: with EXPOSED ATURAL WITH SELECTED SEPARATING WALL: imm non-slip) Ion-slip where equal to CONCRETE BLOCK MAS MANF. 'ADBRI'. TEST/OPINION NUMBER RR/05/3 943.Rpt6 (Rv NUMBER RR/05/3 943.Rpt6 (Rv NUMBER RR/05/3 943.Rpt6 (Rv REFER DETAILS FOR EXTENT OF HEIGHT AND TERMINATION WITH OF ROOF SEPARATING WALL:	D: with EXPOSED ATURAL WITH SELECTED SEPARATING WALL: FIRE RATING (FRL) 60/60/60 equal to CONCRETE BLOCK MAS equal to CONCRETE BLOCK MAS mANF. 'ADBRI'. TEST/OPINION NUMBER RR/05/3 943.Rpt6 (Rv NUMBER RR/05/3 943.Rpt6 (Rv NUMER RR/05/3 943.Rpt6 (Rv))	ATURAL WITH SELECTED WITH SELECTED Sequal to CONCRETE BLOCK MAS equal to CONCRETE BLOCK MAS mANNE (ie. Vinyl, NUMBER RR/05/3 943.Rpt6 (R) HEIGHT AND TERMINATION WITH OF ROOFS SEPARATING WALL: SEPARATING WALL:	INPUT SEPARATING WALL:	an Rw value >41 ACOUSTIC SYSTEM UP TO CLADDING U/S. REFER DI ALLOWED GAP WITH ROOF UNLESS SPECIFIED DIFFERENT BY ALLOW 70mm ACOUSTIC BULK WA INSULATION (R-1.7) • WALLS SURROUNDING BATHRI TOILETS, L'DRY, ENSUITE • WALLS DIVIDING A BEDROOM BEDROOM, LIVING, MEDIA, KIT OR CORRIDOR	ACOUSTIC which utilises block walls ACOUSTIC an Rw value >41 PICATION ACOUSTIC SYSTEM UP TO CLADDING U/S. REFER DI ALLOWED GAP WITH ROOF VID NGE SIDE OF REQUIRES LAYER RECTRICAL ERVICES INSTALL OTHER INTERNAL STUD WALLS AC INSULATION: O CEILING ONLY NISULATION: O CEILING ONLY NISULATION (R-17) • WALLS DIVIDING A BEDROOM BEDROOM, LIVING, MEDIA, KIT OR CORRIDOR • WALLS STENT OR CORRIDOR • WALLS DIVIDING A BEDROOM BEDROOM, LIVING, MEDIA, KIT OR CORRIDOR • MAILS TILING EXTENT • MAILS TILING EXTENT	ACOUSTIC ACOUSTIC which utlises block wall system an Rw value >41 ACOUSTIC SYSTEM UP TO ROOD CLADDING U/S. REFER DETAIL ALLOWED GAP WITH ROOF CLAI EQUIRES LAYER BOARD DIRECT UPTO U/S OF R ELECTRICAL ERVICES INSTALL UNUSUATION: CONTHER INTERNAL STUD WALLS ACOUSTIC INSULATION: OTHER INTERNAL STUD WALLS ONLY WITH ROOF CLAI (NSULATION: INSULATION: O CEILING ONLY WITH ALLOW 70mm ACOUSTIC BULK WALL INSULATION (R-1.7) INSULATION (R-1.7) • WALLS SPECIFIED DIFFERENT BY OWNER ALLOW 70mm ACOUSTIC BULK WALL INSULATION (R-1.7) INSULATION (R-1.7) • WALLS DIVIDING A BEDROOM, LIVING, MEDIA, KITCHEN OR CORRIDOR MET-AREA WALL TILES: SELECTED WALLS TILING EXTENT • MAIN BATHROOM AND ENSUITE LENGTH OF BENCH UPON, CONFINUE LENGTH OF BENCH UPON, CONFINUE FOR THE MIN, COMPLIANT HEIGHT N	U U U	TIC Rw+Cw 50 min. to 'GYPROCK System CSR7
UD: aTURAL ATURAL WITH SELECTED FIRE RATING WALL: FIRE RATING (FRL) 60/60/60 equal to CONCRETE BLOCK MAS ORING (ie. Vinyl, NUMBER RR/05/3 943.Rpt6 (R) NUMBER RR/05/3 943.Rpt6 (R) RAMING AND /S OF ROOF ACOUSTIC Rw+Cw 50 min. ACOUSTIC Rw+Cw 50 min.	ID: aTURAL ATURAL WITH SELECTED FIRE RATING WALL: FIRE RATING (FRL) 60/60/60 non-slip where equal to CONCRETE BLOCK MAS MANF. 'ADBR!'. TEST/OPINION NUMBER RR/05/3 943.Rpt6 (Rv IANCE GE SIDE OF REQUIRES RAMING AND /S OF ROOF ACOUSTIC Rw+Cw 50 min. ACOUSTIC Rw+Cw 50 min.	ATURAL SEPARATING WALL: FIRE RATING (FRL) 60/60/60 rimm non-slip) non-slip where equal to CONCRETE BLOCK MAS MANF. 'ADBR!'. TEST/OPINION NUMBER RR/05/3 943.Rpt6 (R NUMBER RR/05/3 943.Rpt6 (R NUMBER RR/05/3 943.Rpt6 (R REFER DETAILS FOR EXTENT OF HEIGHT AND TERMINATION WITH OF ROOFS SEPARATING WALL: ACOUSTIC Rw+Cw 50 min.	non-slip where equal to CONCRETE BLOCK MAS equal to CONCRETE BLOCK MAS MANF. 'ADBRI'. TEST/OPINION NUMBER RR/05/3 943.Rpt6 (Rv NUMBER RR/05/3 943.Rpt6 (Rv NUMBER RR/05/3 943.Rpt6 (Rv REFER DETAILS FOR EXTENT OF HEIGHT AND TERMINATION WITH OF ROOFS RAMING AND /S OF ROOF SEPARATING WALL: ACOUSTIC Rw+Cw 50 min.	OTHER INTERNAL STUD WALLS AG INSULATION:	WALL ACOUSTIC ACOUSTIC SYSTEM UP TO CLADDING U/S. REFER DI ALLOWED GAP WITH ROOF OE ALLOWED GAP WITH ROOF REQUIRES LAYER OF BOARD DIRECT OTHER INTERNAL STUD WALLS AG UPTO U/S OF OTHER INTERNAL STUD WALLS AG RELECTRICAL INSULATION: UND WALL WITH UNLESS SPECIFIED DIFFERENT BY O CEILING ONLY INSULATION (R-1.7) • WALLS SURROUNDING BATHR TOILETS, L'DRY, ENSUITE • WALLS DIVIDING A BEDROOM BEDROOM, LIVING, MEDIA, KIT OR CORRIDOR WET-AREA WALL TILES: SELECTED WALLS TILING EXTENT • MAIN BATHROOM AND ENSUITI	WALL ACOUSTIC ACOUSTIC SYSTEM UP TO ROOT CLADDING U/S. REFER DETAIL NGE SIDE OF CLAUWED GAP WITH ROOF CLAID ERVICES LAYER OTHER INTERNAL STUD WALLS ACOUSTIC ERVICES INSTALL UNESS SPECIFIED DIFFERENT BY OWNER O CEILING ONLY MITH ALLOW TOMM ACOUSTIC BULK WALL INSULATION: — UD WALL WITH ALLOW TOMM ACOUSTIC BULK WALL NULVATION (R-17) • VUD WALLS SURROUNDING BATHROOM, TOLETS, L'DRY, ENSUITE • WALLS SURROUNDING BATHROOM, • MALLS SURROUNDING A BEDROOM FROM BEDROOM, LIVING, MEDIA, KITCHEN • • MAILS DIVIDING A BEDROOM FROM • MELAREA WALL TILES: SELECTED WALLS TILING EXTENT • MAIN BATHROOM AND ENSUITE -UP • FOR THE MIN. COMPLIANT HEIGHT N	ACOUSTIC	value >41
EXPOSED SELECTED SELECTED SELECTED Normere ie. Vinyl, ie. Vinyl, II SEPARATING (FRL) 60/60/60 equal to CONCRETE BLOCK MAS MANF. 'ADBRI'. TEST/OPINION NUMBER RR/05/3 943.Rpt6 (Rv REFER DETAILS FOR EXTENT OF HEIGHT AND TERMINATION WITH OF ROOFS SEPARATING WALL: ACOUSTIC Rw+Cw 50 min. equal to 'GYPROCK System CSR which utilises block wall system an Rw value >41	EXPOSED SELECTED SELECTED SEPARATING WALL: FIRE RATING (FRL) 60/60/60 equal to CONCRETE BLOCK MAS MANF. 'ADBRI'. TEST/OPINION NUMBER RR/05/3 943.Rpt6 (Rv NUMBER DETAILS FOR EXTENT OF HEIGHT AND TERMINATION WITH OF ROOFS SEPARATING WALL: ACOUSTIC RW+CW 50 min. equal to 'GYPROCK System CSR which utilises block wall system an Rw value >41	SELECTED SEPARATING WALL: FIRE RATING (FRL) 60/60/60 equal to CONCRETE BLOCK MAS MANF. 'ADBRI'. TEST/OPINION NUMBER RR/05/3 943.Rpt6 (Rv REFER DETAILS FOR EXTENT OF HEIGHT AND TERMINATION WITH OF ROOF SEPARATING WALL: ACOUSTIC Rw+Cw 50 min. equal to 'GYPROCK System CSR which utilises block wall system an Rw value >41	ie. Vinyl, ie. Vinyl, ie. Vinyl, MANF. 'ADBRI'. TEST/OPINION NUMBER RR/05/3 943.Rpt6 (Rv REFER DETAILS FOR EXTENT OF HEIGHT AND TERMINATION WITH OF ROOFS IG AND SEPARATING WALL: ACOUSTIC Rw+Cw 50 min. equal to 'GYPROCK System CSR which utilises block wall system an Rw value >41	OTHER INTERNAL STUD WALLS A INSULATION: UNLESS SPECIFIED DIFFERENT BY ALLOW 70mm ACOUSTIC BULK W. INSULATION (R-1.7) WALLS SURROUNDING BATHF TOILETS, L'DRY, ENSUITE WALLS DIVIDING A BEDROOM BEDROOM, LIVING, MEDIA, KI OR CORRIDOR	NGE SIDE OF EQUIRES LAYER RECARD DIRECT UPTO U/S OF ERVICES INSTALL INSULATION: CO CEILING ONLY O CEILING ONLY O CEILING ONLY MITH O CEILING ONLY MITH O CEILING ONLY MITH O CEILING ONLY MITH MISULATION (R-1.7) MISULATION (R-1.7)	NGE SIDE OF EQUIRES LAYER REQUIRES LAYER RELECTRICAL UPTO U/S OF CUD WALL WITH O CEILING ONLY O CEILING ONLY WITH CO CEILING ONLY UNULATION (R-1.7) WILL WITH ALLOW 70mm ACOUSTIC BULK WALL INSULATION (R-1.7) WALLS SPECIFIED DIFFERENT BY OWNER WALLS SPECIFIED DIFFERENT BY OWNER WALLS SURROUNDING BATHROOM, TOILETS, L'DRY, ENSUITE WALLS DIVIDING A BEDROOM FROM BEDROOM, LIVING, MEDIA, KITCHEN OR CORRIDOR WET-AREA WALL TILES: SELECTED WALLS TILING EXTENT MAIN BATHROOM AND ENSUITE -UPT CELING INTO CONTINUE LENGTH OF BENCH UPON: CONFIRM FOR THE MIN. COMPLIANT HEIGHT N		DUSTIC SYSTEM UP TO
AL AL AL H SELECTED Inpun-slip) (ip. where (ie. Vinyl, CE COURTIC SIDE OF CUIRES ING AND OF ROOF ACOUSTIC ACOUSTIC ACOUSTIC CLADDING U/S. REFER DETAILS SEPARATING WALL: ACOUSTIC SYSTEM UP TO ROOF CLADDING U/S. REFER DETAILS ALLOWED GAP WITH ROOF CLADD	AL AL H SELECTED Ip where (ie. vinyl, (ie. vinyl, (ie. vinyl, CE SIDE OF CUIRES SING AND STIC ACOUSTIC ACOUSTIC ACOUSTIC CADDING U/S. REFER DETAILS ACOUSTIC SYSTEM UP TO ROOF CLADDING U/S. REFER DETALS ALLOWED GAP WITH ROOF CLADD	AL AL H SELECTED Impon-slip lip where (ie. Vinyl, (ie. Vinyl, CQUIRES SIDE OF CQUIRES IING AND OF ROOF ACOUSTIC ACOUSTIC ACOUSTIC ACOUSTIC CLADDING U/S. REFER DETAILS CLADDING U/S. REFER DETAILS ACOUSTIC SYSTEM UP TO ROOF CLADDING U/S. REFER DETAILS ALLOWED GAP WITH ROOF CLADD	lip where equal to CONCETE BLOCK MAS (ie. Vinyl, MANF. 'ADBRI'. TEST/OPINION MANF. 'ADBRI'. TEST/OPINION NUMBER RR/05/3 943.Rpt6 (R MALL REFER DETAILS FOR EXTENT OF CE SIDE OF SIDE OF REFER DETAILS FOR EXTENT OF HEIGHT AND TERMINATION WITH OF ROOFS SIDE OF SEPARATING WALL: OF ROOF SEPARATING WALL: OF ROOF ACOUSTIC Rw+Cw 50 min. equal to 'GYPROCK System CSR which utilises block wall system an Rw value >41 ACOUSTIC ALLOWED GAP WITH ROOF CLADING	CORRIDOR	OR CORRIDOR WET-AREA WALL TILES: SELECTED WALLS TILING EXTENT MAIN BATHROOM AND ENSIITE	OR CORRIDOR WET-AREA WALL TILES: SELECTED WALLS TILING EXTENT • MAIN BATHROOM AND ENSUITE -UP1 CEILING • LAUNDRY AND KITCHEN -TO SPLASI OF WATER VESSELS AND CONTINUE LENGTH OF BENCH UPON. CONFIRM FOR THE MIN. COMPLIANT HEIGHT N	JNGE SIDE OF REQUIRES LAYER RBOARD DIRECT OPTO U/S OF DR ELECTRICAL ERVICES INSTALL TUD WALL WITH TO CEILING ONLY	UWED GAP WITH ROOF
NUL: E with EXPOSED Yaturana: E with SELECTED E with SELECTED ranship where E with SELECTED reading on selection inon-skip where ON WALL LIANCE VICE YS OF ROOF REFER DETAILS FOR EXTOPNION NUMBER RR/OS/3 943.Rpt6 (R ROOFS REFER DETAILS FOR EXTING WALF. 'ADBR!'. TEST/OPNION NUMBER RR/OS/3 943.Rpt6 (R ROOFS REFER DETAILS FOR EXTENT OF HEIGHT AND TERMINATION WITH O'R COUSTIC Recourses LAYER BBOARD DIRECT UPTO U/S OF RECURRES INSTAL ERVICES INSTAL UP WALL WITH RECOURS INSTAL UP WALL WITH RECOURS SINCE RECEIRICAL ENVICES INSTAL UP WALL STILL O'CELLING ONLY MMAL READING RECOURS SIDE OF REMAINS BBOROM, UNKE, MEDIA ALLOWED CAP WITH ROOF CLAD MULSS SPECIFIED DIFFERINT BY OWNER, ALLOWED CAP WITH ROOF CLAD INSULATION NULLS SURFOUNDING BATHROOM, TOLETS, UTBY, ENSULT O'NEEN ALLS SURFOUNDING BATHROOM, BEDROOM, UNKG, MEDIA, KITCHEN O'R CORRIDOR WALLS SURFOUNDING A BEDROOM FROM BEDROOM, UNKG, MEDIA, KITCHEN O'R CORRIDOR ULLING I LAUMPR' AND KITCHEN -TO SPLASH O'R CORRIDOR DANNE BACK UPONIC (ONTINUE I LEINING A BEDROOM FROM BEDROOM, UNNG, MEDIA, KITCHEN O'R CHENKEN AND ENSULTE - UPTO CELLING O'MATER VESSELS AND O'R ORBROOM BEDROOM, UNNG, MEDIA, KITCHEN O'R CHENKEN AND ENSULTE - UPTO CELING O'MATER VESSELS AND O'R CORRIDOR D'ANTER VESSELS AND O'R ORBROOM D'ANTER VESSELS AND O'R CORRIDOR D'ANTER VESSELS AND O'R CORRIDOR D'R THE MIN. COMPLIANT HEIGHT NE D'R THE MIN. COMPLIANT HEIGHT NE	WIL: E with EXPOSED E with SELECTED FIRE RATING (FRL) 60/60/60 equal to CONCRETE BLOCK MASO MANE. 'ADBR'. TEST/OPINION NUMBER RR/05/3 943.Rpt6 (Rw REFER DETAILS FOR EXTENT OF M HEIGHT AND TERMINATION WITH T FROORES SIDE OF T REQUIRES FRAMING AND REFER DETAILS FOR EXTENT OF M HEIGHT AND TERMINATION WITH T CONSTIC RECETCION UPTO U/S OF ROOF MALL ACOUSTIC CE EQUIRES LAYER BOOARD DIRECT UPTO U/S OF ROOF MALL ACOUSTIC CE EQUIRES LAYER BOARD DIRECT UPTO U/S OF ROLECT ON MALL MITH O CELLING ONLY MALL ACOUSTIC CE EQUIRES LAYER BOARD DIRECT UPTO U/S OF RECETRICAL MULES STALL UPTO U/S OF RELATION. MALL SUBJECT UPTO U/S OF ROOFS OTHER INTERNAL STUD WITH ROOF CLADDING UPTO U/S O CELLING ONLY MALL SUBJECT UPTO U/S O CELLING ONLY O CELLING ONLY WET-AREA WALL MILS SUBBOOM LIVING A BEDBOOM FROM BEDBOOM LIVING A BEDBOOM FROM BEDBOOM FROM BEDBOOM LIVING A BEDBOOM FROM BEDBOOM FROM BEDBOOM FROM BEDBOOM LIVING A BEDBOOM FROM BEDBOOM FROM BEDBOOM LIVING A BEDBOOM FROM BEDBOOM FROM BEDBOO	KATURAL E WITH SELECTED Infine non-slip non-slip where openue (i.e. Viny), SEPARATING WALL: FIRE RATING (FRL) 60/60/60 equal to CONCRETE BLOCK MASO MANF. 'ADBRI'. TESTS/OPINION NUMBER RR/05/3 943.Rpt6 (Rw REFER DETAILS FOR EXTENT OF IN NUMBER RR/05/3 943.Rpt6 (Rw REFER DETAILS FOR EXTENT OF IN NUMBER RR/05/3 943.Rpt6 (Rw REFER DETAILS FOR EXTENT OF IN PROFE SUBE OF REQUIRES LAYER BOARD DIRECT RELECTRICAL INSULATION WITH O CELLING ONLY MALL REFER DETAILS ACOUSTIC Rw+Cw 50 min. equal to 'CYPROCK System CSR7 which utilises block woll system V an Rw value >41 MALL MELECTRICAL RELECTRICAL INSULATION R ELECTRICAL INSULATION R ELECTRICAL INSULATION R ELECTRICAL INSULATION R ELECTRICAL INSULATION R ELECTRICAL INSULATION R COUSTIC SYSTEM UP TO ROOF CLADDING U/S. REFER DETAILS f CLADDING (R-17). MALLS SUBCORD R ELECTRICAL INSULATION R ULLS SURPONNING BATHROOM, TOLES, USROUNDING BATHROOM, TOLES, USROUNDING BATHROOM, TOLES, USROUNDING BATHROOM, OR ORRIDOR MALLS TILING FUNCE WALLS TILING FUNCE, AND REFER SELECTED WALLS TILING FUNCE, AND REVER SELECTED WALLS TILING FUNCE, AND REVER SUBCORD ON KITCHEN -10 SPLASHBAN OF WATER VESSELS AND CONTINUE FOR ENGIN UPON CONTINUE FOR ENGIN UPON CONTINUE FOR ENGIN UPON CONTINUE FOR ENGINE ON CONTINUE FOR ENGINE OR THE MIN. COMPLIANT HEIGHT NEED ORDER ON CONTINUE FOR ENGINE OR THE MIN. COMPLIANT HEIGHT NEED SUBJECTED SUBJECT - WEALS THEN SUBJECTED SUBJECT - WEALS THEN SUBJECTED SUBJECT SUBJECT SUBJECTED WALLS TILING SUBJECTED WALLS T	non-stip where porner, Vinyt, DORING (ie. Vinyt, MANF. 'ADBRI'. TEST/OPINION NUMBER RR/05/3 943.Rpt6 (Rw REFER DETAILS FOR EXTENT OF V HEIGHT AND TERMINATION WITH T PERATING VALUANCE VS OF ROOF REALING VS OF ROOF REALING SEPARATING WALL: ACOUSTIC CE CE CE CE CE CE CE CE CE C	 MAIN BATHRUM AND ENSUITE - UPTO CEILING LAUNDRY AND KITCHEN - TO SPLASHBAY OF WATER VESSELS AND CONTINUE FOF LENGTH OF BENCH UPON. CONFIRM OW FOR THE MIN. COMPLIANT HEIGHT NEEDD phone: 0428 294 235 EDMONTON 4869. QUEENSLAND GREGORY G TERZI/Architesteria Licinology Building Designer Medium Rise QBCC LICENCE: 111 	phone: 0428 294 235 EDMONTON 4869. QUEENSLAND 30RY G TERZI Architectural Tennongy Building Design & Idding DesignerMedium RiseQBCC LICENCE: 111		phone: (GREGORY G -Building Desig	OTHER INTERNAL STUD WALLS ACOUSTIC INSULATION: BERNOT CLADUTIC UNLESS SPECIFIED DIFFERENT BY OWNER, ALLOW 70mm ACOUSTIC BULK WALL INSULATION (R-1.7) BUK WALLS WALLS SURROUNDING BATHROOM, TOILETS, L'DRY, ENSUITE • WALLS SURROUNDING BATHROOM, TOILETS, L'DRY, ENSUITE TOILETS, L'DRY, ENSUITE • WALLS DUVIDING, MEDIA, KITCHEN OR CORRIDOR BEDROOM, LIVINIG, MEDIA, KITCHEN OR CORRIDOR • WEIT-AREA WALL TILLES: ELECTED WALLS TILING EXTENT MAIN BATHROOM AND ENSUITE -UPTO CEILING • MEIT-AREA WALL TILLES: ELENGTH OF BENCH UPON, CONFIRM OW FOR THE VESSELS AND CONFINUE FOR LENGTH OF BENCH UPON, CONFIRM OW FOR THE MIN. COMPLIANT HEIGHT NEEDBA OF WATER VESSELS AND CONFIRM OW FOR THE MIN. COMPLIANT HEIGHT NEEDBA OF WATER VESSELS AND CONFIRM OW FOR THE MIN. COMPLIANT HEIGHT NEEDBA OF WATER VESSELS AND CONFIRM OW FOR THE MIN. COMPLIANT HEIGHT NEEDBA OF WATER VESSELS AND CONFIRM OW FOR THE MIN. COMPLIANT HEIGHT NEEDBA OF WATER VESSELS AND CONFIRM OW FOR THE MIN. COMPLIANT HEIGHT NEEDBA OF WATER VESSELS AND CONFIRM OW FOR THE MIN. COMPLIANT HEIGHT NEEDBA OF WATER VESSELS AND CONFIRM OW FOR THE MIN. COMPLIANT HEIGHT NEEDBA OF WATER VESSELS AND CONFIRM OW FOR THE MIN. COMPLIANT HEIGHT NEEDBA OF WATER VESSELS AND CONFIRM OW FOR THE MIN. COMPLIANT HEIGHT NEEDBA OF WATER VESSELS AND CONFIRM OW FOR THE MIN. COMPLIANT HEIGHT NEEDBA OF WATER VESSELS AND CONFIRM OW FOR THE MIN. COMPLIANT HEIGHT NEEDBA OF WATER VESSELS AND CONFIRM OW FOR THE MIN. COMPLIANT HEIGHT NEEDBA OF WATER VESSELS AND CONFIRM OW FOR THE MIN. COMPLIANT HEIGHT NEEDBA OF WATER VESSELS AND CONFIRM OW FOR THE MIN. COMPLIANT HEIGHT NEEDBA OF WATER VESSELS AND CONFIRM OW FOR THE MIN COMPLIANT HEIGHT NEEDBA OF WATER VESSELS AND CONFIRM OW FOR THE MIN COMPLIANT HEIGHT NEEDBA OF WATER VESSELS AN
MDL F with EXPOSED E with FXPOSED E with SELECTED non-slip where opened (ie. Vinyl, LIANCE T RECURRES T RECORD of T RECORDER T RECOR	MD: E with Exposed E with SELECTED WATURAL E WITH SELECTED INFRE RATING WALL: FIRE RATING (FRJ) 60/60/60 equol to CONCRETE BLOCK MASO aquin to CONCRETE BLOCK MASO MANF. 'ADBR'. TEST/OPINION NUMBER RR/05/3 943.Rpt6 (Rw NUMBER RR/05/3 943.Rpt6 (Rw REFER DETAILS FOR EXTENT OF L HEIGHT AND TERMINATION WITH T RECOURES RAMING SIDE OF RECOURES INSTALL UPTO U/S OF ROOF BEOROF UNICS INSTALL INSULATION R LECTRICAL EXCLOSE INSTALL UD WALL WITH O CELLING ONLY MML ACOUSTIC RECOURES INSTALL UD WALL WITH O CELLING ONLY OFRERAN UP TO ROOF CLADDING U/S. REFER DETAILS in ALLOWED GAP WITH ROOF CLADDIN MUESS SPECIFIED DIFFERIT BY OWNER, ALLOWED GAP WITH ROOF CLADDIN OR CORDON, UNICS SUBROWNING BATHROM, TOURS SPECIFIED DIFFERIT BY OWNER, ALLOWING A EDBOOM RULL INSULATION OF WALLS SUBROWNING BATHROM, MULLS SURDUNING A BEDROM FROM BEDROOM, LIVING, MEDIA, KITCHEN OF WALLS TILING KITCHEN -10 SPLASHBAW OF WAILS TILING KISELS AND UNITHEN MADEERA Phone: 0428 294 235 EDMONTON 4869. QUEENSLAND OF WAILES SHEAD NO KITCHEN -TO SPLASHBAW FOR THE MIN. ONPLANT HEIGHT NEED SALE: OCT 2018 RAWNER TILE: SALE OF AND KITCHEN - OBEC LICENCE: TH DRAWNG TILE:	WATURAL E WITH SELECTED non-slip where opend (i.e. Vinyl, Viscos STEG of T REQUIRES FRAMING AND VISCOS FRAMING AND VISCOS SECTION (See Still of T REQUIRES FRAMING AND VS OF ROOF SEPARATING (FRL) 60/60/60 equal to CONCRETE ELOCK MASO NUMBER RR/05/3 943.Rpt6 (Rw NEFER DETAILS FOR EXTENT OF V HEIGHT AND TERMINATION WITH TO FOODS VALL ACOUSTIC CE EQUIRES LAYER BOARD DIRECT UPTO UVSCOS INSTALL UPTO UVSCOS INSTALL TO CELLING ONLY SEPARATING WALL: ACOUSTIC Rw+Cw SO min. equal to 'GYPROCK System CSR7/ which utilises block wall system v an Rw value >41 VMAL ACOUSTIC CE EQUIRES LAYER BOARD DIRECT UPTO UVSCOS INSTALL UPTO UVSCOS INSTALL UPTO UVSCOS INSTALL UPTO UVSCOS INSTALL UNCES SECIFIED MILE ACOUSTIC SYSTEM UP TO ROOF CLADDING U/S. REFER DETAILS A ALLOWED GAP WITH ROOF CLADDIN WALL SURDOWNING AND HTH ROOF CLADDIN OR CORRIDOR UVNG (RCI) WALLS DIVING A BEDBOOM LIVING REFER DETAILS I UNUSS SECIFIED WALLS SURFICIENT OR CORRIDOR WALLS UNITH ROOF CLADDIN BEDBOOM LIVING A BEDBOOM FROM BEDBOOM LIVING A BEDBOOM FROM BEDBOOM LIVING A BEDBOOM FROM BEDBOOM AND KITCHEN AD KITCHEN OF WALLS DIVING A BEDBOOM FROM BEDBOOM FROM BED	non-stip where por Converte ELOCK MASO por Converte ELOCK MASO MANE: 'ADBRI': TEST/OPINION NUMBER RR/05/3 943.Rpt6 (Rw REFER DETAILS FOR EXTENT OF 1 HEIGHT AND TERMINATION WITH T CONVERSING AND INFORMATION VARE SIDE OF INFORMATION VARE SIDE OF INFORMATION ACOUSTIC CE EQUIRES RECOUSTIC RW+Cw S0 min. equal to 'GYPROCK System CSR7/ which utilises block wall system v an Rw value >41 ACOUSTIC RW+Cw S0 min. equal to 'GYPROCK System CSR7/ which utilises block wall system v an Rw value >41 ACOUSTIC SYSTEM UP TO ROOF EQUIRES LAYER RECEITRICAL RECEITRICAL RECEITRICAL INFORMATION WITH TO CLADDING U/S. REFER DETAILS I ACOUSTIC SYSTEM UP TO ROOF CLADDING U/S. REFER DETAILS I ALLOWED GAP WITH ROOF CLADDING WALLS SPECIFED DIFFERIT BY OWNER, ALLOWED SPECIFED UNESS SPECIFED DIFFERIT BY OWNER, ALLOWED SPECIFED WALLS TUD WALLS ACOUSTIC NUMESS SPECIFED WALLS TUD WALLS ACOUSTIC NUMESS SPECIFED WALLS TUD WALLS ACOUSTIC NUMESS SPECIFED WALLS TUNG & BEDROOM FROM BEDROOM (PATH ROOF CLADDING (CINNOW AND ENSURE MANDER WALLS TUNG (WITH ROOF CLADDING (CINNOW AND ENSURE MANNESS SPECIFED WALLS TUNG KITCHEN OR CORRIDOR Phone: 0428 294 235 EDMONTON AND ENSURE -UPTO CELING DesignerMedium RiseOBCC LICENCE: 111 PROFECT: ADATE: 0CT 2018 CALLE AS SHOWN ON 'A3 DEANING TITLE: DATE: 0CT 2018 CALLE AS SHOWN ON 'A3 DEANING TITLE:	 MADEERA PMAN BATHRUM AND ENSURE - UP TO CEILING LAUNDRY AND KITCHEN - TO SPLASHBAY OF WATER VESSELS AND CONTINUE FOF LENGTH OF BENCH UPON. CONFIRM OW FOR THE MIN. COMPLIANT HEIGHT NEED MONTON 4869. QUEENSLAND GREEGORY G TERZI Academic Distances Building DesignerMedium Rise QBCC LICENCE: 111 PROJECT: PROJECT: DATE: OCT 2018 SCALE: AS SHOWN ON 'A3' DRAWING TITLE: 	phone: 0428 294 235 EDMONTON 4869. QUEENSLAND EGORY G TERZI Architecture Technology Building Design & Building DesignerMedium RiseQBCC LICENCE: 111 CT: WALSH STREET DATE: OCT 2018 SCALE: AS SHOWN ON 'A3' DRAWING TITLE:	CT: WALSH STREET DEALE: AS SHOWN ON 'A3' DRAWING TITLE: DRAWING TITLE:	phone: (GREGORY G -Building Desig PROJECT: 231 WALSH	COTHER INTERNAL STUD WALLS ACOUSTIC INSULATION: Second Stress UNLESS SPECIFIED DIFFERENT BY OWNER, ALLOW 70mm ACOUSTIC BULK WALL INSULATION (R-17) BY OWNER, ALLOW 70mm ACOUSTIC BULK WALL NULLS SURROUNDING BATHROOM, TOILETS, L'DRY, ENSUITE WALLS DIVIDING A BEDROOM FROM BEDROOM, LIVING, MEDIA, KITCHEN OR CORRIDOR • WALLS NULLS TILLING EXTENT ELECTED WALLS TILLING EXTENT ELENGTH OF BENCH UPON AND ENSUITE - UPTO CEILING LAUNDRY AND KITCHEN -TO SPLASHBAY OF WATER VESSELS AND CONTINUE FOR LAUNDRY AND KITCHEN - TO SPLASHBAY OF WATER VESSELS AND CONFIRM OW FOR THE MIN. COMPLIANT HEIGHT NEEDB FOR THE MIN. COMPLIANT HEIGHT NEEDB ADATE: OCT 2018 294 235 EDMONTON 4869. QUEENSLAND ZZ Archistering Transing Building Design & SCALE: AS SHOWN ON 'A3' DRAWING TITLE:
SEPARATING WALL: FIRE RATING (FRL) 60/60/60 equal to CONCRETE BLOCK MASO NUMBER RR/05/3 943.Rpt6 (Rw REFER DETAILS FOR EXTENT OF I HEIGHT AND TERMINATION WITH TO OF ROOFS SEPARATING WALL: ACOUSTIC Rw+Cw 50 min. equal to 'GYPROCK System CSR71 which utilises block wall system v an Rw value >41 OTHER INTERNAL STUD WALLS ACOUSTIC UNLESS SPECIFIED DIFFERIT BY OWNER ALLOWED GAP WITH ROOF CLADDING UNLESS SPECIFIED DIFFERIT BY OWNER ALLOWED GAP WITH ROOF CLADDIO OR OORNOON BATHROOM, TOULTS, L'DROUNDING BATHROOM, TOULTS, L'DRY, ENSUTE UNLESS EDMONTON 4869. QUEENSLAND OR VALLS TILING EXTENT • MAILS TILING EXTENT • LAUNDRY AND KITCHEN AD ENSUITE -UPTO CELLING • LAUNDRY AND KITCHEN -TO SPLASHBAD OF WATER VESSELS AND CONTINUE FOR ENGINE BENCH UPON. CONFIRM OW FOR THE MIN. COMPLIANT HEIGHT NEED OF WATER VESSELS AND CONTINUE FOR LENGTH OF BENCH UPON. CONFIRM OW FOR THE MIN. COMPLIANT HEIGHT NEED OF WATER VESSELS AND CONTINUE FOR LENGTH RISE - OBCC LICENCE: 111 DRAWING TITLE: DRAWING TITLE: DRAWING TITLE:	BLC. Fe with EXPOSED SEPARATING WALL: FIRE RATING WALL: FIRE RATING WALL: FIRE RATING WALL: FIRE RATING CHELLS SO/GO/GO equal to CCNCRETE BLOCK MASO aqual to CCNCRETE BLOCK MASO aqual to CCNCRETE BLOCK MASO MANE. 'ADBR'. TEST/OPINION NUMBER RR/05/3 943.Rpt6 (Rw REFER DETAILS FOR EXTENT OF V HEIGHT AND TERMINATION WITH TO FROOFS SEPARATING CE SECURES LAYER BECARD DIRECT IVS OF ROOF SEPARATING WALL: ACOUSTIC Rw+Cw 50 min. equal to 'CYPROCK System CLADDING U/S OF CLADDING U/S NOT RECORFICAL TWICES INSTAL UP OU /S OF RECORFICAL TWICES INSTAL UP OU /S OF RECORFICAL TWICES INSTAL UNCLUMENT ONLY MANE. XOUSTIC Rw+Cw 50 min. equal to 'CYPROCK System CSR74 which utilises block wall system v and Rw value S41 ALOWED GU/S REFER DETAILS ALLOWED GU/S REFER DETAILS ALLOWED GU/S REFER DETAILS INSULATION REDROM, UWING VITH ROOF CLADDIN OR ORONOM AND SYSTEM UP TO ROOF CLADDING U/S REFERED DIFFERENT BY OWNER, ALLOW TOME AUST STREAM UP TO ROOF OF MATE WALLS SUBROUNDING A BEROOM, WALL NULLS STREAM ALLOW TO RADIES STREAM OF WALLS STREAM ALL TILES. SELECTED WALLS TIME ENTER • WALLS SUBROUNDING A BEROOM FROM BEDROM, UWING A BEROOM FROM AUXING A BEROMINA ABENJUTE -UPTO CELLING ONLY OR THE WALLSTILLING ENTER • MARE AWALL TILES. SELECTED WALLS TILING ENTER • MALE MARENT BEAM OF WATE VESSELS AND CONTINUE FOR • MALE STREAM ALL TILES. SELECTED WALLS TILING ENTER • MALS DIVIST UPPN, CONFIRM FROM OR THE WAL COMPLANT HEIGHT NEED OF MATE WALLS THEE SHOWN AND ENSUTE -UPTO • LANNER ABATHORY AD KITCHEN -TO SPLASHBA OF WATE VESSELS AND CONTINUE FOR • MARE MARENT BEAM • MAREE AS SHOWN ON AS • ON THE WAL COMPLANT HEIGHT NEED ORAMINE THE MAL COMPLANT HEIGHT NEED ORAMINE THE MAL COMPLANT HEIGHT NEED ORAMINE THE AS SHOWN ON AS • ON THE WAL COMPLANT HEIGHT NEED ORAMINE THE AS SHOWN ON AS • ON THE WALL OWNER THE AS SHOWN ON AS • ON THE WALLSTICHEN TO SHOWNER AND • ON THE WALLSTICHEN TO SHOWNER AN	WATURAL E WITH SELECTED non-slip where opend to CONCRETE BLOCK MASO equal to CONCRETE BLOCK MASO equal to CONCRETE BLOCK MASO MUMBER RR/05/3 943.Rpt6 (Rw NUMBER RR/05/3 943.Rpt6 (Rw NUMBER RR/05/3 943.Rpt6 (Rw NUMBER RR/05/3 943.Rpt6 (Rw NUMBER RR/05/3 943.Rpt6 (Rw REFER DETAILS FOR EXTENT OF V HEIGHT AND TERMINATION WITH TO SEPARATING WALL: ACOUSTIC RECOURES LAYER BOORD DIRECT UPTO U/S OF ROOF R ELECTRICAL ENGLINE SINCE OF EQUIRES LAYER BOORD DIRECT UPTO U/S OF NOLT R ELECTRICAL SINCALS INSTALL OF ROOFS MALL ACOUSTIC RECOURES LAYER BOORD DIRECT UPTO U/S OF ROOF R ELECTRICAL ENGLINE ONLY NUMBER RR/05/3 943.Rpt6 (Rw RW value 541 ACOUSTIC SWHEN UP TO ROOF CLADDING U/S. REFER DETAILS I ACOUSTIC SYSTEM UP TO ROOF CLADDING U/S. REFER DETAILS I UNESS SPECIFIE UNESS SPECIFIE OFFERENT SELECTED WALLS TIND WALLS ACOUSTIC NUMBER RW VALUE VIENT ALLOWED GAP WITH ROOF CLADDIN OR CORDOR WALLS SUBOWNING A BEDOWN ROM OR CORDOR UNICHING RETURE SELECTED WALLS TIND WALLS ACOUSTIC UNESS SPECIFIE UNESS SPECIFIE UNESS SPECIFIE UNESS SPECIFIE UNESS SPECIFIE OFFERENT SELECTED WALLS TIND WALLS ACOUSTIC NAME A BEDOWN AND ENSUTE UNICHING RETURE SELECTED WALLS TIND WALLS ACOUSTIC UNESS SELECTED WALLS ACOUSTIC WALLS UNING A BEDOWN AND ENSUTE UNICES SPECIFIE OF WALLS WALLS TIND (R-17) OF WALLS WITH ROOF CLADDIN OR CORDOR OF WALLS WALLS TIND WALLS ACOUSTIC UNESS SELECTION OF WALLS WALLS TIND (R-17) OF WALLS WALLS TO SELECTION (R-17) OF WALLS WALLS TIND (R-17) OF WALLS WALLS TO SELECTION (R-17) OF WALLS WALLS TO SELECTION (R-17) OF WALLS WALLS TO SELECTION (R-17) OF WALLS WALLS TO S	non-slip where openNG (ie. Vinyl, Construction of the Construction of the Constructi	PROJECT: Building DesignerMedium Rise - OBCC LICENCE - UNDRY AND KITCHEN -TO SPLASHBAY OF WATER VESSELS AND CONTINUE FOR DATE: 021 Architectural Technology Building Design & SCALE: AS SHOWN ON 'A3' DATE: 0CT 2018 SCALE: AS SHOWN ON 'A3' DATE: 0CT PLAN	phone: 0428 294 235 EDMONTON 4869. QUEENSLAND EGORY G TERZI Andhiedural Tehniaday Building Design & Building DesignerMedium RiseQBCC LICENCE: 111 ECT: WALSH STREET REEBA BCALE: AS SHOWN ON 'A3' DRAWING TITLE: DRAWING TITLE: BCOOR PLAN	CT: WALSH STREET DATE: OCT 2018 SCALE: AS SHOWN ON 'A3' DRAWING TITLE: 10 FLOOR PLAN	phone: (GREGORY G -Building Desig PROJECT: 231 WALSH MAREEBA MAREEBA	COTHER INTERNAL STUD WALLS ACOUSTIC INSULATION: STORE UNLESS SPECIFIED DIFFERENT BY OWNER, ALLOW 70mm ACOUSTIC BULK WALL INSULATION (R-1.7) BUROUNDING BATHROOM, TOILETS, L'URY, ENSUITE • WALLS SURROUNDING A BEDROOM, ROURIDOR WALLS DIVIDING A BEDROOM, ROM BEDROOM, LIVING, MEDIA, KITCHEN OR CORRIDOR WET-AREA WALL TILES: BELECTED WALLS TILING EXTENT SELECTED WALLS TILING EXTENT OF WALES TILING EXTENT OF WALES TILING AND ENSUITE - UPTO CEILING BATHROOM AND ENSUITE - UPTO OF WATER VESSELS AND CONFIRM OW FOR THE MIN. COMPLIANT HEIGHT NEEDB OF THE MIN. COMPLIANT HEIGHT NEEDB OF THE MIN. COMPLIANT HEIGHT NEEDB OTATE: OCT 2018 SCALE: AS SHOWN ON 'A3' DRAWING TITLE:

ROOM CEILING EXHAUST FAN

(820)


DOOR LEAF SIZE WALL CONTROL


HX__XHC HOSE COCK


E

JOINT

Version: 1, Version Date: 13/04/2022

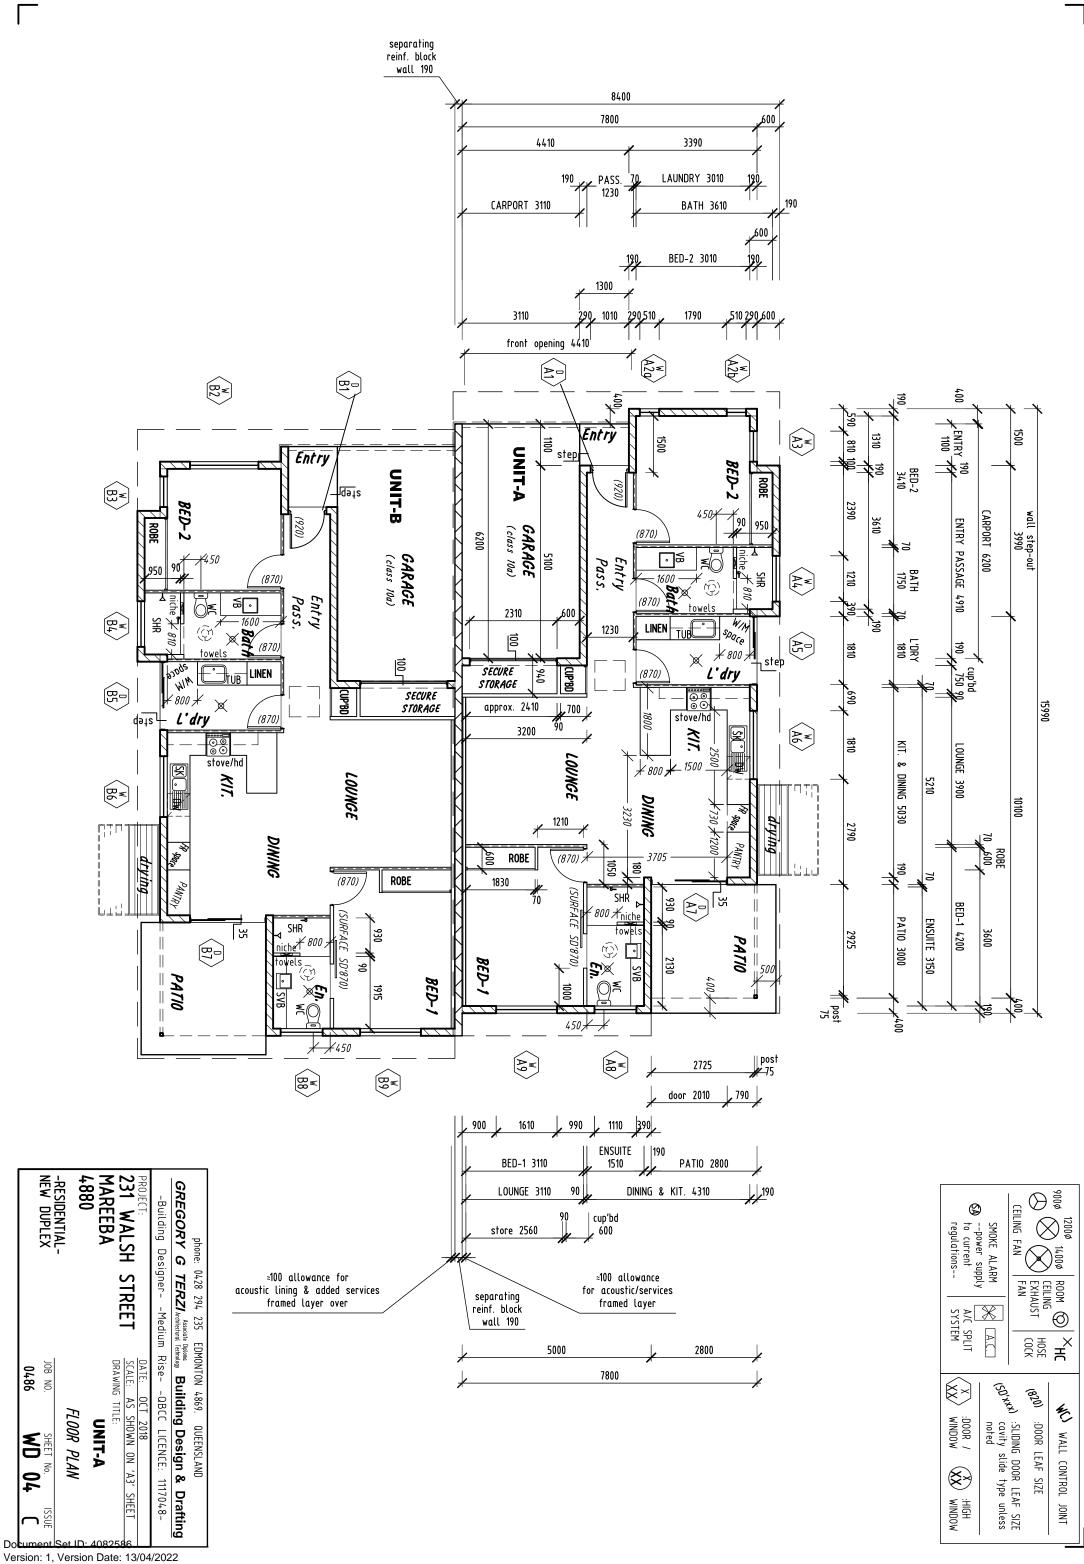


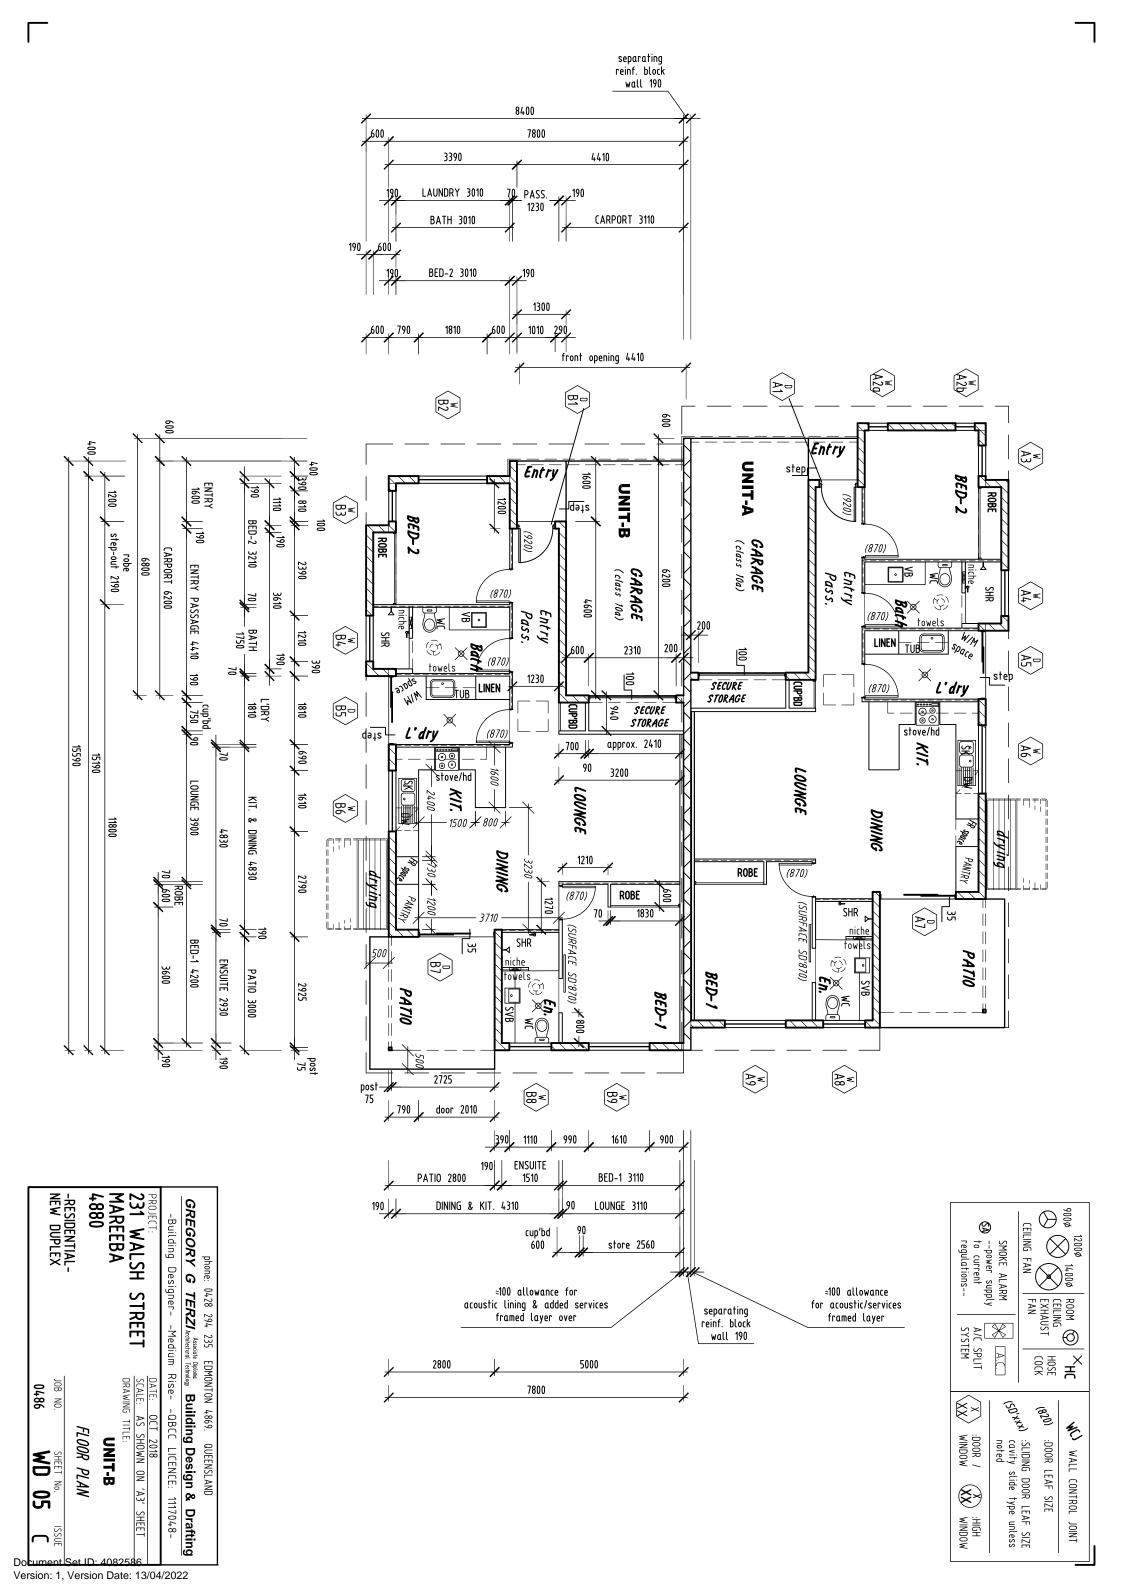

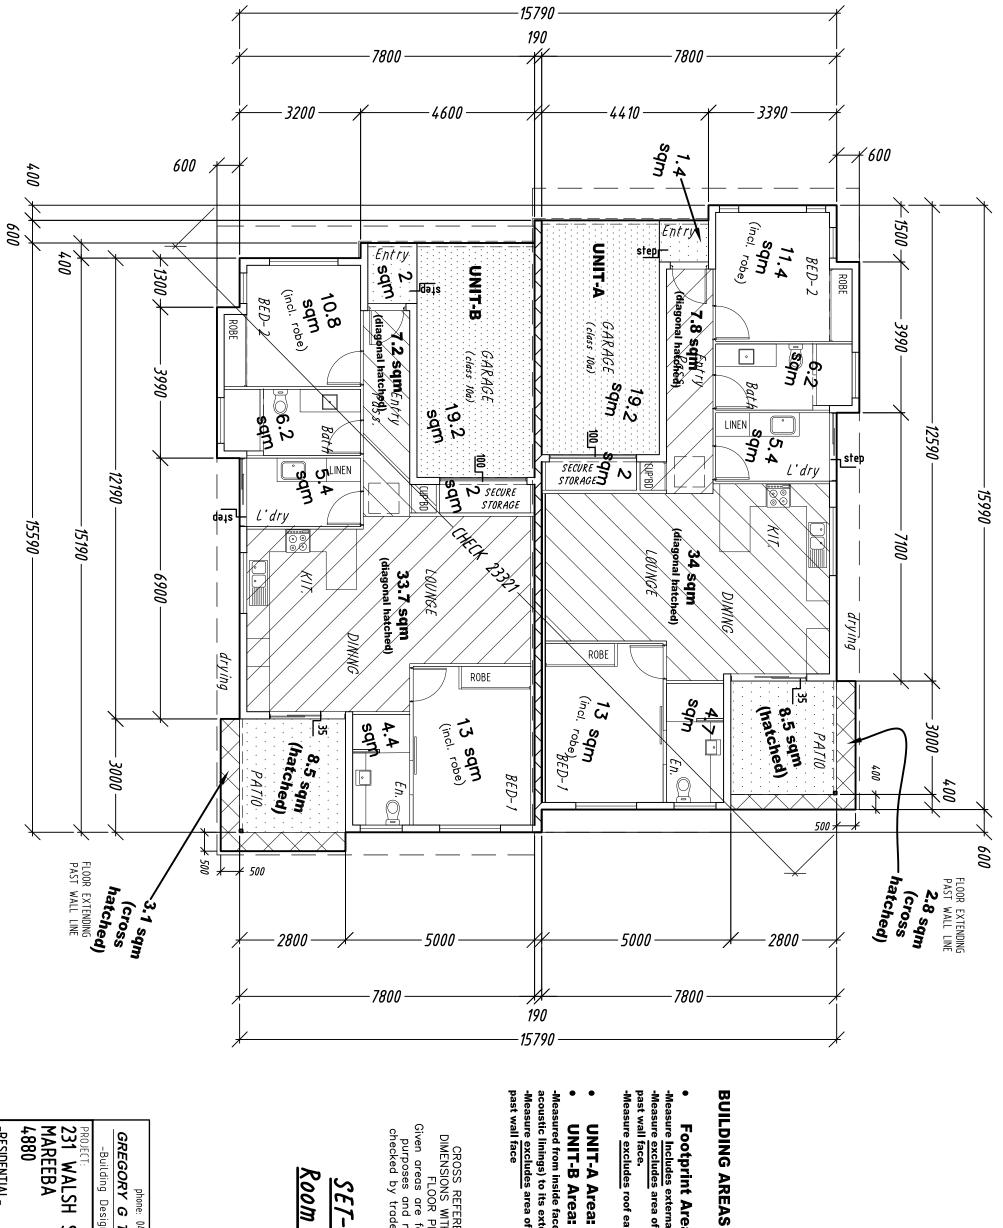

 $\[\]$


231 WALSH STREET MAREEBA 4880 -RESIDENTIAL- NEW DUPLEX	phone: 04.28 294 235 GREGORY G TERZIArchited -Building DesignerMed PROJECT:	(1:10		CROSS REFERENCE ALL DIMENSIONS WITH CURRENT FLOOR PLAN. Siven areas are for estimating purposes and need to be purposes and need to be checked by trade contractor.	UNIT-A Area: 123 sqm UNIT-B Area: 122 sqm red from inside face of separation wall (and ic linings) to its external face of exterior walls. re <u>excludes</u> area of outdoor floors projecting all face	Footprint Area: 250 sqm re <u>Includes</u> external walls. re <u>excludes</u> area of outdoor floors projecting all face. re <u>excludes</u> roof eaves.
DRAWING SET JOB NO. 0486	EDMONTON 4869. Table Diploma Tural Tetmology Buildin Tural Tetmology DATE: 0CT	(1:100 ON A3)	<u> DUT PLAN &</u> Areas (sqm)	NCE ALL CURRENT AN. r estimating red to be contractor.	SQM SQM paration wall (and face of exterior walls, for floors projecting	50 Sqm 5. or floors projecting
000 PLAN areas 06 06 06 06 06 06 06 06 06 06 06 06 06	Drafting					

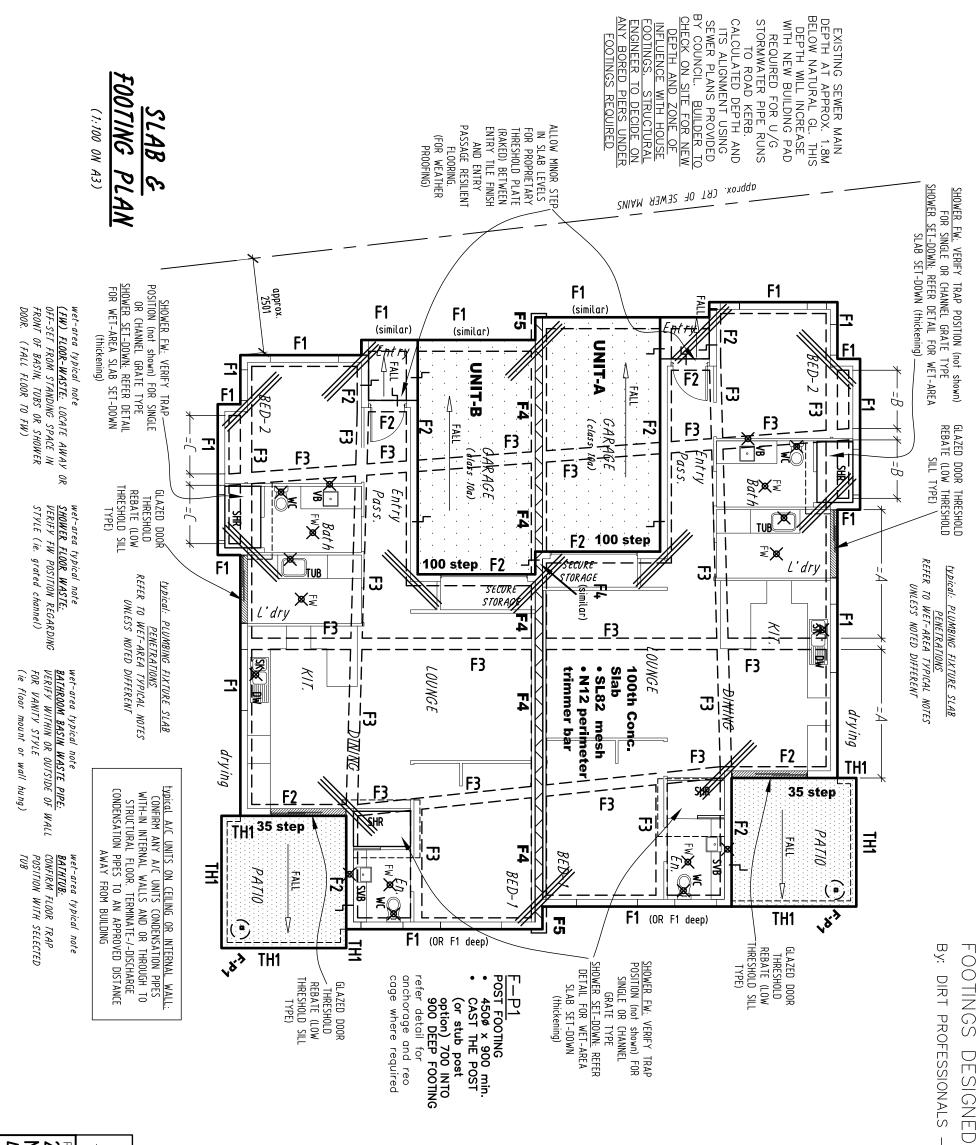


	RESIDENTIAL- IEW DUPLEX JOB NO. SHEET No. 0486 WD07	TLE:	Lding DesignerMedium RiseQBCC LICENCE: 11	phone: 0428 294 235 EDMONTON 4869. QUEENSLAND GREGORY G TERZI Artistatian Temponan Building Design & Di	-SCJ- SAWN CUT JOINT -DTJ- DEEP TOOLED JOINT	JWN FLOOR P ? PLUMBING (?VICE (refer ground level	J-N12 2000 LONG TRIMMER BARS TIED TO U/S OF SLAB	Stab finish notes: ENCLOSED GARAGE FLOOR AREA	 stab finish notes: SEMI-ENCLOSED OUTDOOR FLOOR AREA UNLESS SELECTED TO HAVE OTHER FINISH OVER, ALLOW CONCRETE SURFACE TO HAVE A DEGREE OF ANTI-SLIP FOR THE REQUIRED LEVEL OF RAINWATER EXPOSURE (this includes possible crossing of surface water from adjacent run-off and ponding) ALLOW SAW CUT JOINTS WHERE NO FLOOR TILE FINISH OVER IS WANTED 	TERMITE CONTROL at GROUND LEVEL: PENETRATIONS, JOINTS, PERIMETER SEALING AND INSPECTION CLEARANCES APPLY TO CONC. SLAB ON GROUND ACTING AS BARRIERRead inconjunction with main notes of 'termite management'	<u>CONCRETE SLAB ON GROUND:</u> REINFORCED CONCRETE SLAB ON WATERPROOF MEMBRANE OVER AN APPROVED GRANULAR BED. (waterproof membrane to be 200um polyethylene film installed to manf. recommendations). EARTHWORKS AND SLAB INSTALLED TO STRUCTURAL ENGINEERS DESIGN MOTES
Do	ISSUE	'A3' SHEET 6		ND A Drafting					<u>AREA</u> ? ? face LE		

Version: 1, Version Date: 13/04/2022


Job Reference: 20485 WITH SOIL INVESTIGATION REPORT I CLASS 'M'

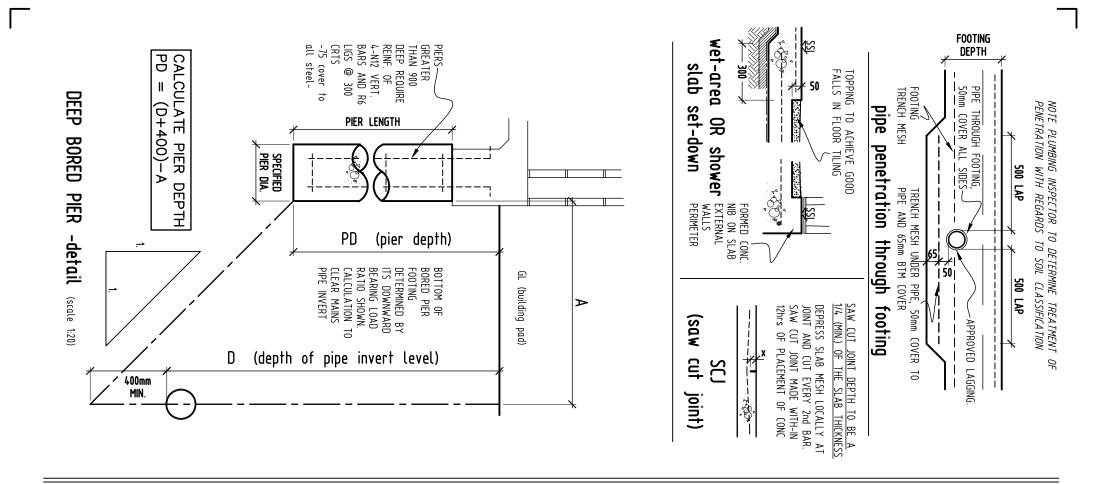

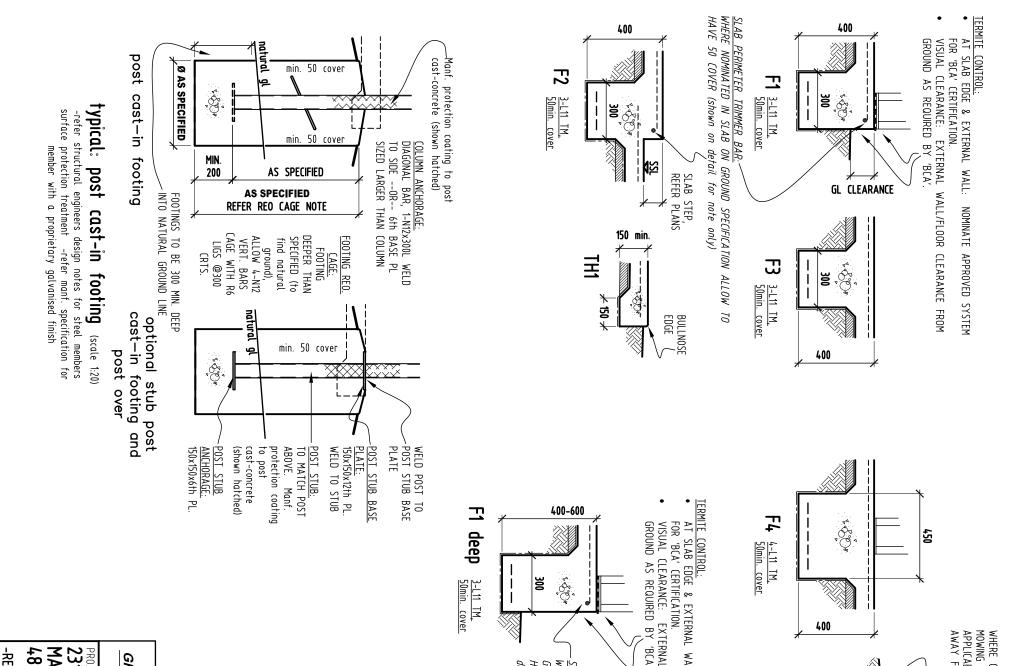

ERE CONCRETE PATHS OR WING STRIPS NOT LICABLE, FALL GROUND LINE AY FROM WALL

<u>SLAB PERIMETER 1</u> WHERE NOMINATED GROUND SPECIFICA; HAVE 50 COVER (detail for note or ote of	FS L: NOMINATE WALL/FLOOR	
RIMMER BAR: ION ALLOW TO I'rown on (y)	<u>nin. cover</u> PROVED SYSTEM EARANCE FROM	NOTE EXTERNAL COVER
		AL COVER REO
	<u>RIMETER TRIMMER BAR</u> IOMINATED IN SLAB ON SPECIFICATION ALLOW or note only) or note only)	FS <u>4-L11 TM</u> , <u>50min. cov</u> ALL/FLOOR CLEARANCI <i>IND SPECIFICATION ALL</i> <i>FO COVER (Shown of the note only)</i>

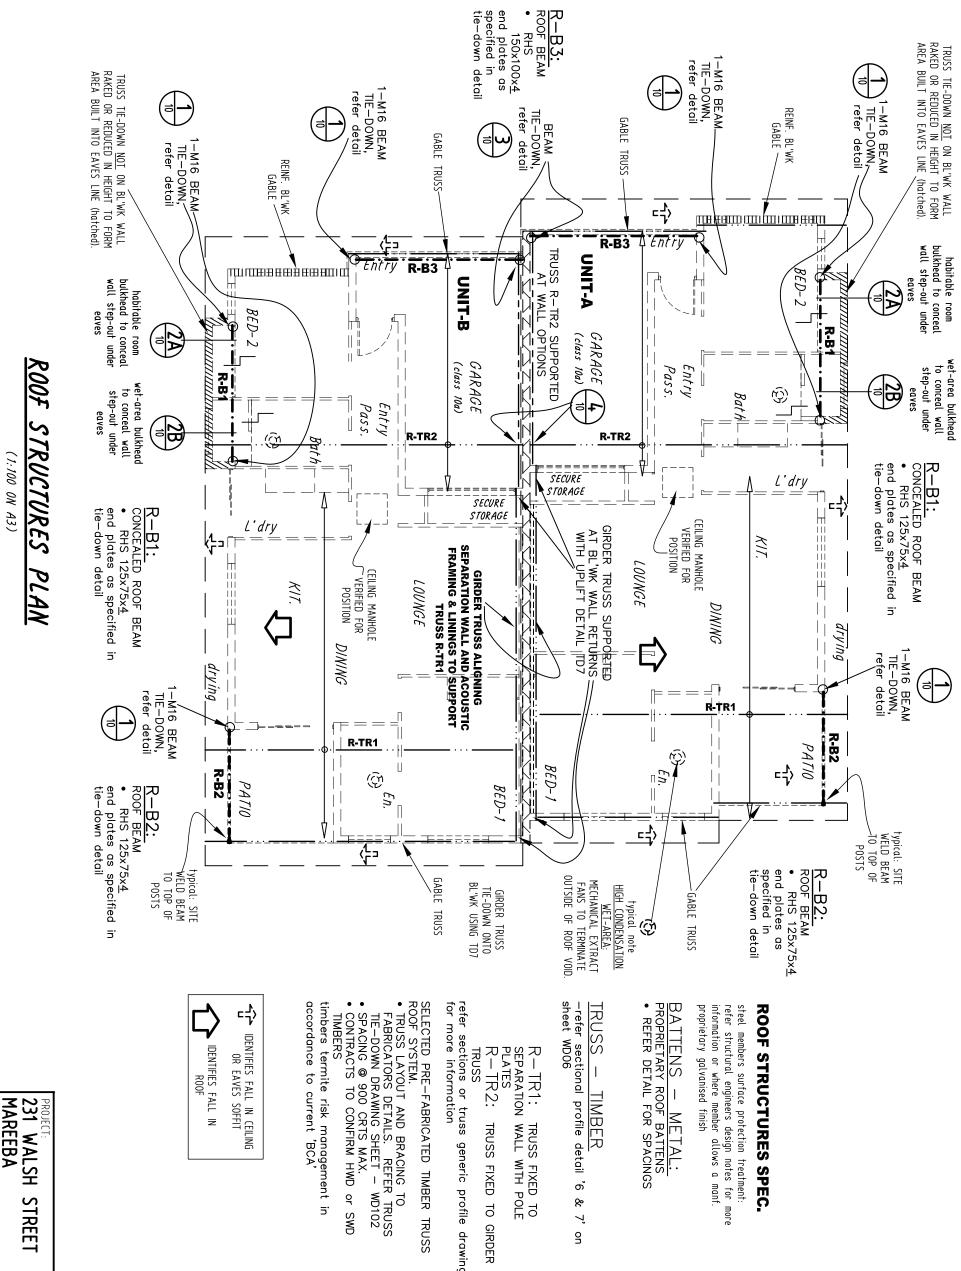

		NEW DUPLEX	-RESIDENTIAL-	+000	ואתררטא		154 WAISH STRFFT	PROJECT:		
							STREET			
	0486	JOB NO.			ROOF	DRAWING TI	SCALE: AS	DATE: OC		
	WD 09	SHEET No.			ROOF STRUCTURES PLAN	TLE:	SCALE: AS SHOWN ON 'A3' SHEET	T 2018		
Do		ISSUE	Set	י י בו	PI AN 408	3258	SHEET			
Ver	sion	: 1,	Ver	sio	n Da	ate:	13	/04	/202	22

GREGORY G TERZI Architectural Technology Building Design & Drafting

phone: 0428 294 235 EDMONTON 4869. QUEENSLAND

-Building Designer- -Medium Rise- -QBCC LICENCE: 1117048-

steel members surface protection treatment: refer structural engineers design notes for more member allows a manf. finish


FOR SPACINGS


-refer sectional profile detail '6 & 7' on sheet WDO6 MBER

TRUSS FIXED TO GIRDER


truss generic profile drawing

SOFFIT

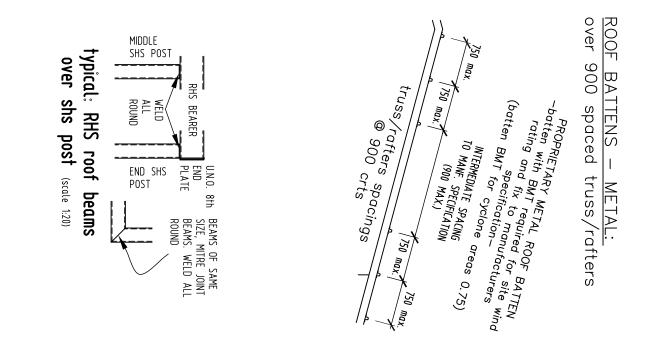

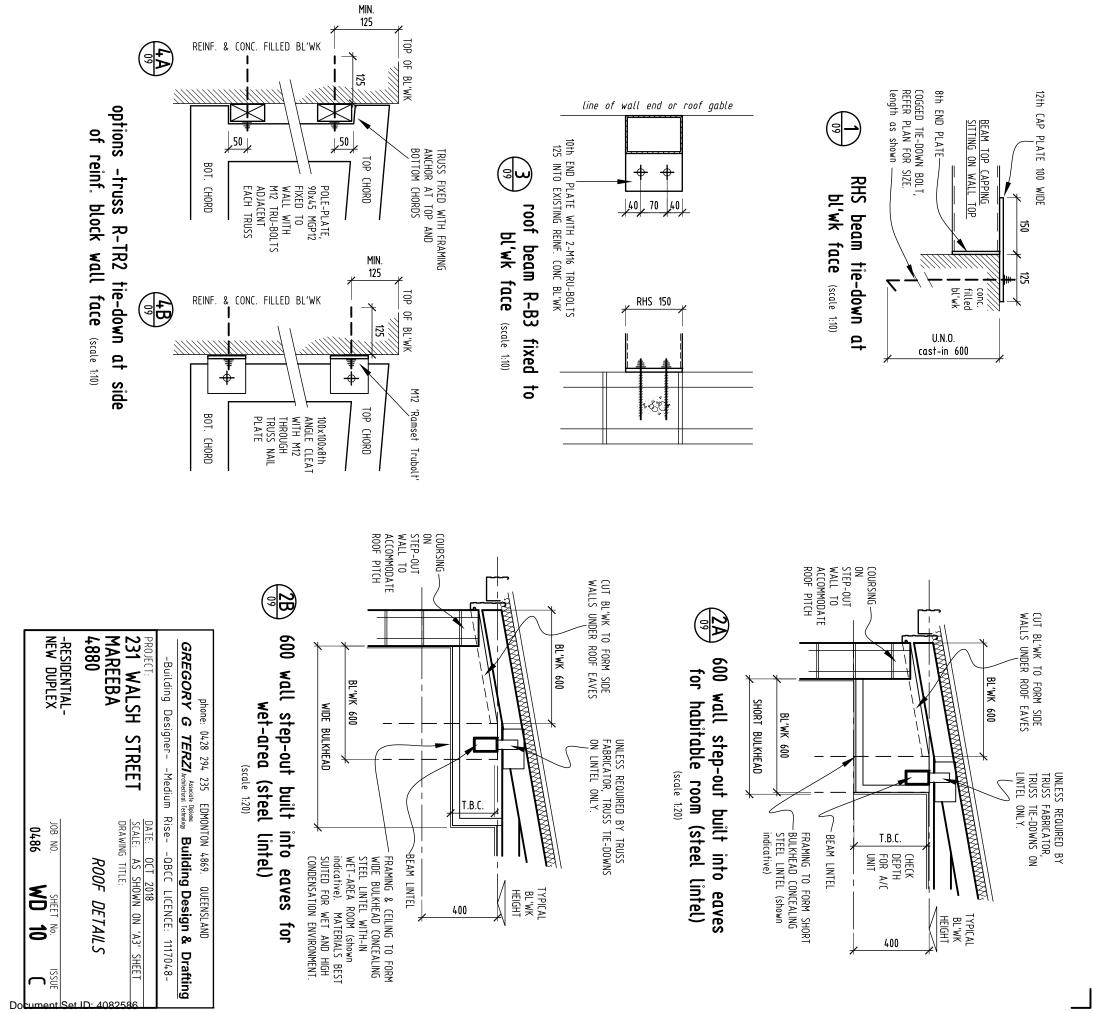


Version: 1, Version Date: 13/04/2022

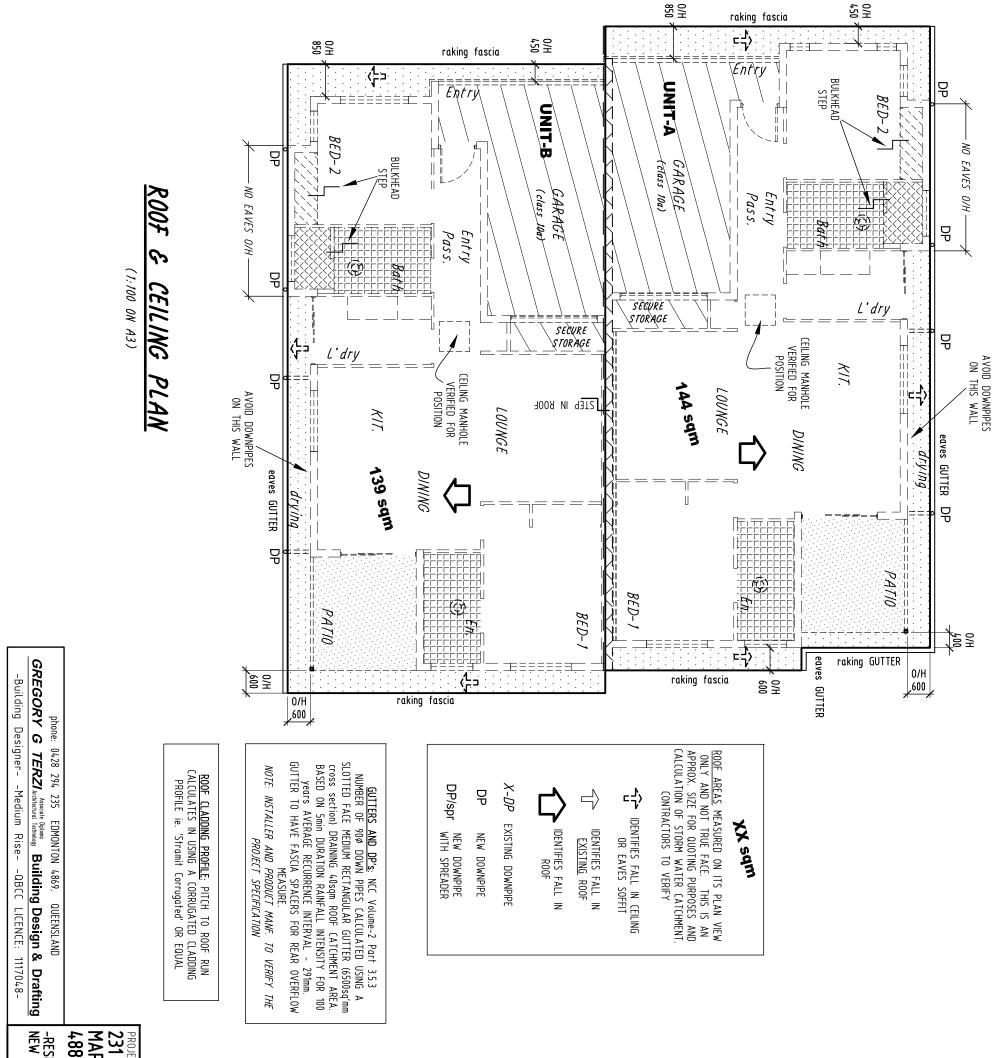

	AREEBA 380 W DIIDI FX	Roof Thermal Insulat metal roof sheeting: -FORMING CLASS 1a BUILDING E ODIRECT UNDER METAL ROO CONTINUE TO EAVES, INST INSTRUCTIONS AN APPROVIN NSULATION LAYER WITH / 'R-value' OF min. R1.8 R-value). PREFERRED PRI BULK INSULATION BONDED REFLECTIVE FOIL AND BRE -VERANDAH or OUTDOOR LIVING - U.N.O. TO MATCH MAIN HO -GARAGE (10a)	Semi-ENCLOSED GARAGE <u>CELLING:</u> unless nominated different • ON BATTENS, FIBRE CEMENT SHEETING OR WHERE PROTECTED IN ACCORDANCE TO MANE. SPECIFICATION A WATER RESISTANT PLASTERBOARD CELLING. (refer manf. spec. for application suited to site conditions)	WET AREA CELLING -HIGH CONDENSATION unless nominated different 9 ON BATTENS, FLUSH JOINTED WATER RESISTANT PLASTERBOARD CEILING	INTERNAL CELLINGS: unless nominated different • ON BATTENS, FLUSH JOINTED PLASTERBOARD CELLING	TYPICAL NOTE CEILING and SO • CONFIRM CORNER TRIM (C • MULTI-COAT PAINT FINISH • PROPRIETARY FINISH • FIBRE CEMENT PRODUCTS • PVC STRAIGHT JOINERS
+86 WD 11 B	DATE: OCT 2018 SCALE: AS SHOWN ON 'A3' SHEET G DRAWING TITLE: ROOF & CEILING PLAN	Lation for ng: La Envelope Roof Sheeting and Install to Manf. Roof Sheeting added PRODUCT TO BE OF DED BETWEEN BREATHER MEMBRANE. VING ROOFS 4 HOUSE	WATER RESISTANT PLASTERBOARD CEILING. (refer manf. spec. for application suited to site conditions) INTERNAL BULKHEAD OR FEATURE CEILING: REFER TO CEILING PLAN FOR MORE INFORMATION		-ROOF EAVES SOFFIT unless nominated different • ON BATTENS, FIBRE CEMENT SHEETING IN ACCORDANCE TO MANF. SPECIFICATION	and <u>SOFFITS:</u> TRIM (CORNICE) STYLE T FINISH UNLESS PRODUCT HAS FINISH FINISH CODUCTS TO CONFIRM USE OF DINERS
Version:	1, Version Date: 13/04/202	22				

CEILING LEGEND

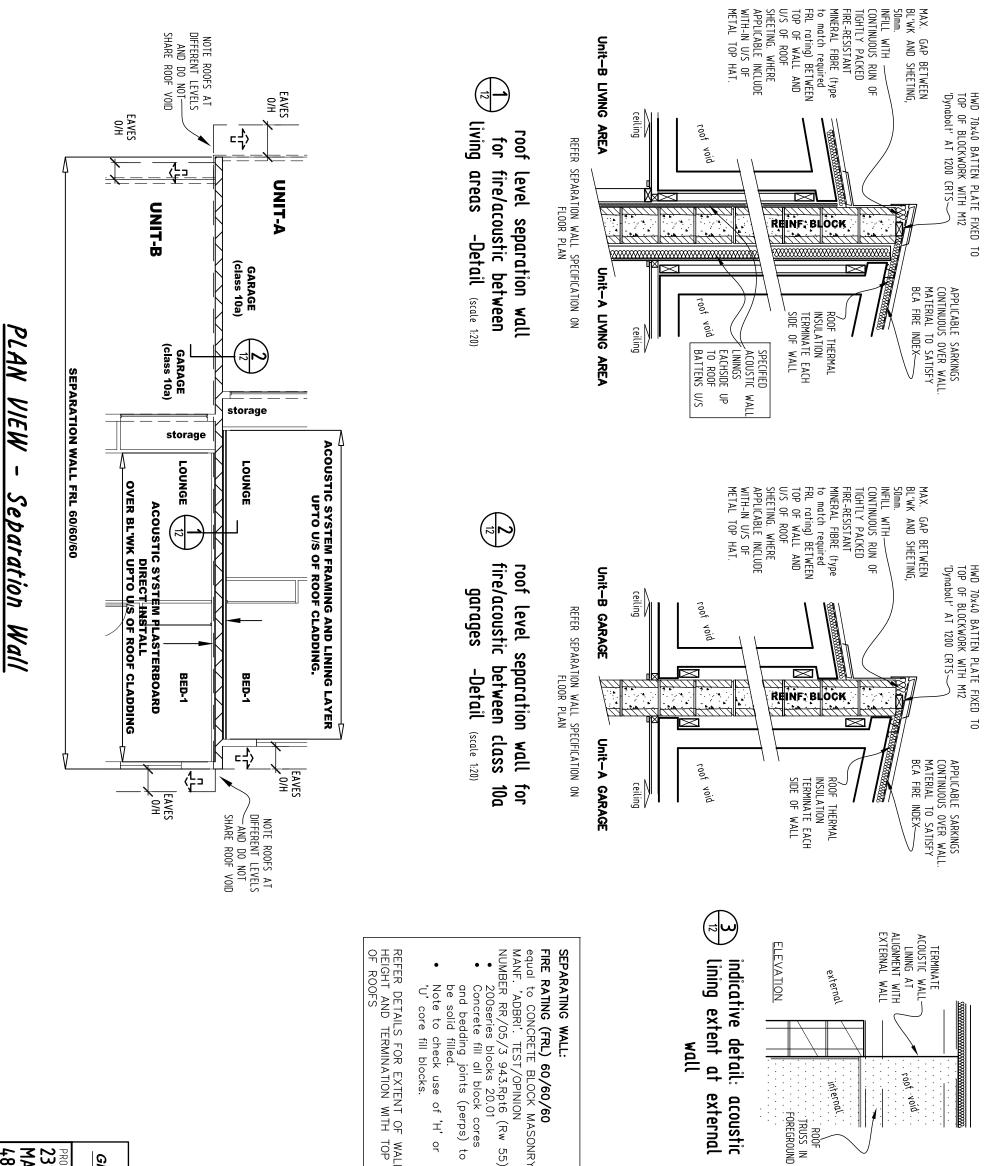


-residential- New Duplex	231 WALSH MAREEBA 4880	phone: GREGORY G -Building Des			55 NRY		
	H STREET	0428 294 235 TERZI Associate ignerMediu	WED GAF	• Unit-B BED- STORAGE: 13 'Soundchek' to 64mm Me MIN. CAVITY AND STUD. STUDS WITH INSULATION	SEPARATING WALL: ACOUSTIC Rw+Cw equal to 'GYPROCK which utilises blocl an Rw value >41 • Unit-A BED- STORAGE: 11 plasterboard	indicative Lining ex	interind
JOB NO. 0486	DATE: OCT 2 SCALE: AS SH DRAWING TITLE: SEPAR -fire	EDMONTON 4869. Diploma Technology Building m RiseQBCC	SYSTEM UP TO U/S. REFER DE GAP WITH ROOF	BED-1, LOUN BED-1, LOUN E: 13mm GY hek' plasterb m METAL STL MITY BETWEEL UD. INSULAT WITH 75 GW MITH 75 GW	VALL: FCw 5 Block block block SED-1, BED-1, BED-1, BED-1, BED-1, Coard f	rive detail: extent at wall	roof void TRU FOREC
WD12	018 10WN ON 'A3' & ATION W,	QUEENSLAND Design & LICENCE: 111	P TO ROOF FER DETAILS FOR ROOF CLADDING	ED-1, LOUNGE, : 13mm GYPROCK ek' plasterboard fixed n METAL STUD. 12mm /ITY BETWEEN MASONRY D. INSULATE BETWEEN /ITH 75 GW 11kg ON	O min. System CSR761 wall system with LOUNGE, nm GYPROCK ixed direct to	: acoustic t internal	ROOF TRUSS IN FOREGROUND
	E	ing				-	


TERMINATE ACOUSTIC WALL LINING AT ALIGNMENT WITH INTERNAL WALL

Version: 1, Version Date: 13/04/2022


(1:100 ON A3)

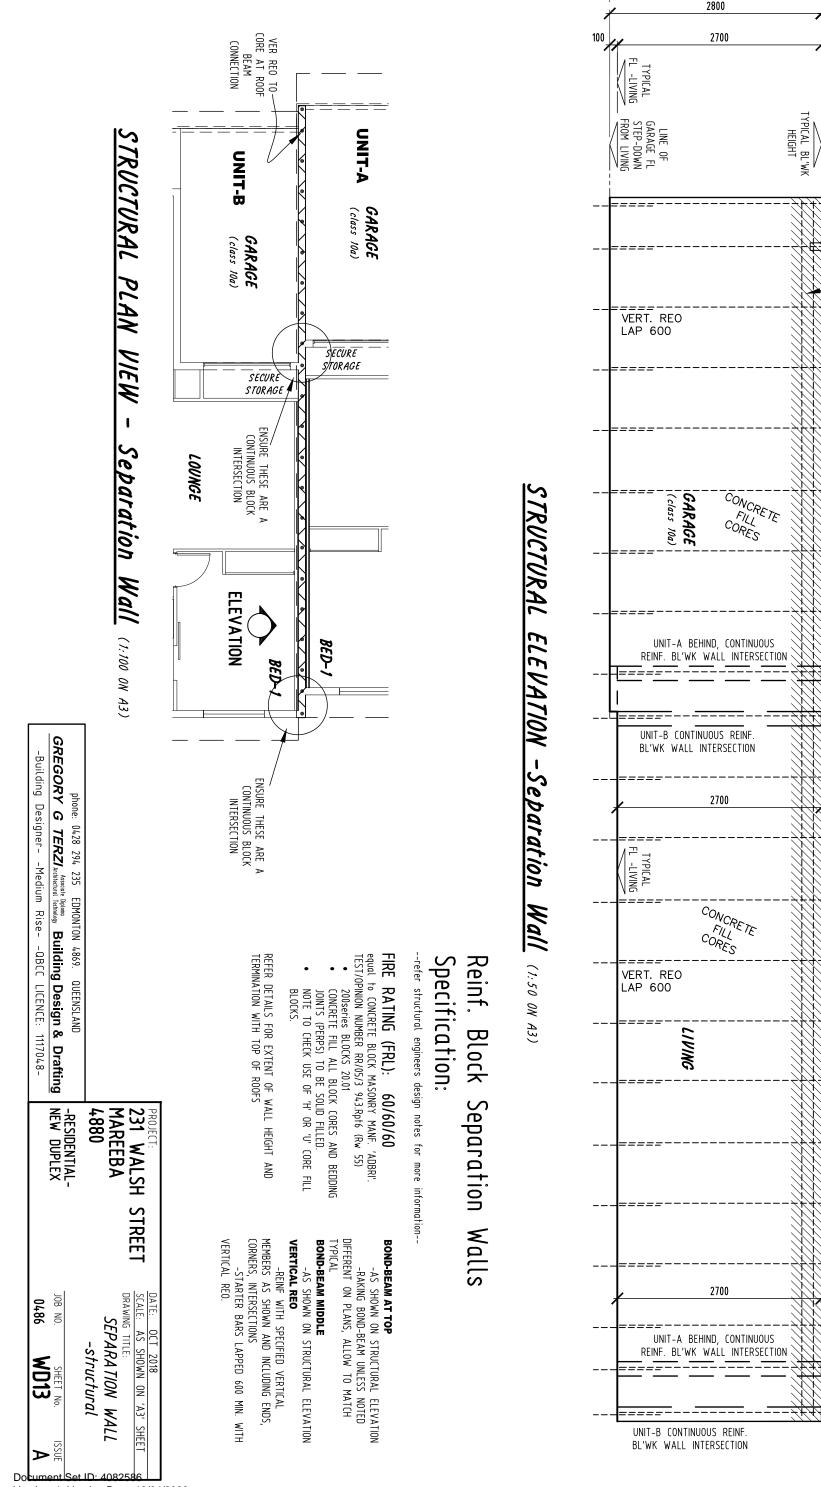




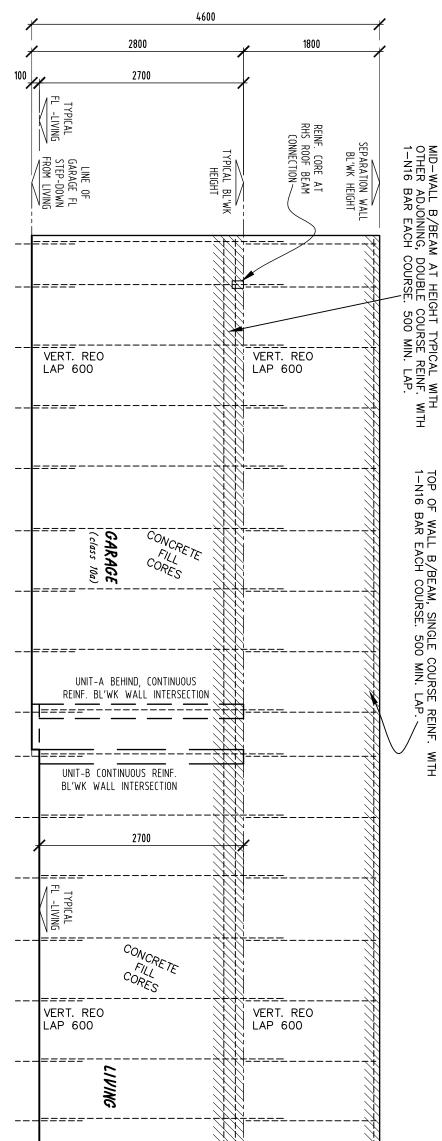



Version: 1, Version Date: 13/04/2022

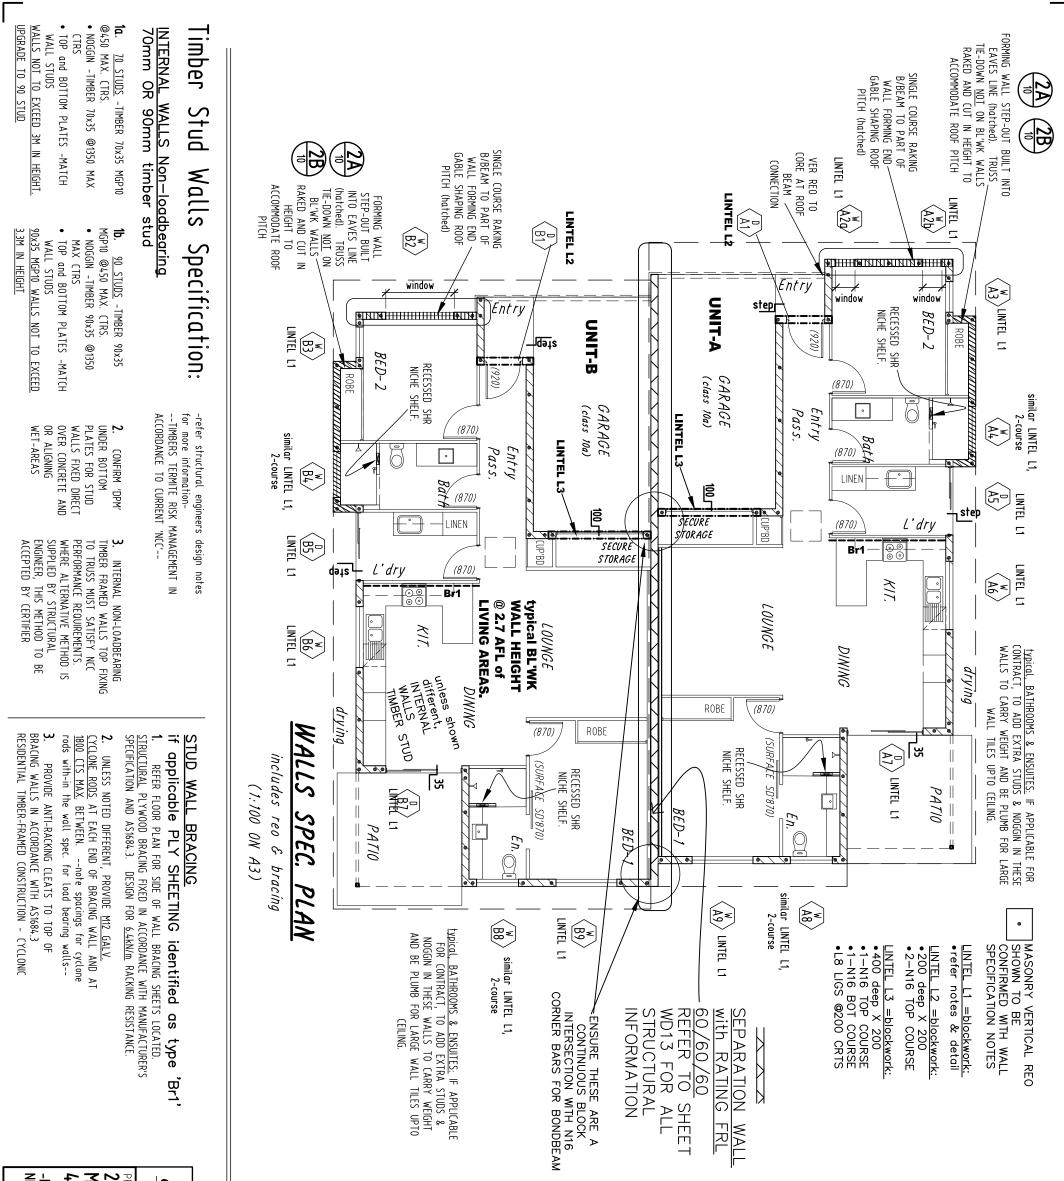


E V RESI	-880 14 14 14 14 14 14 14 14 14 14 14 14 14		II		
residential- Ew Duplex	ROJECT: 131 WALSH STREET 1AREEBA 1880	phone: 0428 294 235 GORY G TERZI Associate Villding DesignerMediu	L8 TIE bars @ 400 CRTS	SEPARATION WA with FRL rating REFER SHEET WD13 FOR L	Keinf. block w Specification: refer structural engineers design typical WALLS SUPPO reinforced 200-serie BOND-BEAM AT UNDER SIDE OF R -DUBLE COURSE BOND-BEAM EACH COURSE, 500 MIN. LAP. -RAKING BOND-BEAM UNLESS PLANS, ALLOW TO MATCH TYPICAL WINDOW SILL BOND/BEAM -SINGLE COURSE BOND/BEAM MINDOW OPENINGS. REINF. WITH 1-1- 200 PAST EACH SIDE OF OPENING LINTELS unless noted differer -TYPICAL LINTELS TO BE REIN BAR WITH L8 TIE BARS @ 400 MA VERTICAL REO unless noted differer -REINF WITH VERTICAL OF W INCLUDING ENDS, CORNERS, INTERSEC OF OPENINGS -PROVIDE ADDITIONAL N12 VEI ADJACENT OPENINGS GREATER THAN COMCRETE FLL ALL CORES CONTAINI BOLTS AND MASONRY ANCHORS -STARTER BARS LAPPED 600 W.C.JDENOTES WALL CONTROL JI ofherwise, DRAWN REFER DETAIL
JOB NO. 0486	DATE: OLI DRAWING TITL WALL F	MONTON 4 modegy Bui Rise		MALL ng or details	Correction Note PPORT PROF PROF PROF PROF PROF PROF PROF PROF PROF PROF PROF PROF PROF PROF PROF PROF PROF PORT PROF PORT PROF PORT PROF PORT PROF PORT PROF PORT PROF PORT PROF PORT PROF PORT PORT PROF PORT PROF PORT PROF
SHEET No.	TE: OCI ZO18 AMING TITLE: VALL PLAN and CONSTRUCTION S	QUEENSLAND Design & LICENCE:			LLS res for more information- TING ROOF blockwork F VF. WITH 1-N16 BAR ED DIFFERENT ON ED DIFFERENT ON EXTEND BOND-BEAM MITH 2-N12 OR 1-N16 RTS S, AND AT EACH SIDE AL BARS TO CORES 0 WIDE MITH VERTICAL RED. S. unless noted
	SPEC. HARLES AGE 13/0	& Drafting			O. K DE S M Ition

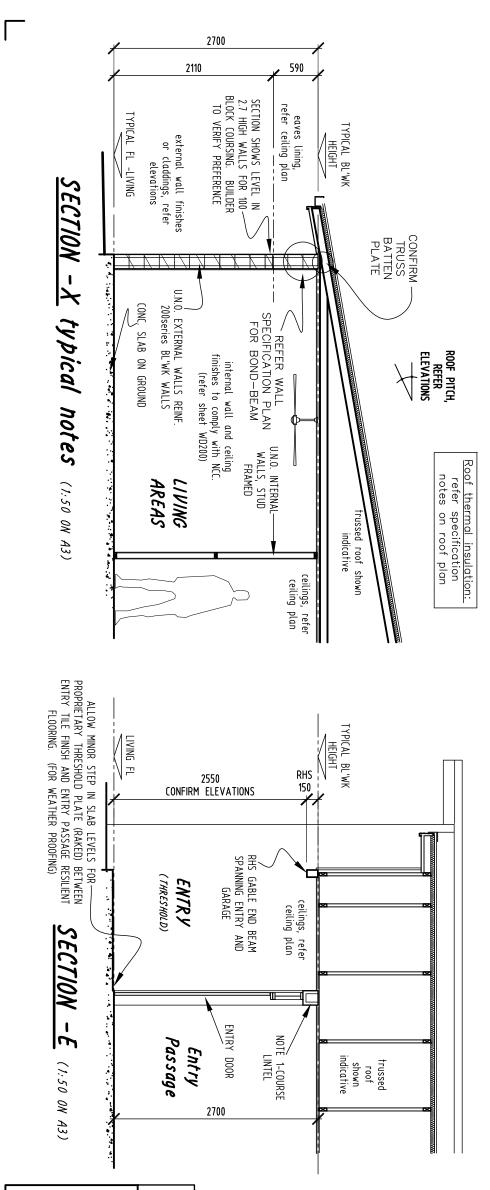

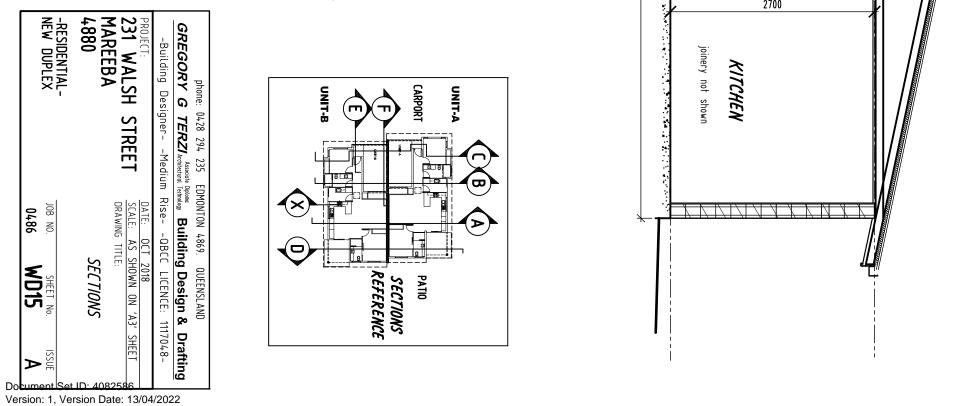


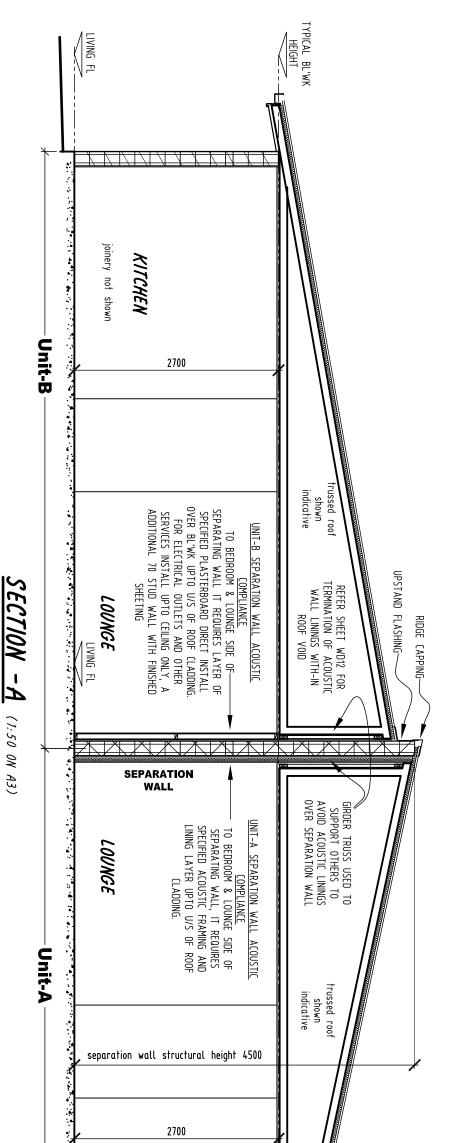

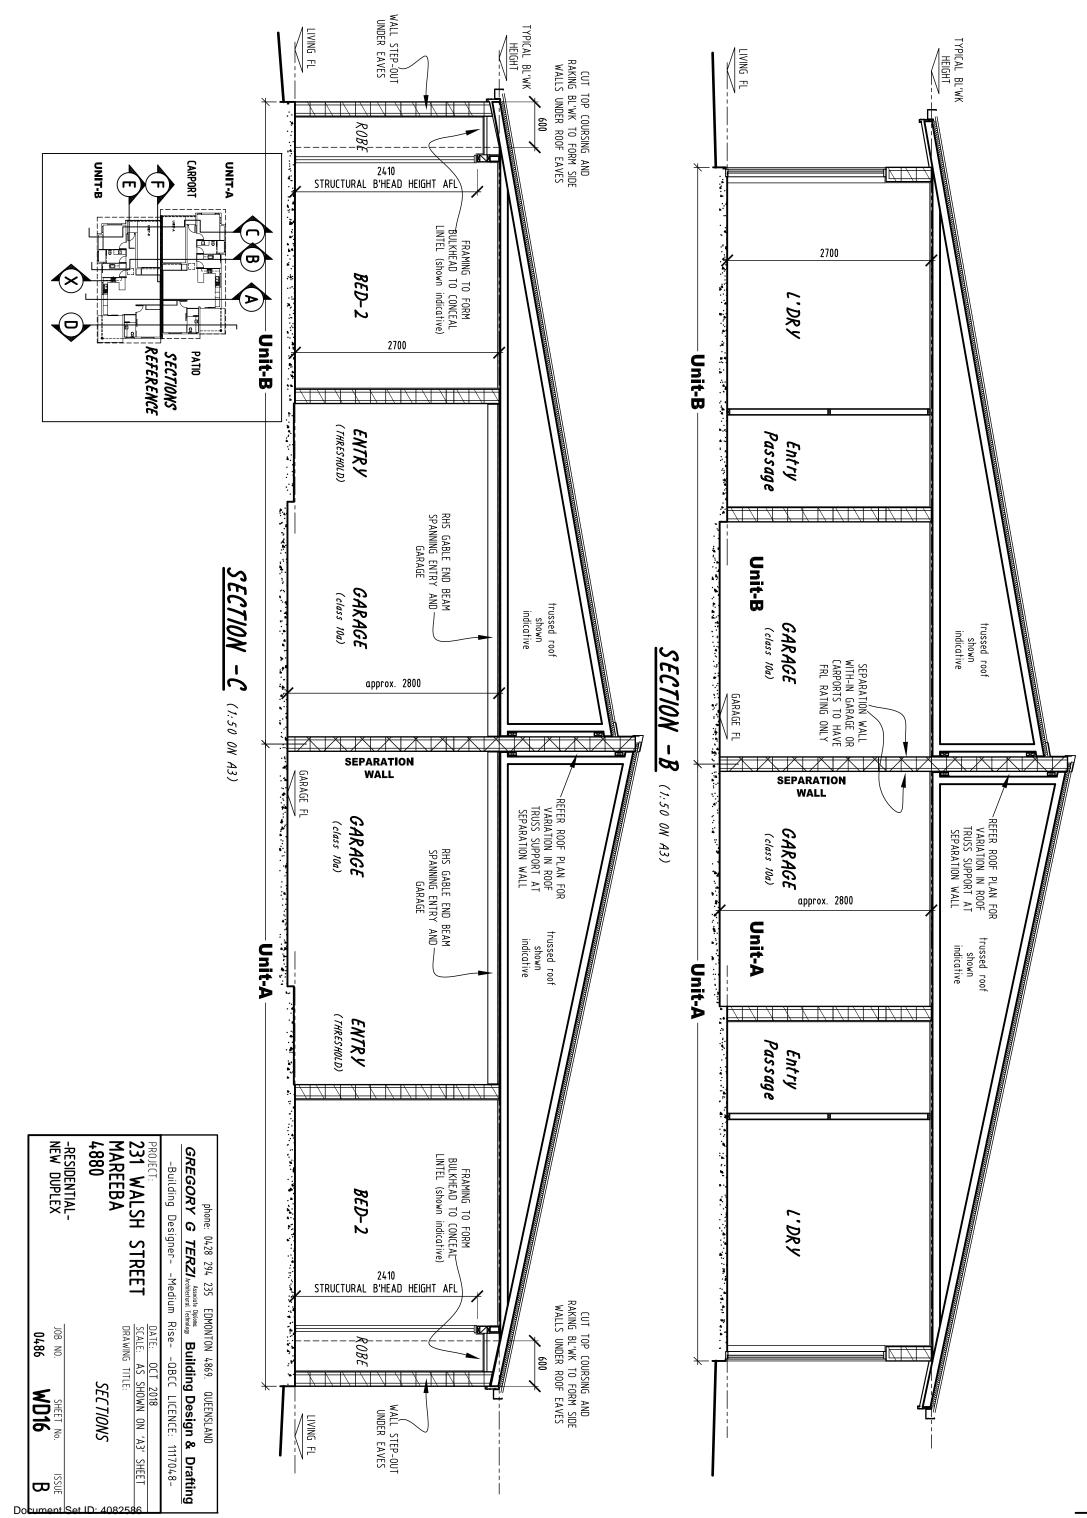


Version: 1, Version Date: 13/04/2022


 \square

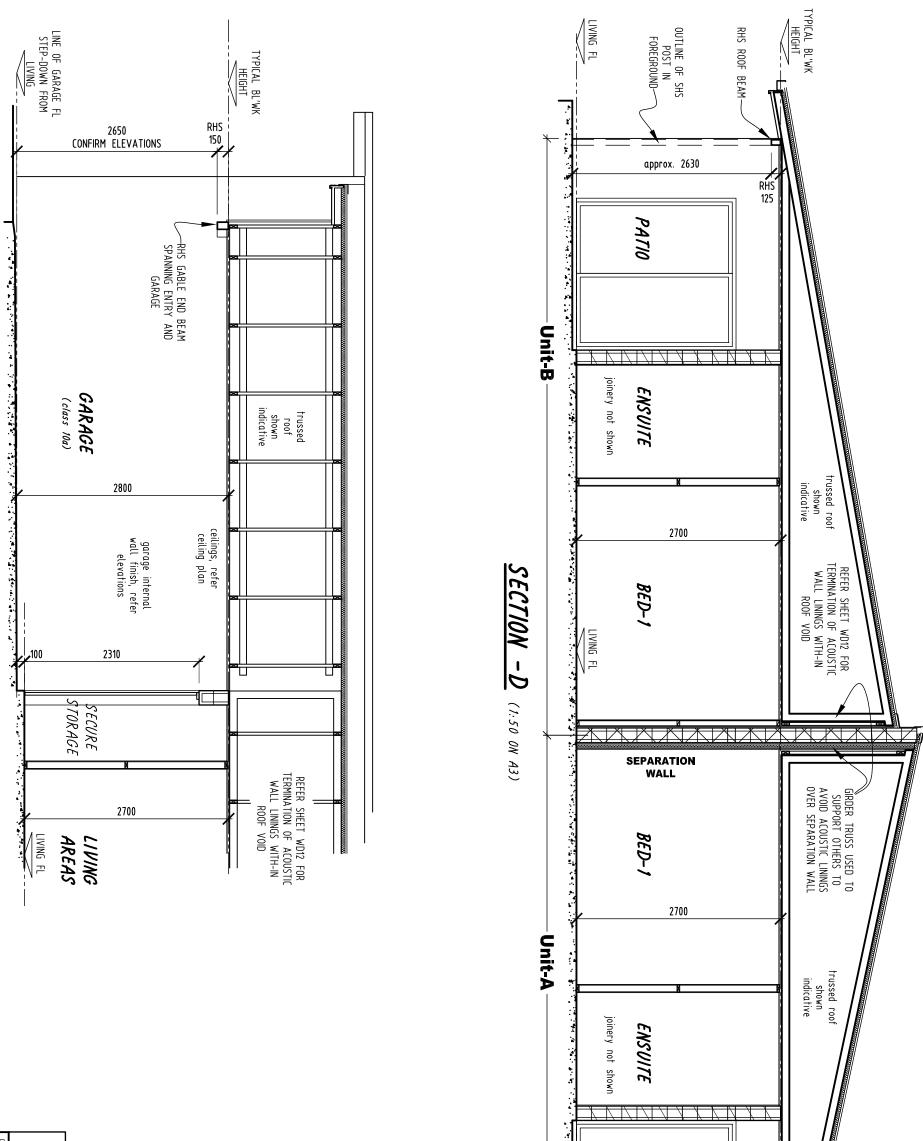


SECTION -F (1.50 ON A3)

 \square

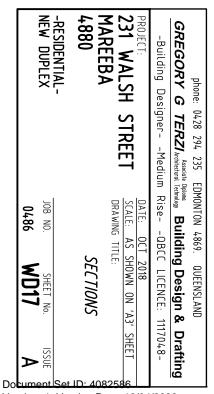


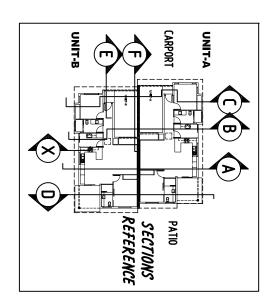

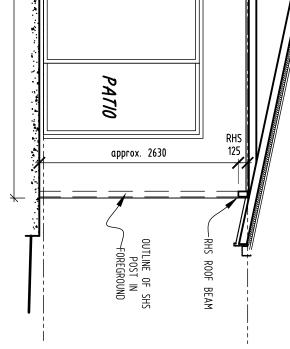

Version: 1, Version Date: 13/04/2022



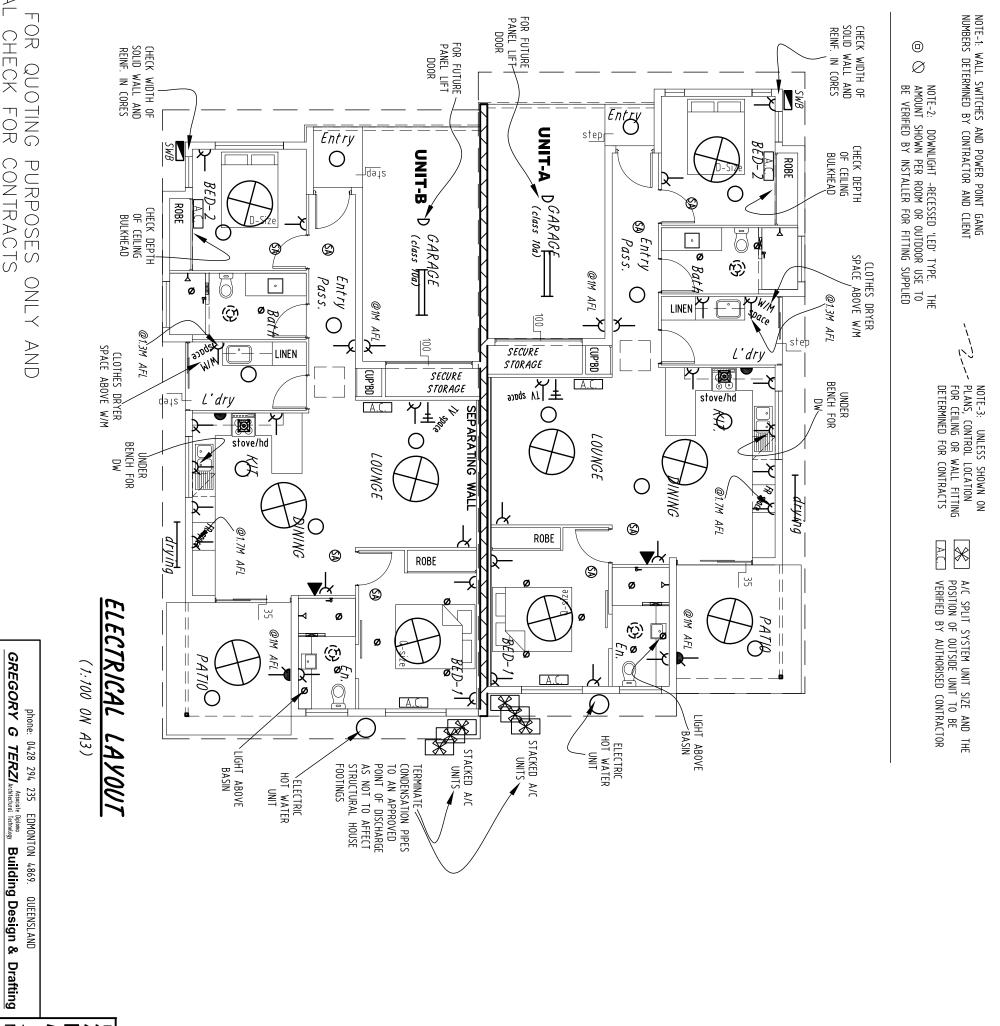



N -ヤメマリ

-Building Designer- -Medium Rise- -QBSA LICENCE: 1117048-


0486 WU ZU B	
IS	residential- Iew Duplex
STREET SCALE: AS SHOWN ON 'A3' SHEET DRAWING TITLE: ELECTRICAL LAYOUT	231 WALSH 1AREEBA 1880
: OCT 2018	ROJECT:
INDICATES RANGEHOOD	
INTERNAL CEILING MOUNTED EXTRACT FAN	
CELLING FAN. REFER FLOOR PLAN FOR SIZE	
P <u>endant</u> light. Light hung from Ceiling	
Θ <u>Specialty</u> light. Refer plan for use	
EXTERNAL SPOT LIGHT	
2 EXTERNAL WALL LIGHT	
EXTERNAL SELECTED CEILING LIGHT. UNLESS NOTED DIFFERENT ALLOW AS RECESSED DOWNLIGHT	
© <u>INTERNAL</u> CEILING MOUNTED LIGHT. (shown as circular fluorescent) © <u>INTERNAL</u> RECESSED DOWNLIGHT	
INTERNAL WALL MOUNTED FLUORESCENT OR LED	
I I SINGLE of DOUBLE 1200 Long BATTEN FLUORESCENT LIGHT. COVER FITTING TO SUIT EXTERNAL OR INTERNAL LOCATION	
♀ MOTION SENSOR	
Lighting & Ventilation Schedule:	
+ TV OUTLET	
Communications: typicat: POWERPOINTS @500 AFL UNLESS NOTED DIFFERENT OR ABOVE BENCH/VANITY TEI FPHONF POINT OR 'NBN' FONNETTION	
ightarrow ceiling power outlet for garage door	
COOKER OR OVEN POWER SOURCE	
→ DOUBLE POWERPOINT ► WEATHER PROOF	
Power Schedule: typical: POWERPOINTS @500 AFL UNLESS NOTED DIFFERENT OR ABOVE BENCH/VANITY — SINGLE POWERPOINT — WEATHER PROOF	
SMOKE ALARM -REFER MAIN FLOOR PLAN FOR DETAILS	
<u>Safety:</u>	

Version: 1, Version Date: 13/04/2022

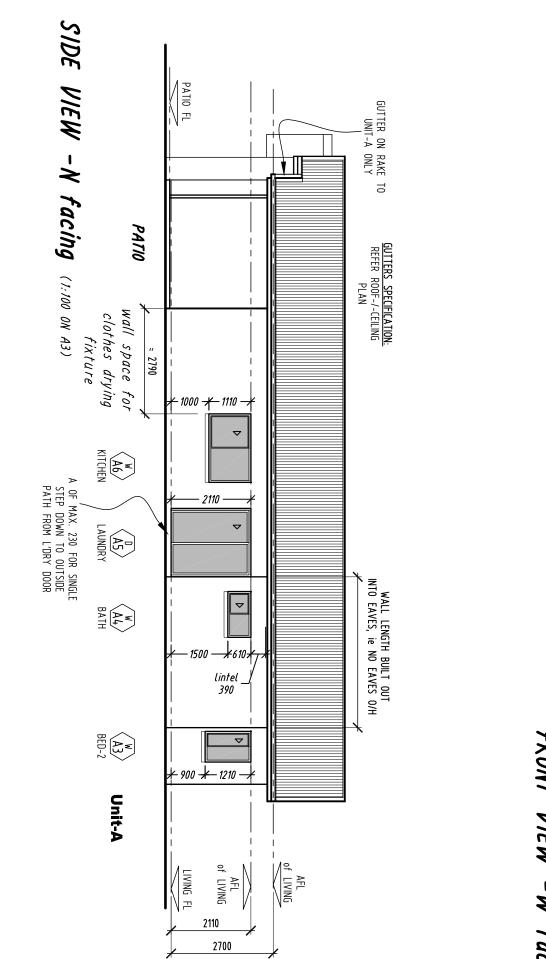

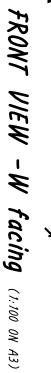

SLIDING PANEL

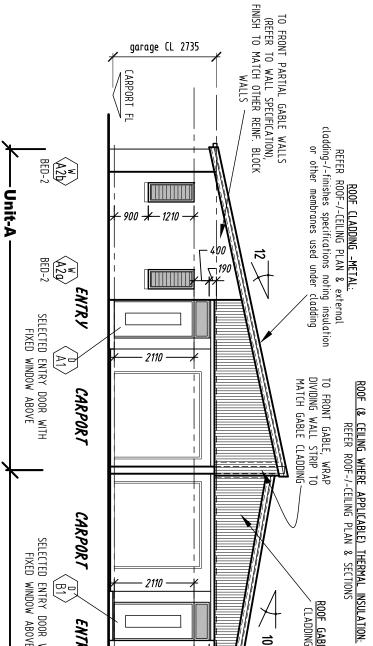


4880 -Residential- New Duplex	SH Desig	ENTRY M ABOVE Unit-B	
	.94 235 ZZ Architertwol	FED-2 →	— 1500 — ¥ 610 ¥
ELEVATIONS sheet JOB NO. SHE 0486 WD	FON 4.869. Buildin eQBC eQBC TE: OCT TE: OCT AVING TITL		of LIVING F
ions -external eet 1 of 2 Sheet No. IS WD 40	Design Notes" OR CERT. QUEENSLAND Design & Draft LICENCE: 1117048- 018 10WN 0N 'A3' SHEET	SITE WIND RATING: BEFED ENGINEERS "Churchings	V = □ 2110 2700
Document Set JD: 408 Version: 1, Version Da	SHEET 13/04/2022		

ROOF GABLE CLADDING: ALLOW CORRUGATED METAL SHEET CLADDING FIXED IN ACCORDANCE TO MANE. SPECIFICATION

门 10

REFER ROOF PLAN (or sections) FOR EAVES TREATMENT & WIDTH

of LIVING

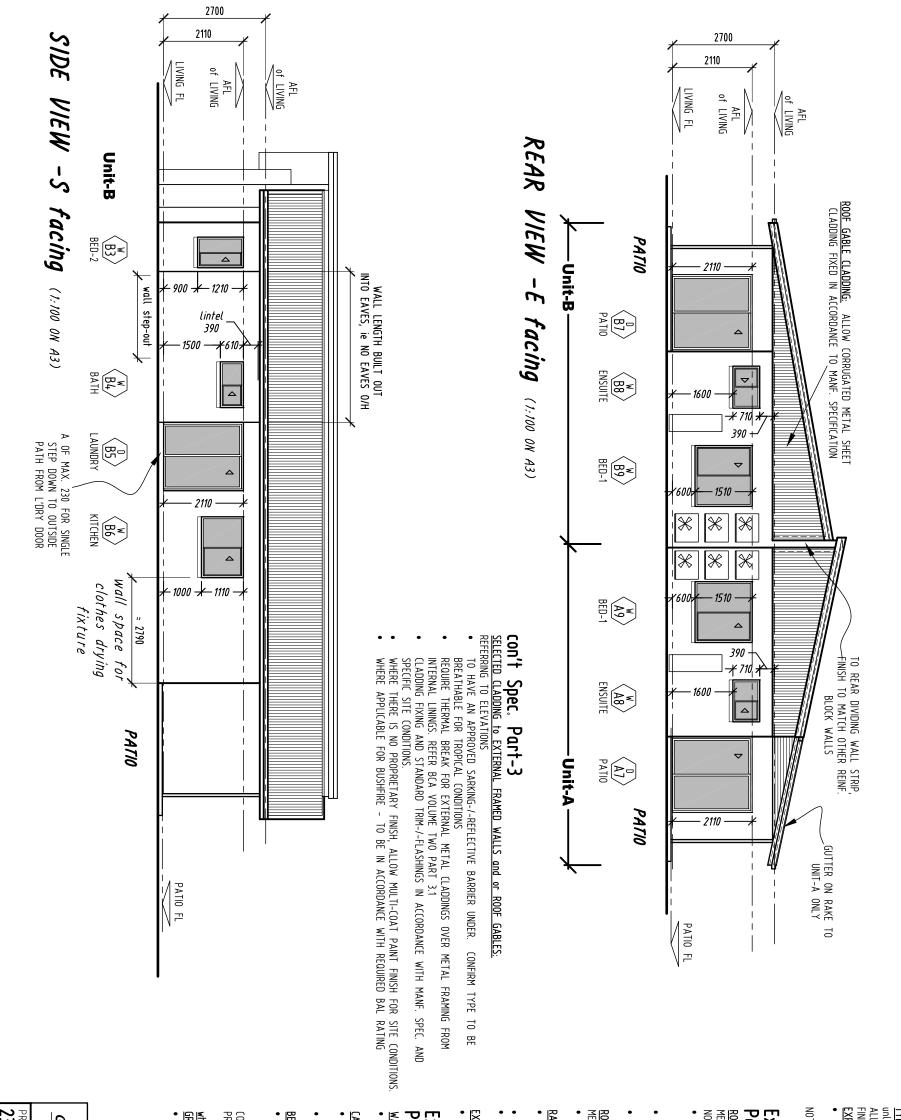

 $\nabla \nabla$

	-residential- New Duplex	4880		phone: 0428 294 235 EDV GREGORY G TERZI Accelerate Dipo -Building DesignerMedium		 where applicable -BLOCKWORK FACE ON GROUND BELOW FLOOR LEVEL: unless noted otherwise, CONTINUE VERIFY FOR TALL WALLS TO HAVE COATING AT FLOOR SLAB LEVEL. 	CONTINUATION OF TEXTURE OR RENDER PREVENTION SYSTEM ALLOWS.	BELOW WALLS CONCRETE SLAB FACE A SURFACES MAKE GOOD and PREPA FINISH SYSTEM OD	 CARPORT WALLS INTERNAL FACE OF REINF. BLOCKWORK UNLESS FOR CONTRACTS ITS AGREED FOR POINTED ALLOW A SELECTED PROPRIETARY EXTERIOR TEXTL MULTI-COAT PAINT FINISH. 	 WALLS EXTERNAL FACE OF REINF. BLO U.N.O., SELECTED PROPRIETARY EX MULTI-COAT PAINT FINISH. 	Exterior Claddings & I Part-3	DOWNPIPES- WHERE iUTTERS & FASCIA w rrietary 'colorbond' f FFIT <u>S AND EAVES</u> EILING PLAN or SECT	 TYPICAL PVC DOWNPIPES- APPLY SYSTEM 	'Base metal thickness' as require Metal colours in the proprietary	thickness' as require 's in the proprietary PPINGS	SHEET RUN LENGTHS, FIXINGS AND ACCORDANCE TO MANF. SPEC.		<u>ROOF (LADDING</u> METAL: REFER ELEVATIONS, ROOF PLAN, NOMINATEN PROFILE	Exterior Claddings & F Part-2	S NUMINA IEU ALLUW I HE HER EXPOSURE AND PREV IL GALVANISED MEMBERS	SH (eg colorbond, galvanised) <u>OSED POSTS AND BEAMS</u>	<u>NISHES</u> ed different, ALLOW MULTI- E ELEMENTS WHICH DO NOT
0486 WU 41	HEET No.	ELEVATIONS -EXTER	DATE: OCT 2018 SCALE: AS SHOWN ON 'A	10NTON 4869. QUEENSLAND Magy Building Design & RiseQBCC LICENCE: 11	SITE WIND RATING: REFER ENGINEERS "Structures Design Notes" OR CERT. STA	<u>N STRIP FOOTINGS OUT OF</u> TEXTURE OR RENDER COATINGS. VE HORIZONTAL JOINT IN	COATING WHERE TERMITE	F <mark>ACE ABOVE GROUND</mark> PREPARE FOR A MULTI-COAT PAINT	<u>EINF. BLOCKWORK</u> EED FOR POINTED BLOCKWORK, EXTERIOR TEXTURE COATING	<u>BLOCKWORK</u> Y EXTERIOR TEXTURE COATING WITH	Finishes: Spec.	APPLICABLE REFER ELEVATIONS /HERE APPLICABLE- Metal colours in inish IONS	MULTI-COAT PAINT FINISH	:d for site exposure rating. 'colorbond' finish	d for site exposure rating. 'colorbond' finish	AND PITCHING ANGLE TO BE IN	NDER SHEETING AND NOTING EMENT. <u>REFER ROOF THERMAL</u>	N, AND SECTIONS FOR	-inishes: Spec.	AILING WINDS AILING WINDS WARRANTY		COAT PAINT FINISH SYSTEM TO HAVE A PROPRIETARY COLOUR
Docum		2 1D: 4082586		2 Drafting	I <mark>NG:</mark> "Structures CERT. STAMP																	


Version: 1, Version Date: 13/04/2022

Spec.

80

Finishes:

Exterior Claddings Part-1

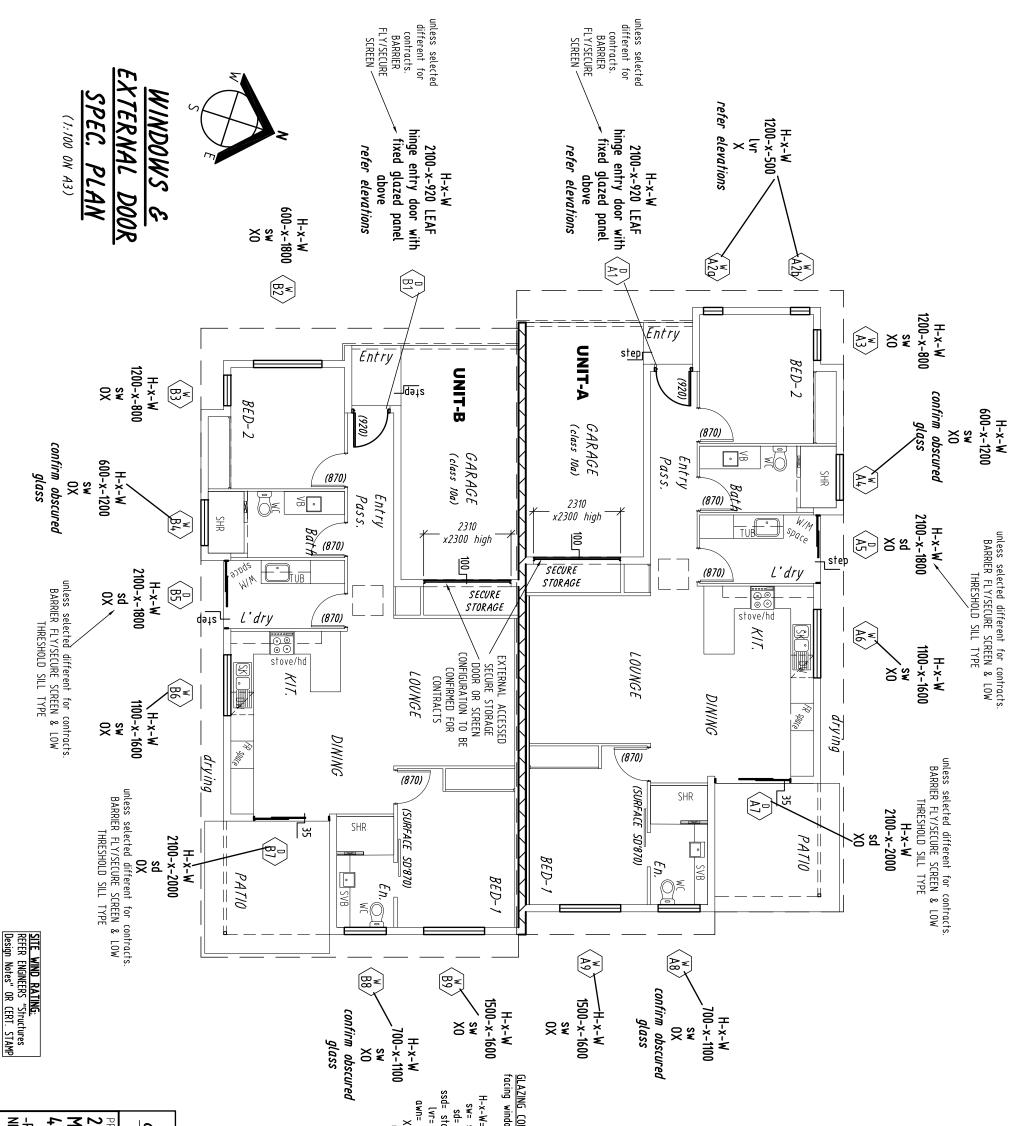

	IEW DUPLEX	RESIDENTIAL-	-880 1777		ROJECT: NAT WATCH CTREET	-Building Desi	GREGORY G	phone:	
					CIDEEL	gnerMedium	TERZI Architectural Tech	phone: 0428 294 235 EDMONTON 4869.	
	0486		WIND	DRAWING TITLE:	DATE: OCT 2018 SCALE: AS SHOW	RiseQBC	Magy Buildin	MONTON 4869.	
	WD 42		WINDOWS and EXTERNAL	.E:	DATE: OCT 2018 SCALE: AS SHOWN ON 'A3' SHEET	-Building DesignerMedium RiseQBCC LICENCE: 1117048-	GREGORY G TERZI Architectural Technology Building Design & Drafting	QUEENSLAND	
Do		t Set		3258	6		fting		

AND REQUIRE FINAL QUOTING PURPOSES CHECK FOR CONTRACTS TEMS LISTED FOR ONLY

<u>GLAZING CONFIGURATION LEGEND:</u> facing window/door from outside

H-x-W= height-x-width sw= sliding window sd= sliding door ssd= stacking slide door lvr= louvre suite awn= awning window X= opening 0= fixed

Version: 1, Version Date: 13/04/2022

Notes typical and inclusions for quote:

- Glazed assemblies (suite) in compliance to 'BCA' & referenced Aust.
 Standards
 FOR QUOTING PURPOSES unless noted otherwise, INCLUDE FLY SCREENING
 TO ALL EXTERNAL DOORS & WINDOWS. CONFIRM MESH MATERIAL
 FOR QUOTING PURPOSES unless noted otherwise, INCLUDE BARRIER SCREEN
 TO ALL SLIDING WINDOWS/SLIDING DOORS AND SINGLE HINGED DOORS BUT
 NOT INCLUDING FRONT ENTRY DOOR
 GLASS TINTING OR OBSCURED TEXTURES ARE TO HAVE FURTHER
 CONFIRMATION WITH CLIENT AND THE ENERGY EFFICIENCY CERTIFICATION
 REPORT. INCLUDE FOR BATHROOM (& ENSUITE) WINDOWS TO HAVE
 OBSCURED GLAZING.
 BUILDINGS REQUIRING A BUSHFIRE ATTACK LEVEL (BAL), ALL WINDOWS
 AND DOORS TO MEET Aust. STANDARD AS3959-2009


Drafting NEW	ON 4869. QUEENSLAND Building Design & D	1469. QUE		G TERZI Architectura	pho GREGORY	HS SHOWN, OR TO A FOUNDATION STRATA CAPABLE OF THE DEEPER. ALL EXCAVATIONS SHALL BE FREE FROM LOOSE A MIN OF 100 mm BELOW NATURAL GROUND LEVEL UNLESS AUGER OR OTHER APPROVED MEANS, SIDES OF HOLES SHALL MATERIAL. CONCRETE SHALL BE PLACED IN EACH HOLE WITHIN	 Foundation Excavations of the depths shown, or to a foundation strata capable of safely sustaining a bearing pressure of 100 kpg whichever is the deeper. All excavations shall be free from loose material, mud and water. Underside of all footings shall be a min of 100 mm below natural ground level unless shown otherwise. Excavations for bored piers shall be done by mechanical auger or other approved means, sides of holes shall be free from loose material, and sides and bottom shall be free from loose material. Concrete shall be placed in each hole within the shown otherwise.
					Structural Above Floor Line H.D. Holding down bolt BL'WK Blockwork S Snug tight Done conc concerte SL SL Conc concerte SL SL Stal Evvel Manip Manufacturer T/F tension friction Manip Manufacturer U.N.O. UNLESS NOTED OTHERWISE	CONSIST OF CLEARANCE OF VEGETATION FOLLOWED SIAL TO SUIT FINAL DESIGN LEVELS. DUITION OF ANY EXISTING BUILDINGS INCLUDING BREAKING VICE PIPES, SEPTIC TANKS ETC, AND EXISTING TREES REFRE WITH THE NEW CONSTRUCTION ANY SOL DISTURBED O ACHIEVE A DRY DENSITY RATIO OF NOT LESS THAN DENSITY (AS 1289 TESTS 5.3.1 & 5.5.1). SUBGRADE AL INSPECTION TO ALLOW DETECTION AND RECTIFICATION I MAY EXIST. D PAVEMENT AREAS SHALL BE UNIFORMLY COMPACTED IN CKNESS, UNDER LEVEL 3 SUPERVISION (AS 3798-1990 AND RESIDENTIAL DEVELOPMENTS) TO THE MAX DRY PLASTICITY GRANULAR MATERIAL WITH A PLASTICITY BASEMENT AREA SHOULD BE SUITABLE FOR REUSE AS D TO A SLOPE OF NOT STEEPER THAN 2h:IV. ALL EROSION ANY VIBRATORY ROLLING OR CONSTRUCTION ACTIVITIES) SETTLEMENT) TO ANY ADJACENT MOVEMENT-SENSITIVE	 New Works Site Preparity consist of clearance of vegetation: site preparity shall generally consist of clearance of vegetation followed by excavation of topsols and material to suit final design levels. provision shall be made for the demolition of any existing building simple and roots which may needed by demolition shall be recompared by the provision shall be recompared to the demolition of any full final design levels. In the proposed on one shall be informed by demolition of any fertilia and existing filling for any full be informed by demolition shall be recompared to any filling building the provided by demolition shall be unsometry compared to a day the construction. Any soll distribution of not less than seen of the maximum saturated unsheld to a day demolition of not less than seen of the maximum saturated unsheld by demolition and received to a different affects. In the proposed on the building the building to the building building to any filling plate to the second to a different affects. The exposed by demolition shall be unformed by demention to allow detection and rectification of not less than second by demention what be accompanied by demention to allow detection and rectification of any filling plate zones which may exist. Any filling plate accompanied by demention and estimation developmenty compacting by the building show and the building and set of the second by the maximum vibrated bensity established by the second by the building show and the building show and be demention of a supering of a different and by the maximum vibrate for received as the propering of any demention of a supering demention of a supering demention of any demention of a supering demention of any demention and set of a super of not steeper than 2h.th. All expressions on the propering demention and the plate by set of any demention of a super first and plate for the set of a super of not steeper than 2h.th. All expression filling shall be protected from errors and
Y AND BRICKWORK S A LAYER OF MORT. 1 WITH TWO LAYERS SURFACE AND THE	UNREINFORCED CONCRETE MASONRY AN SLABS AND BEAMS SHALL HAVE A L ON TOP AND TROWELLED SMOOTH WI BITUMENOUS FELT BETWEEN THIS SUR	ED CONCRE BEAMS SH ID TROWELL FELT BET	NREINFORC LABS AND N TOP AN ITUMENOUS	•	 GROUT MIX TO FILL CAVITY OR REINFORCED CONCRETE MASONRY WALLS TO HAVE A MINIMUM CHARACTERISTIC COMPRESSION STRENGTH OF 20 MPa(f'c). MAXIMUM SLUMP 250mm AND MAXIMUM AGGREGATE SIZE 10mm. 	 BUILDER TO ALLOW CLEAN OUT OPENINGS AT THE BASE COURSE OF ALL REINFORCED CONCRETE MASONRY WALLS AS INDICATED, AND ALL CORES TO BE RAKED CLEAN BEFORE FILLING WITH GROUT. 	 LOAD BEARING MASONRY: ALL LOAD BEARING MASONRY WORK SHALL BE EXECUTED IN ACCORDANCE WITH THE CURRENT EDITION OF AS 3700, EXCEPT WHERE VARIED BY THE CONTRACT DOCUMENTS.
V SI SI <t< td=""><td>NICE WITH THE SIZE CEMENT GATE TYPE D GP GATE TYPE B D GP GP GP GP C GP C GP C GP C GP C GP C</td><td>L BE IN ACCORDANCE WITH BOCUMENTS. DOCUMENTS. SLUMP MAX. SIZE CEN AGGREGATE T PUMPED PROJECT PROJECT VIBRATED. ATHAN THOSE SHOWN ON SHALL BE MADE IN THE PRIOR APPROVAL OF CONCRETE COVER TO E APPROVAL OF THE CONCRETE COVER TO E APPROVAL OF THE SE MADE ONLY WHERE SH NVED BY THE ENGINEER. SL ED FIRST AND INCLUDE SL</td><td>ALL BE IN A S 3600 AND CT DOCUMENT CT DOCUMENT DE DE S B0 DE S B0 S B0 CONCRETE CH COVER THAN T GS SHALL BE DUT THE APPROV COVER TO E COVER TO E COVER TO E IN OF 20mm. NATED FIRST NATED FIRST</td><td>1. ALL CONCRETE WORK SHALL BE IN ACCORDANCE WITH CURRENT EDITIONS OF AS 3600 AND AS 1379, EXCEPT VARIED BY THE CONTRACT DOCUMENTS. 2. CONCRETE QUALITY ELEMENT GRADE Ground Slab N25 Suspended Slabs N32 RETHOD OF PLACEMENT - PUMPED TYPE OF ASSESSMENT - PUMPED THE STRUCTURAL DRAWINGS SHALL BE MADE IN ON CONCRETE MEMBERS WITHOUT THE APPROVAL OF THE NO HOLES OR CHASES OTHER THAN THOSE SHOWN ON THE ENGINEER. THE CONCRETE COVER TO REINFORCEMENT WITHOUT THE APPROVAL OF THE ENGINEER. THE CONCRETE COVER TO EMBEDDED PIPES O CONSTRUCTION JOINTS SHALL BE A MIN OF 20mm. CONSTRUCTION JOINTS SHALL BE APPROVED BY THE ENGINEER. SH DRAWINGS OR WHERE APPROVED FIRST AND INCLUDE SLA THE CONSTRUCTION JOINTS SHALL BE MADE ONLY WHERE SH DRAWINGS OR</td><td> 6. UNLESS NOTED OTHERWISE ALL BOLTS SHALL 1. BE OF GRADE 4.6/S. 7. ALL DIMENSIONS SHALL BE CHECKED BY THE CONTRACTOR ON SITE PRIOR TO FABRICATION. 8. UNLESS STEEL PRE-FINISHED WITH PROPRIETERY GALV. (example Duragal) STEEL WORK IS TO BE SAND BLASTED (2.5) AND COATED WITH ZINC SLUCATE STEEL PRIMER (OR AS SPECIFIED) BEFORE ERECTION. STEELWORK ENCASED IN CONCRETE IS NOT TO BE PAINTED. 9. CONCRETE ENCASED STEEL WORK SHALL BE WRAPPED WITH W4. WIRE AT 200mm CENTRES AND SHALL HAVE A MIN OF 50mm COVER UNLESS NOTED OTHERWISE. 10. THE STEEL FABRICATOR SHALL PROVIDE ALL BOLTS NECESSARY FOR THE ERECTION OF THE STEELWORK AND BOLTHOLES AND CLEATS NECESSARY FOR THE ERECTION OF TIMBER WORK WHETHER OR NOT DETAILED IN THE DRAWINGS. 11. ALL LAPS, FIXINGS AND ACCESSORIES TO PURLINS AND GIRTS TO BE STRICTLY IN ACCORDANCE WITH THE MANUFACTURERS REQUIREMENTS. 6. BI </td><td> STRUCTURAL STEEL: ALL WORKMANSHIP AND MATERIALS SHALL BE IN ACCORDANCE WITH THE CURRENT EDITION OF AS 4100 AND AS 1554 EXCEPT WHERE VARIED BY THE CURRENT DOCUMENTS. UNLESS NOTED OTHERWISE ALL STEEL SHALL BE IN ACCORDANCE WITH: S 1204 GRADE 250 FOR R.H.S. SECTIONS AS 1163 GRADE 250 FOR R.H.S. SECTIONS AS 1163 GRADE 350 FOR C.H.S. SECTIONS AS 1163 GRADE 350 FOR ALL. SIGNAL STEEL UNLESS NOTED OTHERWISE ALL WELDS SHALL BE CATEGORY SP IN ACCORDANCE WITH CLAUSE 1:3:2 AS 1554-PART 1. UNLESS NOTED OTHERWISE ALL WELDS SHALL BE 6mm CONTINUOUS FILLET WELDS. HIGH STRENGTH FRICTION GRIP BOLTS, NUTS AND WASHERS (8:8/TF) SHALL COMPLY WITH THE RELEVANT REQUIREMENTS OF AS 12:52 AND SHALL BE TIGHTENED TO THE CORRECT TENSION USING APPROVED LOAD INDICATING WASHERS. CONTACT SUBFACES OF ALL HIGH STRENGTH FRICTION GRIP BOLTED CONNECTIONS SHALL BE LEFT UNPAINTED OR AS SPECIFIED. </td><td> DESIGN LOADS: C1 WIND CLASSIFICATION- THIS STRUCTURE HAS BEEN DESIGNED IN ACCORDANCE WITH THE FOLLOWING LOADING CODES- AS 1170.1 - DEAD & LIVE LOADS & LOAD COMBINATIONS. LIVE LOADS - GENERAL AREA 1.5kPA. VERANDAHS & BALCONIES 3.0kPA. MIND LOADING FOR WINDOWS and DOORS- REFER MANE. SPECIFICATIONS TIMBER: 1. ALL WORK SHALL COMPLY WITH THE RELEVANT BUILDING ACT AND ALL CODES REFERED TO THEREIN. 2. ALL STRUCTURAL TIMBER SHALL BE GRADE F14. UNSEASONED, UNLESS NOTED OTHERWISE. 3. THE DESIGN, ERECTION AND BRACING OF PREFABRICATED ROOF TRUSSES SHALL BE IN ACCORDANCE WITH THE MANUFACTURERS REQUIREMENTS. UNLESS NOTED OTHERWISE. 4. ALL FRAMING AND CONNECTION DETAILS SHALL BE IN ACCORDANCE WITH AS1684.3 RESIDENTIAL TIMBER - FRAMED CONSTRUCTION - CYCLONIC. </td></t<>	NICE WITH THE SIZE CEMENT GATE TYPE D GP GATE TYPE B D GP GP GP GP C GP C GP C GP C GP C GP C	L BE IN ACCORDANCE WITH BOCUMENTS. DOCUMENTS. SLUMP MAX. SIZE CEN AGGREGATE T PUMPED PROJECT PROJECT VIBRATED. ATHAN THOSE SHOWN ON SHALL BE MADE IN THE PRIOR APPROVAL OF CONCRETE COVER TO E APPROVAL OF THE CONCRETE COVER TO E APPROVAL OF THE SE MADE ONLY WHERE SH NVED BY THE ENGINEER. SL ED FIRST AND INCLUDE SL	ALL BE IN A S 3600 AND CT DOCUMENT CT DOCUMENT DE DE S B0 DE S B0 S B0 CONCRETE CH COVER THAN T GS SHALL BE DUT THE APPROV COVER TO E COVER TO E COVER TO E IN OF 20mm. NATED FIRST NATED FIRST	1. ALL CONCRETE WORK SHALL BE IN ACCORDANCE WITH CURRENT EDITIONS OF AS 3600 AND AS 1379, EXCEPT VARIED BY THE CONTRACT DOCUMENTS. 2. CONCRETE QUALITY ELEMENT GRADE Ground Slab N25 Suspended Slabs N32 RETHOD OF PLACEMENT - PUMPED TYPE OF ASSESSMENT - PUMPED THE STRUCTURAL DRAWINGS SHALL BE MADE IN ON CONCRETE MEMBERS WITHOUT THE APPROVAL OF THE NO HOLES OR CHASES OTHER THAN THOSE SHOWN ON THE ENGINEER. THE CONCRETE COVER TO REINFORCEMENT WITHOUT THE APPROVAL OF THE ENGINEER. THE CONCRETE COVER TO EMBEDDED PIPES O CONSTRUCTION JOINTS SHALL BE A MIN OF 20mm. CONSTRUCTION JOINTS SHALL BE APPROVED BY THE ENGINEER. SH DRAWINGS OR WHERE APPROVED FIRST AND INCLUDE SLA THE CONSTRUCTION JOINTS SHALL BE MADE ONLY WHERE SH DRAWINGS OR	 6. UNLESS NOTED OTHERWISE ALL BOLTS SHALL 1. BE OF GRADE 4.6/S. 7. ALL DIMENSIONS SHALL BE CHECKED BY THE CONTRACTOR ON SITE PRIOR TO FABRICATION. 8. UNLESS STEEL PRE-FINISHED WITH PROPRIETERY GALV. (example Duragal) STEEL WORK IS TO BE SAND BLASTED (2.5) AND COATED WITH ZINC SLUCATE STEEL PRIMER (OR AS SPECIFIED) BEFORE ERECTION. STEELWORK ENCASED IN CONCRETE IS NOT TO BE PAINTED. 9. CONCRETE ENCASED STEEL WORK SHALL BE WRAPPED WITH W4. WIRE AT 200mm CENTRES AND SHALL HAVE A MIN OF 50mm COVER UNLESS NOTED OTHERWISE. 10. THE STEEL FABRICATOR SHALL PROVIDE ALL BOLTS NECESSARY FOR THE ERECTION OF THE STEELWORK AND BOLTHOLES AND CLEATS NECESSARY FOR THE ERECTION OF TIMBER WORK WHETHER OR NOT DETAILED IN THE DRAWINGS. 11. ALL LAPS, FIXINGS AND ACCESSORIES TO PURLINS AND GIRTS TO BE STRICTLY IN ACCORDANCE WITH THE MANUFACTURERS REQUIREMENTS. 6. BI 	 STRUCTURAL STEEL: ALL WORKMANSHIP AND MATERIALS SHALL BE IN ACCORDANCE WITH THE CURRENT EDITION OF AS 4100 AND AS 1554 EXCEPT WHERE VARIED BY THE CURRENT DOCUMENTS. UNLESS NOTED OTHERWISE ALL STEEL SHALL BE IN ACCORDANCE WITH: S 1204 GRADE 250 FOR R.H.S. SECTIONS AS 1163 GRADE 250 FOR R.H.S. SECTIONS AS 1163 GRADE 350 FOR C.H.S. SECTIONS AS 1163 GRADE 350 FOR ALL. SIGNAL STEEL UNLESS NOTED OTHERWISE ALL WELDS SHALL BE CATEGORY SP IN ACCORDANCE WITH CLAUSE 1:3:2 AS 1554-PART 1. UNLESS NOTED OTHERWISE ALL WELDS SHALL BE 6mm CONTINUOUS FILLET WELDS. HIGH STRENGTH FRICTION GRIP BOLTS, NUTS AND WASHERS (8:8/TF) SHALL COMPLY WITH THE RELEVANT REQUIREMENTS OF AS 12:52 AND SHALL BE TIGHTENED TO THE CORRECT TENSION USING APPROVED LOAD INDICATING WASHERS. CONTACT SUBFACES OF ALL HIGH STRENGTH FRICTION GRIP BOLTED CONNECTIONS SHALL BE LEFT UNPAINTED OR AS SPECIFIED. 	 DESIGN LOADS: C1 WIND CLASSIFICATION- THIS STRUCTURE HAS BEEN DESIGNED IN ACCORDANCE WITH THE FOLLOWING LOADING CODES- AS 1170.1 - DEAD & LIVE LOADS & LOAD COMBINATIONS. LIVE LOADS - GENERAL AREA 1.5kPA. VERANDAHS & BALCONIES 3.0kPA. MIND LOADING FOR WINDOWS and DOORS- REFER MANE. SPECIFICATIONS TIMBER: 1. ALL WORK SHALL COMPLY WITH THE RELEVANT BUILDING ACT AND ALL CODES REFERED TO THEREIN. 2. ALL STRUCTURAL TIMBER SHALL BE GRADE F14. UNSEASONED, UNLESS NOTED OTHERWISE. 3. THE DESIGN, ERECTION AND BRACING OF PREFABRICATED ROOF TRUSSES SHALL BE IN ACCORDANCE WITH THE MANUFACTURERS REQUIREMENTS. UNLESS NOTED OTHERWISE. 4. ALL FRAMING AND CONNECTION DETAILS SHALL BE IN ACCORDANCE WITH AS1684.3 RESIDENTIAL TIMBER - FRAMED CONSTRUCTION - CYCLONIC.

-RESIDENTIAL- NEW DUPLEX	PROJECT: 231 WAL MAREEBA 4880	=														WORK SUPPORTING MORTAR PLACED LAYERS OF D THE CONCRETE.	3. WELDING O SHOWN ON		≤ ⊓	≺ z	2. ALL REINF 1302, AS	I. BUILDER TO BASEPLATES	COHESIONLES COHESIVE SC COMPACTION.). FLOOR SL ALL TOP IS TO BE MATERIAI	. ALL FORM SHALL REI CONCRETE REMAIN UN	. ALL CONCRETE FOR SEVEN DA	. UNDERPINNING APPROVED B 15MPa.
EX	LSH STREET	N24 1150	N16 750	LAP L	UNLESS SHOWN MINIMUM LAP LE	REO E	SLAB ON GROUND	COLUMNS	BEAMS	SUSPENDED SLABS	STAIRS	BORED PIERS	PILECAPS, PAD & STRIP FOOTINGS	ELEMENT	REINFORCEMENT COVER	TING • MORTAR (CED • MINIMIUM I TE. STRENGTH	OF THE REINFORCEMENT DN THE DRAWINGS.	SHALL BE SUPPLIED	WELDED WIRE FABRIC	DEFORMED BARS HOT ROLLED DEFORMED	ND SH	PROVIDE MORTAR AS SPECIFIED.	.ess soils - minimum e soils - (max p.i. = on.	FLOOR SLABS ON GROUND : ALL TOP SOLL AND UPPER STRATA C IS TO BE REMOVED AND REPLACED B MATERIAL COMPACTED AS FOLLOWS	FORMWORK AND PROPPING TO SUSPENDED SLABS AND BE LL REMAIN IN POSITION FOR 14 DAYS AFTER PLACING IRETE UNLESS SPECIFIED OTHERWISE. SUCH FLOOR SHALL AIN UNLOADED FOR 28 DAYS.	RETE SURFACES SHALL IN DAYS IMMEDIATELY 1	UNG WHERE NOT SHOWN D BY THE ENGINEER. FOR
JOB NO.	DATE OCT 20 SCALE AS SHO DRAWING TITLE "Structural Rating			ENGTH BAR	LENGTHS SHALL BE		40	40	40	40	40	75	65	REINF'T COVER (mm)	EXPOSED TO WEATHER	R CLASSIFICATION- IM CHARACTERISTIC 3TH OF MASONRY I	SHALL NOT BE		ND DEEORMED	BARS	Y WITH THE CURRENT	UNDER STEEL COLUMNS,	TY INDEX =	ONTAINING Y AN APP	0 SUSPENDED SL 14 DAYS AFTER ERWISE. SUCH FLC	BE CURED BY AN THE CONCRETE IS S	ON DRAWINGS UNDERPINNING
	DET 2018 AS SHOWN ON 'A3' SHEET TITLE: Ctural notes" & Wind		1600 1900	LAF	AS FOLLOWS:	LENGTHS	20	40	40	20	20	75	65	REINF'T COVER (mm)	NOT EXPOSED TO WEATHER	I- M4. IC UNCONFINED COMPRESSION VUNITS SHALL BE 15MPa.	PERMITTED UNLESS		GRADE 450F	GRADE 500 GRADE 400Y	ED THUS :	MNS,	: 85% STANDARD	ORGANIC MATTER ROVED FILLING	ABS AND BEAMS PLACING DOR SHALL	N APPROVED METHOD SET.	MUST BE ONLY, f'c =
Document Set	LID: 4082586	/0000																									

Version: 1, Version Date: 13/04/2022

-Building Designer- -Medium Rise- -QBCC LICENCE: 1117048-

 \square

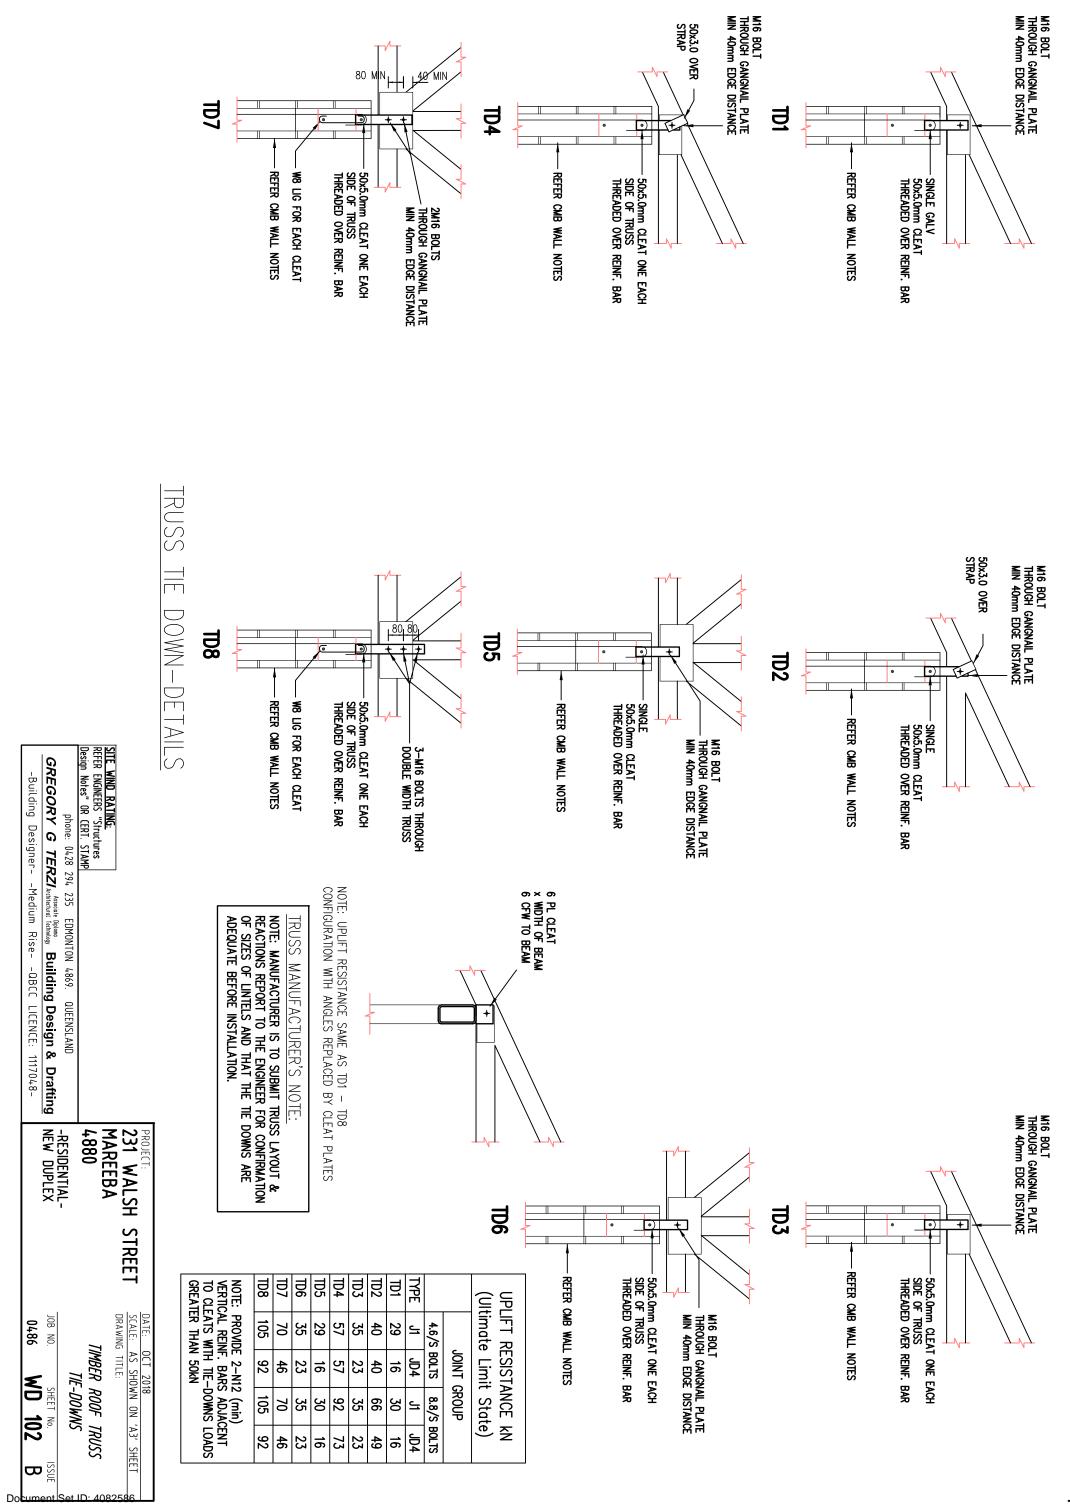

Version: 1, Version Date: 13/04/2022

SITE WIND CLASSIFICATION -C1	 WORK, HEALTH, and SAFETY PORSIGNERS SAFETY REPORT EXTRACT FROM 'WHS regulation 2011' - "The designer of a structure or any part of a structure that is to be constructed must give the person conducting a business or undertaking who commissioned the design of the structure that, so far as the designer is reasonably aware." Where the report can identify high risk construction work and other activities with a possible risk, it is understood for all general and specialised activity which may not be mentioned need to compty with 'Workplace Health and Safety Queensland' CODE OF PRACTICE publication, WHS Act, WHS Regulation and the contractors own trade standards. REPORT READ IN CONJUNCTION WITH DRAWINGS & DOCUMENTS AT INC OF ISSUE DRAWINGS LISTED ON TITLE SHEET WD00 SITE SPECIFIC REPORT EXCLUSION • EXTERNAL HARDSCAPF, BUILDING PAD, DRIVEWAYS, PATHS, FENCING, AND RETAINING WALLS, STORM WATER. 	 AKCHILCLOKAL DESIGN NOLES Verify all dimensions and levels on site before commencing any works or preparation of fabricators shop drawings. Take figured dimensions in preference to scaled. All discrepancies shall be refered to the author before proceeding of works. <i>ANY CONSTRUCTION TO VARY FROM PROJECT DOCUMENTATION PACKAGE, IS TO BE APPROVED BY ITS DESIGN AUTHOR or F BEING A STRUCTURAL ELEVENT.</i> <i>THE ENGINEE</i> NATIONAL CONCTRUCTION CODE (BUILDING CODE OF AUST.) WORKS TO COMPLY WITH CURRENT 'NCC' OR THE YEAR ISSUE BUILDING APPROVAL WAS GIVEN. <u>TERMITE PROTECTION TO MEET CURRENT 'NCC' OR THE YEAR ISSUE BUILDING APPROVAL WAS GIVEN.</u> <u>TERMITE PROTECTION TO MEET CURRENT 'BCA', METHODS BEST USED IN LOCAL AREA ACCEPTED BY AUTHORISED BUILDING CERTIFIER, AND INCORPORATES ANY TERMITE CONTROL NOTES ON DRAWINGS. Durable notices within building to state protection type and date</u> <u>SUSTAINABLE BUILDINGS NOTES -electrical & plumbing</u> to then applicable to subject regional council area). MATERALS & PROPRIETARY ITEMS (ie. tradename products) ALL PRODUCTS AND MATERRIALS USED AND INSTALLED IN ACCORDANCE TO MANF. SPEC. <u>FURNITURE AND VEHICLES WHERE SHOWN.</u> FURNITURE AND VEHICLES WHERE SHOWN. MO OR TO LOCATE ELECTRICAL FITTINGS, etc, etc 	
 <u>Confined Space</u> NIL WORKS CARRIED OUT IN OR NEAR WATER THAT INVOLVES RISK OF DROWNING 	 FOR DOCUMENTED WORKS OR STRUCTURE AS IDENTIFIED "HIGH RISK CONSTRUCTION WORK" I. DEMOLITION: NIL NIL ASBESTOS: NIL ASBESTOS: NIL EARTHWORKS: Includes work carried out in or near a shaft or trench with excavated depth includes work carried out in or near a shaft or trench with excavated depth includes work carried out in or near a shaft or trench with excavated depth includes work carried out in or near a shaft or trench with excavated depth NIL EARTHWORKS: Includes work carried out in or near a shaft or trench with excavated depth includes work carried out in or near a shaft or trench with excavated depth NIL EARTHWORKS: Includes work carried out in or near a shaft or trench with excavated depth includes work carried out in or near a shaft or trench with excavated depth NIL EARTHWORKS: Includes work carried out in or near a shaft or trench with excavated depth NIL EARTHORKING AT HEIGHTS or repairs that require temp. support WIL STRUCTURAL alterations or repairs that require temp. support NIL STRUCTURAL alterations or repairs that require temp. support NIL STRUCTURAL alterations or repairs that require temp. support NIL STRUCTURAL alterations or near heights above AND OR BUILDING FLOOR LEVEL. Specific to site notes: A New slab on ground, suspended stabs or framed floors with taid platforms to reach heights internatly. B. Ground line majority with-in close proximity to building footprint considered level after the forming earth platform for slab on ground. Check stability for us as hard base to set-up approved level working platforms to reach heights externally. C. With various roof edge heights above 2M and above 3M from surface below error to power and to and to minimise the risk of falling. Where construction requires working a proved barriers, full arrest systems, and level working approv	INTERNAL WALL, FLOOR & CELLINGS: ELU 1. SELECTED SUBSTRATES AND FINAL FINISHES TO SATISFY CURRENT 'BCA' IN REGARDS TO THE STRUCTURES CLASSIFICATION • 2. SEAL TO MINIMSE AIR LEAKAGE FORMING THE EXTERNAL FABRIC OF A CONDITIONED SPACE. • 3. UNOWET AREAS AND SELECTED SPLASHBACKS TO WATER VESSELS TO COMPLY WITH CURRENT BCA' FOR WATER-PROOF OR WATER RESISTANT. AIR NOTE: unless noted otherwise, verify bench or water vessel splashback extent noterial and location use exposure AIR STRUCTURES CLASS 1 -SMOKE ALARM: ALARMS IN ACCORDANCE WITH NCC AND Aust. Standards. • • HINGED DOORS TO HAVE LIFT-OFF HINGES WHERE INWARD SWING WILL NOT HAVE THE SPECIFIED CLEARANCE WITH TOLET PAN. REFER TO CURRENT 'BCA' FOR MEASURE. • • MATER TO CURRENT 'BCA' FOR MEASURE. • • • HARE TO CURRENT 'BCA' FOR MEASURE. • • • FER TO CURRENT 'BCA' FOR MEASURE. • • • FER TO CURRENT 'BCA' FOR MEASURE. • • • FER TO CURRENT 'BCA' FOR MEASURE. • • • TO CURRENT 'BCA' FOR MEASURE. • • • FER TO CURRENT 'BCA' FOR MEASURE. • • • FER TO CURRENT 'BCA' FOR MEASURE. • • • FER TO CURRENT 'BCA' FOR MEASURE. • • • FER TO CURRENT 'BCA	

FUTURE MAINTENANCE:
 MATERIALS and PROPRIETARY PRODUCTS -FOLLOW GUIDELINES AND LITERATURE NOTED OR AS FURTHER REFERENCED BY THE MANUFACTURER or SUPPLIER. INCLUDES GALVANISING OR OTHER PROPRIETARY PROTECTION COATINGS TO PRODUCTS.

AIR CONDITIONING:

TERMINATE A/C CONDENSATION PIPES TO AN APPROVED POINT OF DISCHARGE AND CLEAR FROM FOOTINGS. BUILDING CERTIFIER TO VERIFY

- ENERGY EFFICIENCY ASSESSMENT for CLASS 1.
 AN ASSESSMENT AND CERTIFICATION Form15 REQUIRED FOR BUILDING APPLICATION WHERE A CLASS 1 STRUCTURE ARE THE FOLLOWING;
 NEW DWELLINGS
 AN EXTENSION (incl. alterations) IS APPROX. 50% THE SIZE OF EXISTING HABITABLE AREAS AND LINKED BY INTERNAL OPENINGS, AN ASSESSMENT FOR BOTH EXISTING AND NEW TOGETHER IS REQUIRED.
 A SEPARATE ADDITION IS APPROX. 50% THE SIZE OF EXISTING HABITABLE AREAS

NOTE LEVEL OF ASSESSMENT REQUIRED FOR ALL EXTENSIONS OR ADDITIONS TO BE CONFIRMED BY BUILDING CERTIFIER

FOR DOCUMENTED WORKS OR STRUCTURE AS IDENTIFIED "LOW RISK CONSTRUCTION WORK"

- EARTHWORKS: EXCAVATION FOR PLUMBING, DRAINAGE PIPE RUNS & OR PIER FOOTINGS

Note where holes or trench are greater than 1.5m in depth, these areas shall be upgraded to "High Risk Construction Work". Approved safety action by builders to be enforced.

٠ Ĩ **JOLVES RISK OF DROWNING**

5 & OR PIER n depth, the Work".	IDENTIFIED	NCC	DP ADP ADP ADP ADP ADP ADP ADP ADP ADP A		BN B'DRY ChestFZ	AFFL BAL BR'WK BR'WK	GENERAL AFL ABO
					Ň		
PIER these	FED	'National Cons	DownPipe (DownPipe S Damp Proo Dishwashef			ABOVE FINI BALUSTRADI BLOCKWORK BRICKWORK,	'≓
		struction Code	rainwater) SPREADER F MEMBRANE MACHINE spc	SITE	ZER space	SHED FLOOR L E clay	ABBREVIATION
 PL Work s demolifi warning accorda accorda prevent prevent brevent where loose n not sup Sup 	Typica	' series	1Ce	NFO H/W	ie z R		_ Ž
PUBLIC ACCESS sites with public acr liftion or under generc liftion or under generc rdance to 'WHS reguld rdance to 'WHS reguld rdance to 'WHS reguld re electrical installati e materials are prese e materials are prese e materials are prese EXISTING SERVICES DE OVERHEAD, OR WITH-1	5 - -	BCA 'Building Code Of	nii chen Laundry Manufacturer Microwave space Not included in		FRIDGE UPRIGHT s FREEZER UPRIGHT GROUND LINE		
ess being of cons l maintenance will s suited for site tions'. Secure bo access will be sit access will be sit access will be secure ontractor NG UNDERGROUND. N BUILDINGS		AS	ACT			EQUIPMENT	SHEET
struction, specific in arriers to plant or ured when		ustralian Standard'	VANITY BASIN WATER CLOSET WASHING MACHINE	STRUCTURAL SI TO BE CONFIRM UNLESS NOTED	PAINT SHOWER SINK	OVERALL OVERHANG or OVEN PLASTERBOARE	NOT TO SCALE
on-cita for all avicting carvirac prior	 <u>PUBLL</u> ALLESS <u>Work sites</u> with public access being of const demolition or under general maintenance will warning signs and barriers suited for site s accordance to 'WHS regulations'. Secure bar prevent any unauthorised access will be site Where electrical installations, excavations, p loose materials are present, should be secun not supervised by leading contractor <u>EXISTING SERVICES BEING UNDERGROUND</u>. 		al Construction Code	NPPE (rainwater) L'DRY LANNDRY VB NPPE (rainwater) MANE: M	RETE HC HOT NATER UNIT T.B.C. TO RE CORREND WERE Connoteents VERPE KIT KITCHAN U.N.O. ULSS. TO RE CORREND UNDESSING VALUES NOTED OT UNDESSING VALUES VALUE	Guar FZ FREEZR UNE UNE HIGH space SIR SINK BETE HW HOTVATER WITVATER SIX SIX SIX BETE HW HOTVATER WITVATER SIX SIX SIX BETE HW HOTVATER WITVATER SIX SIX SIX BETE HW HOTVATER WIT T.E. TO BE COMPRIME VERP FINAL HAN MANE MANE MANE WIT UNO UNO <td< td=""><td>EYERANDED FLOOR LIVE EXET EXERTING FIRE CIENT EVENT O/A OVERIANG or I VMOOR, (Loy NG LIVER, space FI FLORE (LIVER) EUUPRENT space FI EVENT EVENT</td></td<>	EYERANDED FLOOR LIVE EXET EXERTING FIRE CIENT EVENT O/A OVERIANG or I VMOOR, (Loy NG LIVER, space FI FLORE (LIVER) EUUPRENT space FI EVENT EVENT