

# **GOOGLE MAPPING AERIAL VIEW**

# PROPERTY DESCRIPTION


LOT: 299SP250068 SUBURB: MAREEBA LOCALITY: MAREEBA LOCAL AUTHORITY: MAREEBA REGIONAL COUNCIL ZONING: RURAL RESIDENTIAL

AREA OF LOT - 4652m<sup>2</sup> AREA OF RESIDENCE - 253.0m<sup>2</sup> SITE COVERAGE - 5.44%

AREA OF DRIVEWAY - 340m<sup>2</sup>

# **LEGEND**

HYDRANT H W WATER CONNECTION **ELECTRICAL TURRET** TELSTRA PIT MAN HOLE o DP 100mm DOWN PIPE ⊗PP POWER POLE STREET LIGHT  $-\otimes$ ----- SEWER LINE **CONTOUR LINE** — — — EXISTING RETAINING — - — NEW RETAINING ----- STORM WATER LINE ---- FENCE — — — ELECTRICAL — - — — - — TELSTRA COMMUNICATIONS

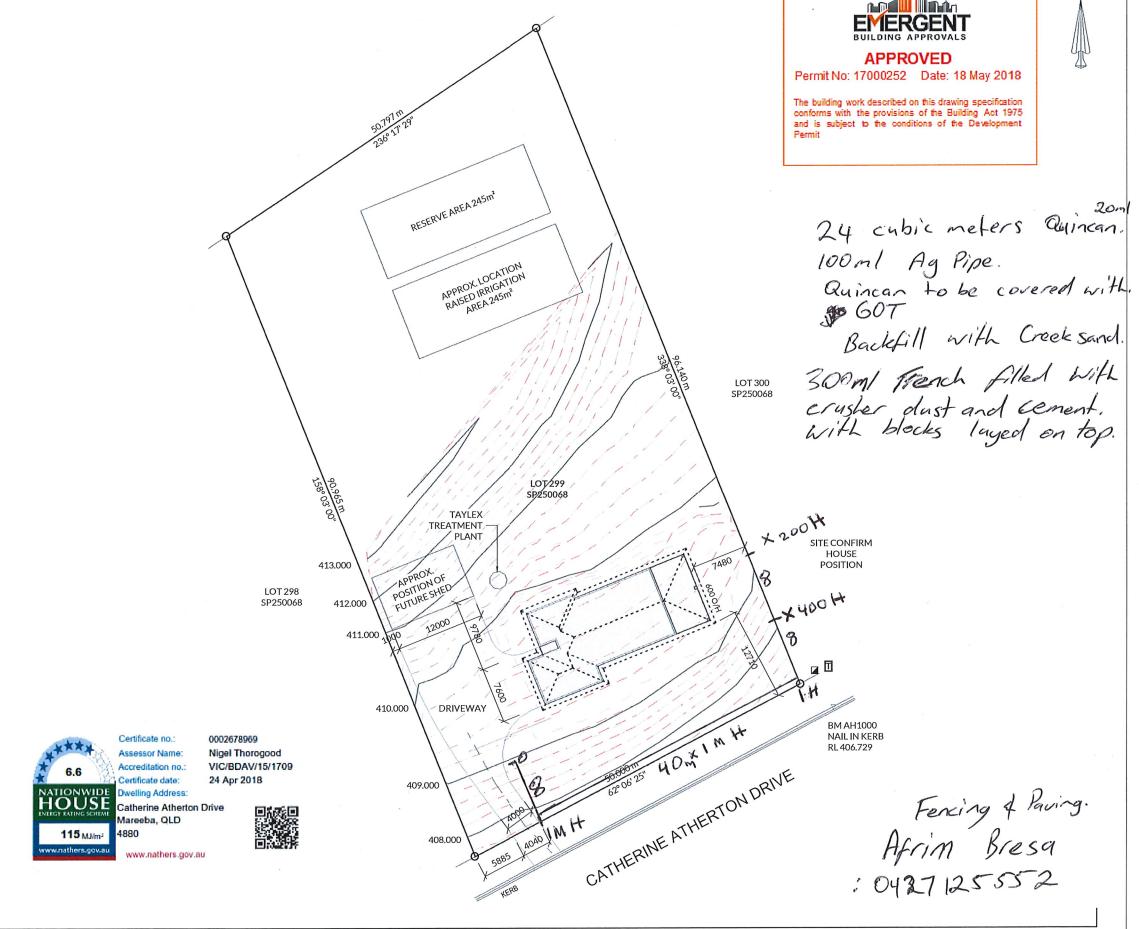



M: 0419 786 578 M: 0403 508 705 E: plans@areidesigns.com.au W: areidesigns.com.au ABN: 31614195818 QBCC LIC: 15040397

- WATER LINE

| AREI PLAN CODE: SERIES 10 ASH3 CLIENT: CAPITAL HOMES NQ

DRAWING NAME: SITE PLAN

PROJECT:
PROPOSED RESIDENCE FOR
LYN MOORE AT
LOT 299 CATHERINE ATHERTON DR
MAREEBA

| PLAN NUMBER: | 1173-18 | DATE: | 23/04/18

SCALE@A3

PAGE NO: 02 OF 08 DRAWN: N MCLEAN REV. REVISION DESCRIPTION APPROV. DATE
B PRELIMINARY ISSUE 09/04/18
C CONSTRUCTION ISSUE 18/04/18
D CONSTRUCTION ISSUE 19/04/18
E CONSTRUCTION ISSUE 23/04/18

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1 2<sup>m</sup> 3 4<sup>m</sup> 5 6<sup>m</sup> 7 8<sup>m</sup> 9 10<sup>m</sup>

N




# **APPROVED**

Permit No: 17000252 Date: 18 May 2018

2 / 2 / 2 / 2 /

The building work described on this drawing specification conforms with the provisions of the Building Act 1975 and is subject to the conditions of the Development

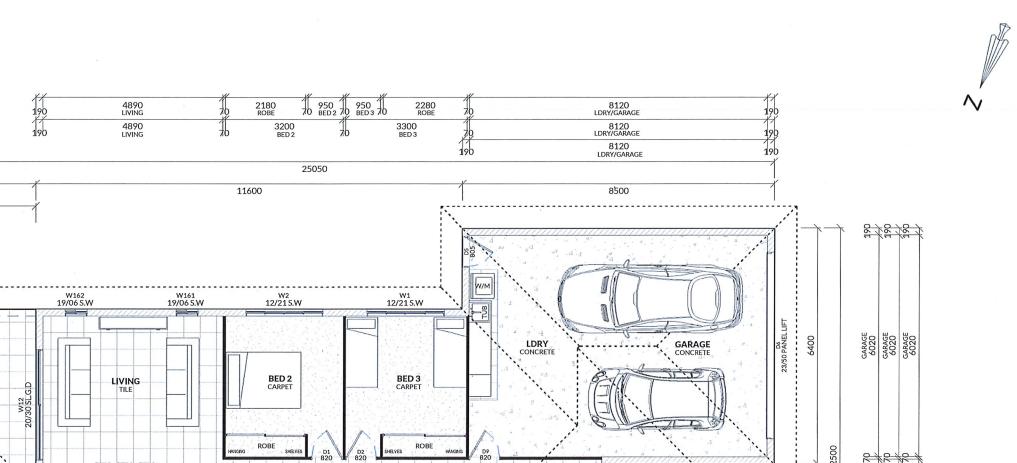

NATIONWIDE HOUSE 115 MJ/m3

Accreditation no.: ertificate date: welling Address:

0002678969 Nigel Thorogood VIC/BDAV/15/1709 24 Apr 2018

Catherine Atherton Drive Mareeba, QLD

www.nathers.gov.au



# **FLOOR AREAS**

253.0 m<sup>2</sup>

GARAGE 53.1 m<sup>2</sup> LIVING 149.2 m<sup>2</sup> PATIO 48.0 m<sup>2</sup> PORCH 2.6 m<sup>2</sup>

NOTE: ALL WINDOWS TO BE ALUMINIUM FRAMED WITH TINTED GLASS . SAFETY FLYSCREENS TO BE INSTALLED TO ALL WINDOWS & DOORS.



4950

PATIO CONCRETE

4950

4600

BLOCK LINTEL

4600

**CAPITAL HOMES NQ** 

DINING

2550

KITCHEN

KITCHEN 4570

KITCHEN 4570

COOKTOP U/BOVEN

BENCH

DRAWER BOX

PROPOSED RESIDENCE FOR LYN MOORE AT LOT 299 CATHERINE ATHERTON DR | SCALE @ A3 **MAREEBA** 

BED 4 CARPET

25050

70 BED 4 70 950

W8 12/21 S.W

BED 4 3400

11000

BATH

1500 BATH

ватн 1800

ватн 1800

W7 12/15 S.W 09/06 Ş.₩

| PLAN NUMBER: I DATE:

W5 12/10 S.W

ENS 1300

w.c / 950

w.c 950

ENS 3220

PAGE NO: 03 OF 08 DRAWN: N MCLEAN CHECKED:

REV. REVISION DESCRIPTION APPROV. DATE PRELIMINARY ISSUE CONSTRUCTION ISSUE 18/04/18 CONSTRUCTION ISSUE 19/04/18 CONSTRUCTION ISSUE 23/04/18

2200

PORCH CONCRETE

MASTER CARPET

W3 15/18 S.W

MASTER 3110

2300

6900

MASTER 5150

MASTER 5150

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\$ 12 × 2 × 2

WIR 950




TOTAL

M: 0419 786 578 M: 0403 508 705 E: plans@areidesigns.com.au W: areidesigns.com.au ABN: 31614195818 QBCC LIC: 15040397

AREI PLAN CODE: SERIES 10 ASH3

DRAWING NAME: **FLOOR PLAN** 

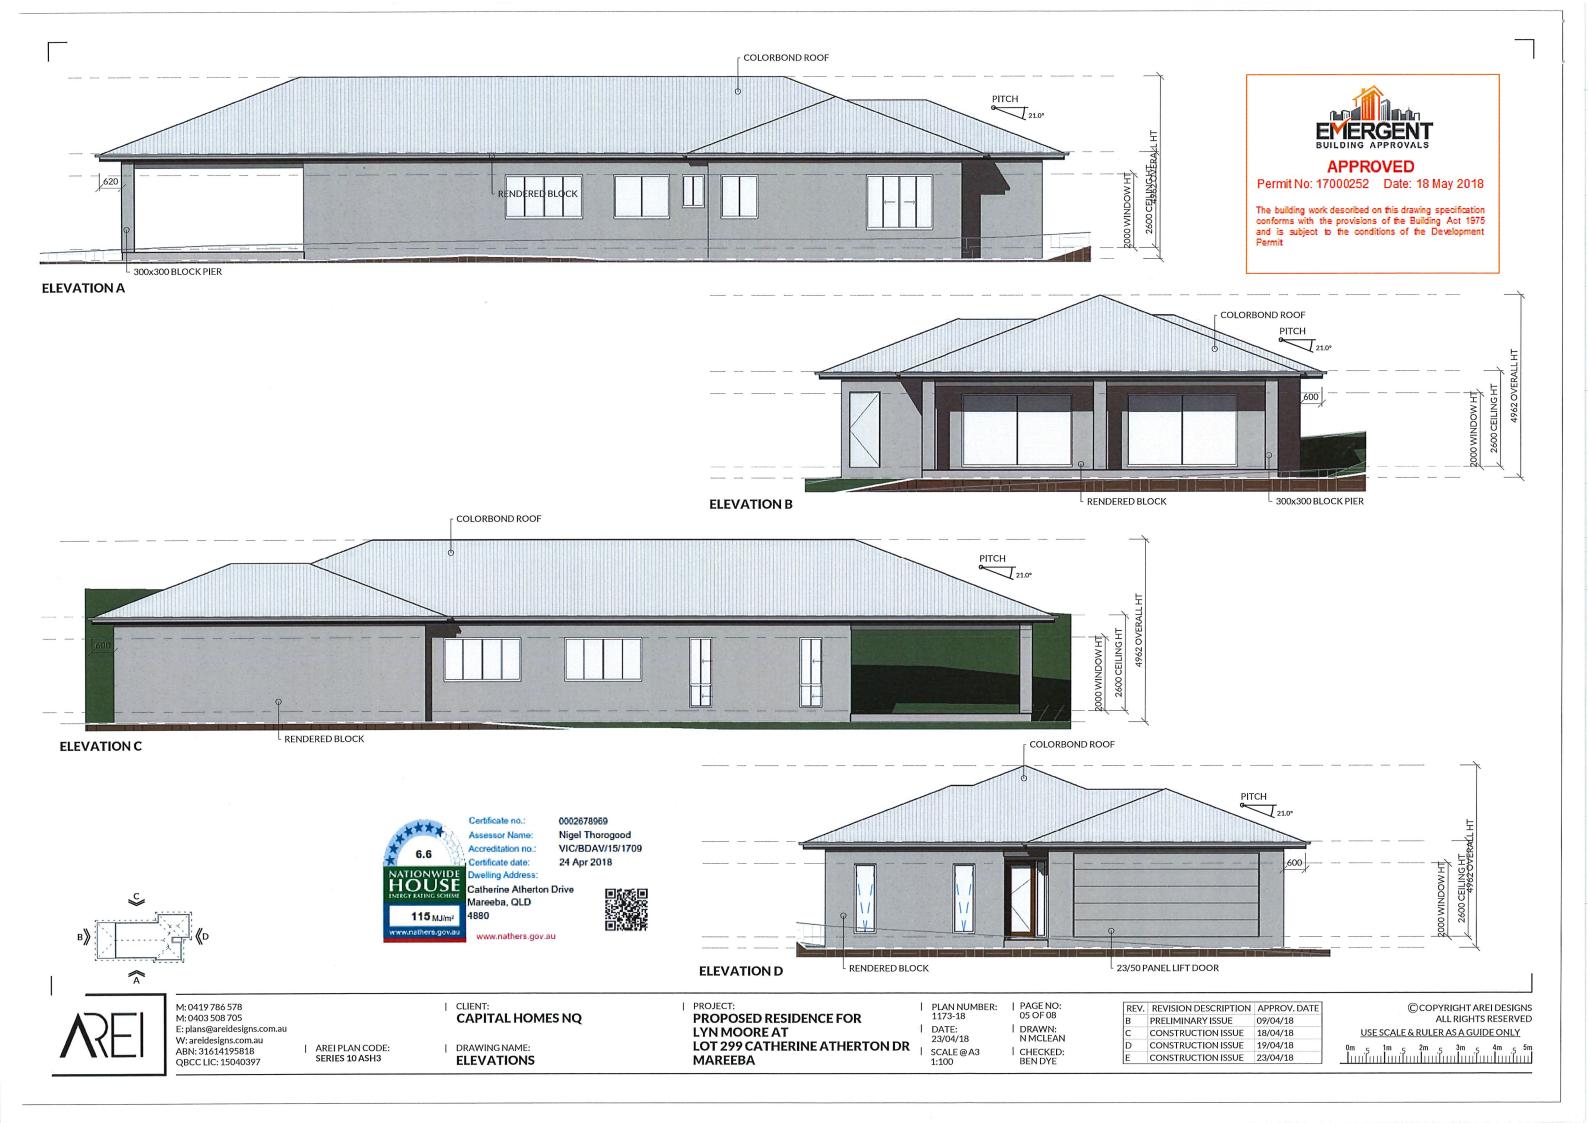

# **General Notes**

# G. General

- G.1 Drawings to be read in conjuction with accompanying architect's plans.
- G.2 Do not scale drawings. All dimensions to be confirmed on site.
- G.3 All construction to be in accordance with relevant Australian standards, the Building Code of Australia and local authority regulations.
- G.4 All workmanship and materials to be in accordance with relevant Australian standards.
- G.5 The structure is to maintained in a stable condition at all times.

# TP. Termite Protection

- TP.1 Termite treatment to be as required by AS 3660.1, the Building Code of Australia and the Qld Master Builders Association's "Home Owners Guide for Termite Management".
- TP.2 Termite protection generally shall be by:
  - ground floor slab as barrier and exposed edge of slab as visual barrier:
  - b) Termi-mesh or similar approved collars to slab penetrations; &
  - c) termite resistant (hazard level H2) timber framing generally
- TP.3 Builder to provide access for clear visual inspections to the entire perimeter of the building and the exposed edge of concrete slabs.
- TP.4 A durable notice showing full details of termite treatment used and the date provided to be posted inside the meter box or similar approved location.
- TP.5 Owner to maintain access for clear visual inspections and make periodic inspections.

# W. Waterproofing

W.1 Any exposed structural timber which has any area in contact with another material and which will be inaccessible after fixing is to be given a coat of primer before fixing.

# SN. Site Notes

- SN.1 Earthworks to be in accordance with AS 2870.
- SN.2 All water to be drained away from buildings during and after construction.
- SN.3 Finished slab levels to be min 250mm above finished ground level u.n.o.
- SN.4 All levels to be confirmed on site.

# F. Footings and Slab Notes

- F.1 Footings have been designed for Class 'M' site classification. Builder to verify site conditions prior to construction.
- F.2 Natural foundations to be grubbed out and free of organic matter and debris and compacted to min 95% SRDD at -5% to +2% of optimum moisture content or not less than 65% density index for cohesionless soils.
- F.3 Fill to slab and foundations shall be an approved non-plastic material compacted in max 200mm layers to min 95% SRDD at -5% to +2% of optimum moisture content or not less than 65% density index for cohesionless soils.
- F.4 Footing trenches to be clean and dry at the time of casting with any softened material removed. Base of all footings to be founded on firm natural ground with min safe bearing capacity of 100 kPa.
- F.5 Pour slab on 200um damp proof membrane laid on 50mm compacted sand.
- F,6 Concrete slab and footings N20. Vibrate concrete and cure slab for min 7 days. Concrete cover to be maintained by the use of approved chairs spaced at approx 750mm centres. Conduits and pipes shall not be placed within cover concrete.

# M. Masonry

- 1.1 Masonry shall generally comply with AS3700.
- M.2 Unless noted otherwise provide:
  - a) Bond beams two course, 1-N16 per course, lap 600
  - b) Lintel single course, 1-N16
  - c) Vertical reinforcement:
    - i) provide N12 vertical reinforcement at ends, corners and each side of openings and 1200 max centres between
    - provide additional N12 vertical reinforcement each side of openings greater than 2400
    - iii) starter bars to be provided at each vertical reinforcing bar bent 200mm at footing and lapping vertical bar 600mm
  - d) Sills single course under window openings, 1-N12, extend 200mm past each side of opening
  - e) Core fill all cores containing reinforcing to be cleaned and filled with S20 concrete

# C. Concrete

- C.1 Concrete generally in accordance with AS3600.
- C.2 Concrete specification unless noted otherwise:

Element	Class & Grade	Max Agg	Max Slump
Groundslab & footings	N20	20mm	80mm
Core fill	S20	10mm	230mm

C.3 Reinforcement notation:

'N' denotes Grade D500N hot rolled rebar to AS4671
'S' denotes Grade D250N hot rolled rebar to AS4671
'R' denotes Grade R250N hot rolled plain round to AS4671
'L' denotes Grade R500L cold drawn round wire to AS4671
'DW' denotes Grade D500L cold drawn ribbed wire to AS4671
'RL', 'SL', 'L\_TM' denotes Grade D500 deformed wire meshes to AS4671

- C.4 Additives shall not be used without the Superintendent's approval.
- C.5 Mechanically vibrate concrete in the form to give maximum compaction without segregation of the concrete.
- C.6 Cure concrete as required by Section 19 of AS3600.
- C.7 Concrete sizes shown are minimum and do not include applied finishes. Do not reduce or hole concrete without Superintendent's approval.
- Do not place conduits, pipes and the like within the cover concrete.
- C.9 Formwork shall generally comply with AS3610.
- C.10 Stripping of formwork shall comply with Section 19 of AS3600.

# T. Structural Timber

- T.1 Timber generally to AS 1684 and AS 1720.
- T.2 Min stress grade F14 unless noted otherwise.
- T.3 Min bolt size M12 unless noted otherwise.
- T.4 Timber framing:
  - a) 90x35 MGP-12 (H2) framing
  - b) studs @ 450 crs, 1 row nogging
  - c) single bottom plate, double top plate
  - M12 cyclone rods at ends, corners, beside openings and otherwise at max 1200mm crs
  - e) lintels 150x75 F14 hwd unless noted otherwise
- T.5 Wall bracing (where nominated): 4mm F27 structural ply fixed with 2.8Øx30 gal flathead nails @ 100 crs at top & bottom plate, @ 150 crs at vertical edges and @ 300 crs at intermediate studs.

Fix wall bottom plate to joists with M12 bolts @ 900 crs.

Fix wall top plate to trusses with 125x75x6 angle bracket, 1/M12 bolt top plate and truss.

Where bracing wall is parallel to joists or trusses, provide 50x75 F14 hwd nogging @ 900 crs fixed with 2/75mm batten screws each end. 1/M12 bolt thru nogging and wall top plate.

# S. Steelwork

- .1 Generally in accordance with AS 4100, AS 1554.1 and AS 1538.
- S.2 Unless noted otherwise, the following materials shall be used:
  - a) hot rolled sections Grade C300 plus to AS 3679.1
  - b) steel hollow sections Grade C350 to AS 1163
  - c) cold formed steel sections Grade 450 to AS 1397
  - d) bolts Grade 4.6/S to AS 1111 generally and Grade 8.8/S to AS 1252
  - e) galvanised bolts to AS 1214
  - f) welding to comply with AS 1554.1
- S.3 Unless noted otherwise use:
  - a) 10mm thick cleats, gussets, fins and end plates
  - b) all bolts to be galvanised to AS 1214
  - c) 6mm continuous fillet welds to AS 1554.1
  - all structural steelwork galvanised or system painted to equivalent protection

# R. Roofing

- R.1 Roof trusses and roof bracing in accordance with manufacturer's specification for C2 (W50C) wind classification.
- R.2 Roof battens 2 @ 550 crs at ridges and eaves, otherwise 850 crs: Topspan 40 battens fix with 2-No. 12-11x40 Hex Head Type 17 self drilling screws.
- R.3 Roof sheeting fixed in accordance with manufacturer's specification for C2 (W50C) wind classification.

# EMERGENT

# **APPROVED**

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# Ultimate and Serviceability Limit State Design Wind Pressures for Glazing

	Design gust wind speed (m/s)		Design pressures for windows (kPa)			
Wind classification	Vh,u	Vh,s	Greater than 1.2m from corners		Up to 1.2m from corners	
	ULS	SLS	ULS	SLS	ULS	SLS
C1	50	32	± 1.80	± 0.55	- 2.70	- 0.83
C2	61	39	± 2.68	± 0.88	- 4.02	- 1.23

WIND CLASSIFICATION C2

CLASS 'M' SITE

Α	8/5/18	Original Issue	KFB	KFB
No.	Date	Issue / Revisions	Drn	Chkd
Dwg File: K-5099-DWG-001.dwg XRef File: N/A				

CAPITAL HOMES NQ

Proposed residence for Lyn Moore at Lot 299 Catherine Atherton Dr, Mareeba Qld 4880



KFB ENGINEERS

ABN 73 618 014 261

Ci

Civil & Structural

Job No: K-5099

Sheet: 1 A of 6

Scale: As Shown (A3)

1/38-42 Pease St, Cairns | PO Box 927, Cairns Q 4870 P: 07 40320492 | F: 07 40320092 E: email@kfbeng.com.au

# N12 @ 600 CRS TO THIS WALL ..... W162 L3C 12/215W L3C 12/213W W161 19/06 S.W BLOCK LINTEL LIVING CARPET BEO 3 PORCH VZ DINING ROBE - DRAWER BOX 1200×1300 CODKTOP U/BOVEN 1.500 BATH 12/15 S.W 09/06 SAV L3C 12/215,W L2D $\Upsilon_{\mathsf{A}}$ N12 @ 600 CRS TO THIS WALL 12/105.W 15/18 5.W

**BLOCK PLAN** 

- GIRDER TRUSS LAYOUT INDICATIVE ONLY. TO BE CONFIRMED BY TRUSS MANUFACTURER.
- 2) DETAIL A TO BE USED FOR TRUSS REACTIONS GREATER THAN 44 kN.

# BLOCK REINFORCEMENT AND ROOF LAYOUT PLAN

## INTERNAL WALLS: NON-LOADBEARING


- 70x35 MGP10 (H2) STUDS @ 600 CRS
- 70x35 MGP10 (H2) BOTTOM AND TOP PLATE
- FIX BOTTOM PLATE WITH RAMSET @ 900 CRS
- 1 ROW NOGGING 1350mm FROM FLOOR

## 200mm MASONRY BLOCK WALL CONSTRUCTION NOTES

- REFER DETAIL 1 ON SHEET 3
- MASONRY WALL CONCRETE CORE FILL S20, 230mm SLUMP, 10mm AGGREGATE, MIN. 300 kg/m3 CEMENTITIOUS (FLYASH/CEMENT) MATERIAL CONTENT

NOTE: THE GARAGE ROLLER DOOR OR GARAGE PANEL LIFT DOOR AND IT'S FIXINGS ARE TO BE C2 CYCLONE RATED TO AS4505.

NOTE: ALL LINTELS L3A UNLESS NOTED OTHERWISE. SEE LINTEL DETAILS ON SHEET 3.

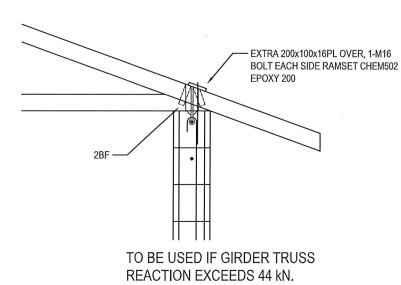

# **DETAIL A**



# **APPROVED**

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# WIND CLASSIFICATION C2

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Dwg File: K-5099-DWG-001.dwg XRef File: N/A					

CAPITAL HOMES NQ

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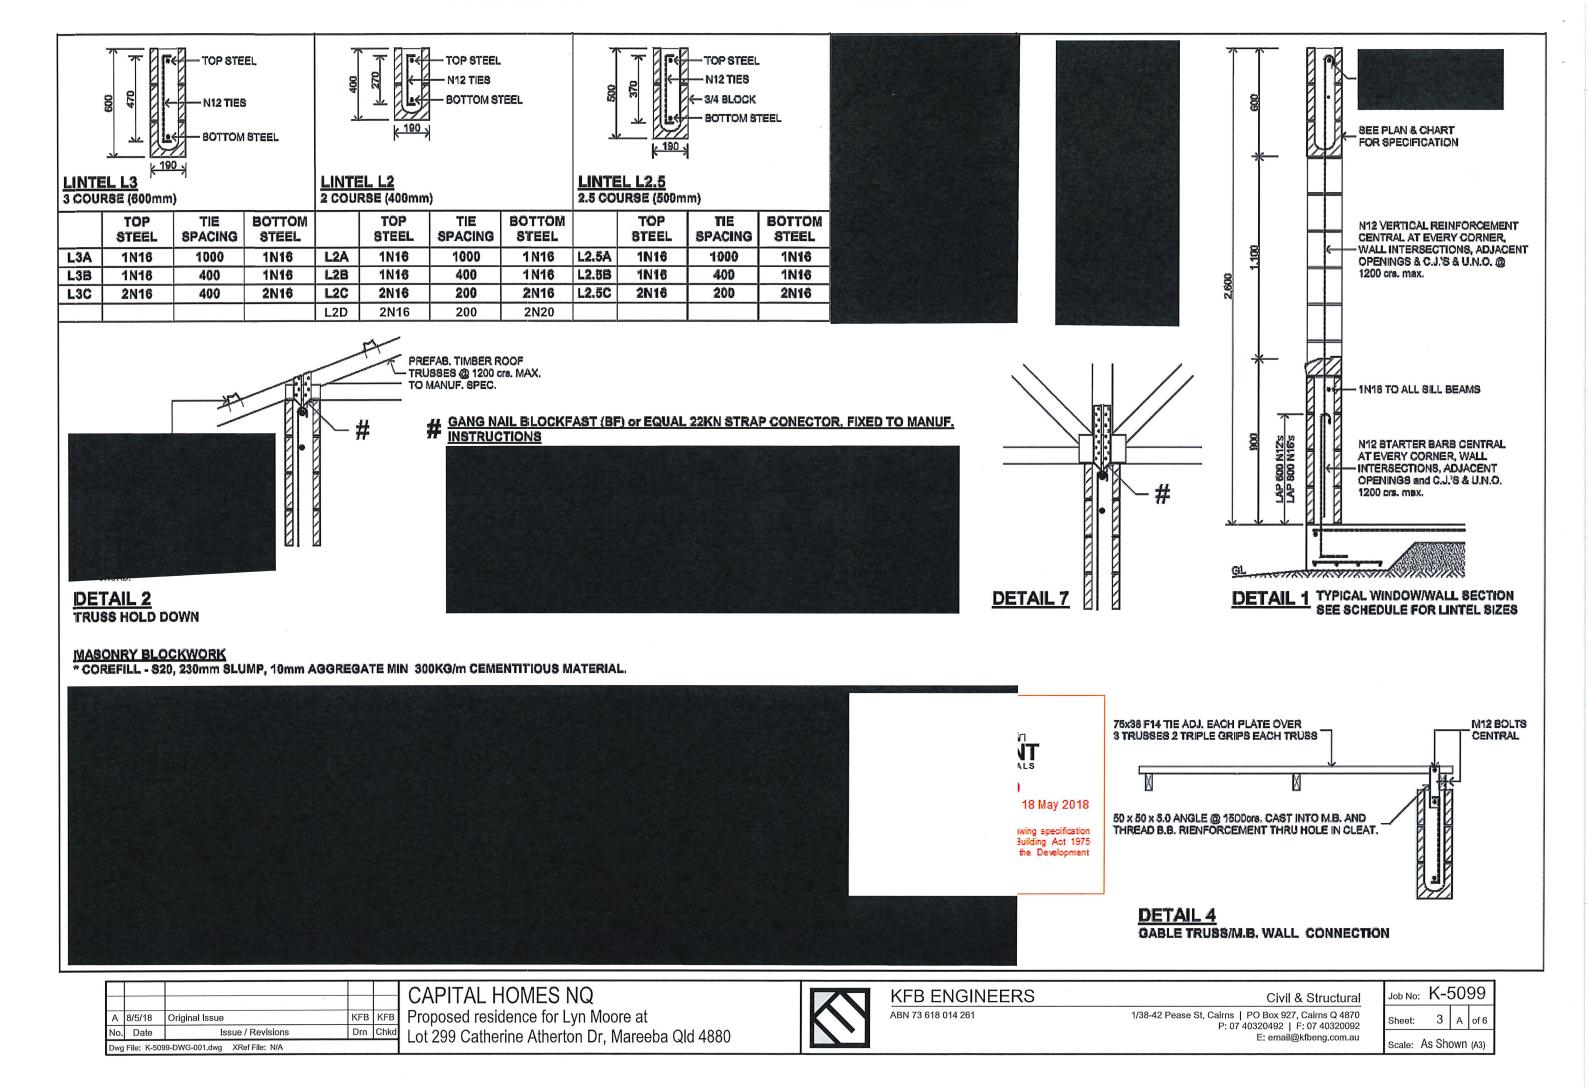
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2 Sheet:

Scale: As Shown (A3)






# APPROVED

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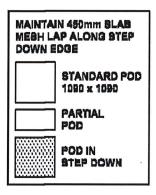
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**SLAB PLAN** 

**BUILDER TO GRUB OUT & CLEAR SLAB AREA & ANY FILL AREA OF ORGANIC** MATERIAL & BOULDERS, COMPACT **NATURAL FOUNDATIONS & FILL TO 95%** SRDD. MIN. SAFE GROUND BEARING **CAPACITY TO BE 100KPa.** 

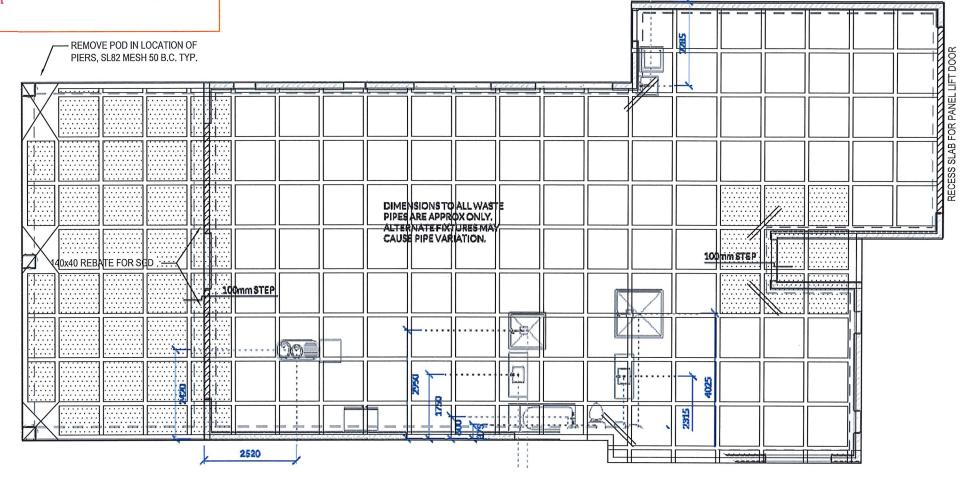- 1) 85mm SLAB REINFORCED WITH RF82 MESH, 30mm COVER INTERNALLY, 40mm COVER EXTERNALLY. LAP MESH 2 CROSS-
- 2) CONCRETE N20, 80mm SLUMP, 20mm AGGREGATE.
- 3) SLAB LAID ON 200UM PVC MEMBRANE LAPPED 200mm AT JOINS and TAPED.
- 4) UNDER SLAB PROVIDE COMPACTED SAND FILL TO 95% SRDD.
- 5) VIBRATE ALL CONCRETE.
- 8) ALL SERVICE TRENCHES (SEWERAGE, STORMWATER, PRESSURE WATER MAIN TO BE MINIMUM OF 1000mm FROM
- 7) SLOPE GROUND AWAY FROM SLAB EDGE, 1:10 FOR I metre MIN. and PROVIDE A GRADED 400mm WIDE x 75mm DEEP 'V' SHAPED EARTH TABLE DRAIN TO DIRECT ALL SURFACE WATER AWAY FROM THE SLAB EDGE and TO DRAIN THE BUILDING PAD. 8) CURE SLAB MINIMUM 7 DAYS.



# NOTE -

- 140mm WIDE x 40mm DEEP REBATE TO ALL SLIDING DOORS.



2-N12 BARS 1200 LONG TO RE-ENTRANT CORNERS TIED UNDER TOP MESH. 40 COVER TO CORNER.

CLASS 'M' SITE

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KFB ENGINEERS

ABN 73 618 014 261


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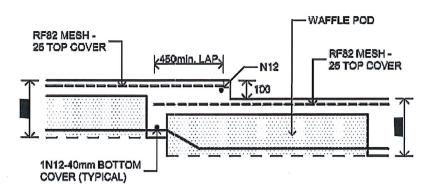
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Scale: As Shown (A3)



# WAFFLE POD DETAIL



# PATIO & GARAGE STEP DOWN DETAIL

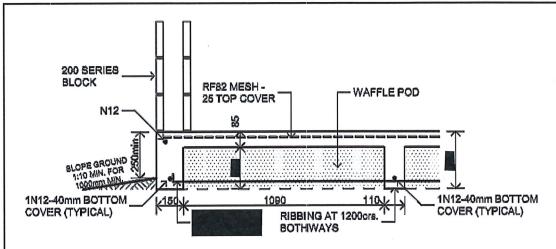



# **FOOTING NOTES**

- 1. THE BUILDING PLATFORM SHALL BE COMPACTED TO 95% SRDD IN ACCORDANCE WITH A.S. 3798
- 2. THE FINISHED GROUND LEVEL OF ALL THE PERIMETER SHALL BE GRADED TO FALL 1 IN 10 FOR 1000mm MINIMUM.
- 3. MINIMUM 50mm OF BEDDING SAND COMPACTED TO 95% SRDD SHALL OVERLAY THE COMPLETED BUILDING PLATFORM BUT IS NOT REQUIRED AT THE BOTTOM OF INTERNAL or EXTERNAL THICKENINGS.
- 4. ALL SLABS SHALL BE UNDERLAIN WITH A 200UM VAPOUR BARRIER LAPPED 200min. and SHALL CONTINUE UNDER ALL INTERNAL THICKENINGS and TO THE BOTTOM EXTARNAL EDGE OF PERIMETER EDGE THICKENINGS.
- 5. ALL SLABS SHALL COMPLY WITH AS2870-2011 WITH PARTICULAR ATTENTION PAID TO THE DETAILING and CONSTRUCTION REQUIREMENTS OF SECTIONS 5 and 6 OF THAT CODE, COVER :- FOOTINGS - 50 BOTTOM, 50 TOP and SIDES SLABS - 20 INTERNAL, 40 EXTERNAL.
- 6. CURE SLAB MINIMUM 7 DAYS.



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Durg Elle: K 5000 DWG 001 durg YPof Elle: N/A					

CAPITAL HOMES NQ

Proposed residence for Lyn Moore at Lot 299 Catherine Atherton Dr., Mareeba Qld 4880

310mm

310mm

310mm

310mm

385mm

385mm



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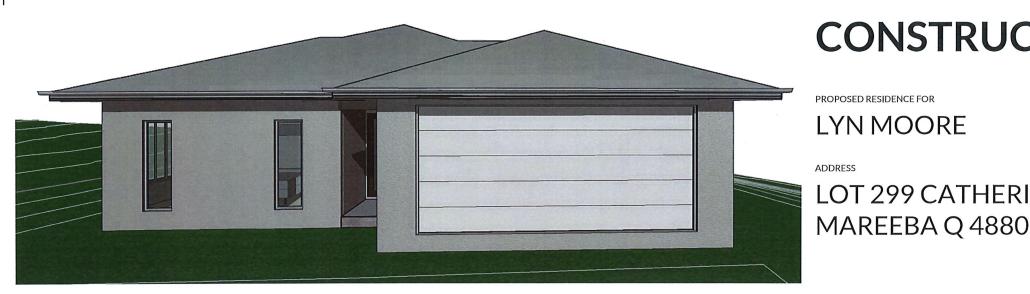
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5 A of 6

Scale: As Shown (A3)



# **CONSTRUCTION DRAWINGS**

PROPOSED RESIDENCE FOR

LYN MOORE

**ADDRESS** 



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#### PAGE NO PAGE TITLE 01 COVER SITE PLAN 02 03 FLOOR PLAN 04 3D VIEWS **FI EVATIONS** 05 06 CROSS SECTION FOUNDATION PLAN ELECTRICAL & FIXTURES PLAN

**PAGE LIST** 

### **GENERAL NOTES:**

- 1. ALL DESIGN, CONSTRUCTION METHODS AND MATERIALS TO BE IN ACCORDANCE WITH:
- THE CURRENT NATIONAL CONSTRUCTION CODES (NCC)
- THE STATE DEVELOPMENT CODE
- **BUILDING REGULATIONS**
- CURRENT ISSUES OF AUSTRALIAN STANDARDS & MANUFACTURERS SPECIFICATIONS & INSTALLATION DETAILS FOR MATERIALS USED
- THESE PLANS ARE TO BE READ IN CONJUNCTION WITH CONTRACT DOCUMENTS AND ENGINEERS DRAWINGS AND SPECIFICATIONS. RESPONSIBLE PARTIES ARE TO BE NOTIFIED OF ANY DISCREPANCIES.
- SUBSTITUTION OF ANY STRUCTURAL MEMBERS & OR VARIATIONS TO ANY PART OF THE DESIGN WILL VOID ANY RESPONSIBILITIES OF THE **BUILDING DESIGNER FOR THE STRUCTURAL** INTEGRITY & PERFORMANCE OF THE BUILDING.
- 3D VIEWS, PERSPECTIVES AND ILLUSTRATIONS ARE INTENDED TO BE A VISUAL AID ONLY, THEY ARE NOT PRESCRIPTIVE BUT INDICATIVE ONLY THE IMAGES ARE NOT TO BE RELIED UPON IN ANY WAY FOR FINAL CONSTRUCTION FINISHES AND RESULTS.
- ALL DIMENSIONS IN MILLIMETERS.
- DIMENSIONS TAKE PREFERENCE TO SCALE AND ARE TO STRUCTURE NOT FINISH ON NEW WORK. EXISTING WALLS MAY BE NOMINALLY
- OWNER REMAINS RESPONSIBLE FOR ONGOING MAINTENANCE OF BUILDING. STRUCTURAL ELEMENTS IN PARTICULAR ARE TO REMAIN PROTECTED BY THE METHODS SHOWN AND LISTED IN THESE DRAWINGS

## **WET AREA NOTES:**

- 1. ALL WET AREAS TO BE WATERPROOFED IN ACCORDANCE WITH NCC AND AS 3740.1
- ALL WALL AND FLOOR PENETRATIONS IN WATERPROOFED AREAS TO BE WATERPROOFED BY SEALING WITH A PROPRIETARY FLANGE SYSTEM OR
- ACHIEVE MINIMUM REQUIRED FALLS TO ENSURE WATER DRAINAGE TO FLOOR AND SHOWER WASTES. 5. MIN. FALL TO FLOOR WASTES TO BE 1:100, MIN. FALL TO SHOWER WASTES TO BE 1:80.

# **SITE WORKS NOTES:**

- POSITION OF DWELLING TO BE CONFIRMED BY SURVEYOR & CLIENT PRIOR TO ANY SITE WORKS.
- ALL STORMWATER, DOWN PIPES, RAIN WATER TANKS & SITE DRAINAGE TO BE SIZED & LOCATED BY THE HYDRAULIC CONSULTANT/ PLUMBER IN ACCORDANCE WITH NCC VOL. 2.3.1.2 & 3.5.2 AND STATE LEGISLATION/LOCAL PLANNING SCHEME HOUSE CODE AND AS 3500 ALL PARTS.
- BUILDER TO ENSURE THAT ACTUAL SEWER LINE AND MANHOLE POSITIONS MATCH THOSE AS SHOWN AS BASED ON LOCAL AUTHORITY DOCUMENTS. ANY DISCREPANCIES MUST BE BROUGHT TO ATTENTION AND RESOLVED PRIOR TO COMMENCEMENT OF CONSTRUCTION.
- BUILDER TO DETERMINE APPROPRIATE PLATFORMING METHOD ON SITE PRIOR TO COMMENCEMENT OF ANY WORKS, FINISHED FLOOR LEVEL IS TO BE ABOVE THE MINIMUM LEVEL AS PER LOCAL AUTHORITIES REQUIREMENTS & TO COMPLY WITH NCC VOL. 2.3.1.2.3.
- FALL OF LAND UNKNOWN AND IS TO BE CONFIRMED ON SITE BEFORE COMMENCEMENT OF CONSTRUCTION. ANY REQUIRED EARTHWORKS INCLUDING CUT, FILL, BATTERS AND RETAINING MUST COMPLY WITH THE CURRENT NCC VOLUME 2 3.1.1, AS 3798 & AS 4200.
- THE FINISHED SURFACE IMMEDIATELY SURROUNDING THE DWELLING, 1000mm WIDE, IS TO FALL AWAY FROM THE DWELLING AT A SLOPE OF 1 IN 20 MINIMUM.
- 7. STORMWATER MUST BE CONNECTED TO A LEGAL POINT OF DISCHARGE -
  - ROOFWATER/STORMWATER PIPE
  - BUBBLERS TO COUNCIL SPECIFICATION.
- RAINWATER TANK, OVERFLOW MUST CONNECT TO STORMWATER SYSTEM.
- SURFACE DRAINAGE IS TO DISCHARGE EVENLY WITHIN THE SITE AND WITHOUT NUISANCE TO ADJOINING PROPERTIES.
- ALL SUB-FLOOR AREAS MUST BE GRADED TO AVOID THE PONDING OF WATER.

## WET AREA NOTES (CONT.):

- WATERSTOPS TO BE INSTALLED IN ALL LOCATIONS REQUIRED BY AS3740.
- ALL UNENCLOSED SHOWERS ARE TO HAVE A WATERSTOP INSTALLED FLUSH WITH THE FLOOR
- ALL ENCLOSED SHOWERS WITHOUT HOBS ARE TO HAVE A WATERSTOP INSTALLED UNDER THE SHOWER FRAME, FINISHING A MINIMUM OF 5MM ABOVE THE

#### **PATH/DRIVEWAY NOTES:**

- DRIVEWAY SLOPE NOT TO EXCEED 1:4. CHECK WITH LOCAL AUTHORITY REQUIREMENTS PRIOR TO CONSTRUCTING ANY DRIVEWAYS, PATHWAYS OR CROSSOVERS BETWEEN THE PROPERTY BOUNDARY AND ROAD KERB
- PROVIDE A LAYER OF SAND A MINIMUM OF 20mm THICK UNDER THE SLAB, COMPACTED AND LEVELED.
- SLAB THICKNESS, MESH TO ENGINEERS DESIGN.

#### **3D VIEW NOTES:**

- GROUND LINE OR SLOPE OF SITE IS NOT REPRESENTED ON 3D VIEWS.
- FURNITURE AND FIXTURES ARE INDICATIVE ONLY AND ARE NOT PRESCRIPTIVE.
- 3D VIEWS, PERSPECTIVES AND ILLUSTRATIONS ARE INTENDED TO BE A VISUAL AID ONLY, THEY ARE NOT PRESCRIPTIVE BUT INDICATIVE ONLY. THE IMAGES ARE NOT TO BE RELIED UPON IN ANY WAY FOR FINAL CONSTRUCTION FINISHES AND RESULTS.

# **ELECTRICAL NOTES:**

- 1. SMOKE ALARMS TO BE INSTALLED IN ACCORDANCE WITH THE NCC PART 3.7.2 - SMOKE ALARMS. SMOKE ALARMS MUST COMPLY WITH
- ONLY USE PHOTOELECTRIC TYPE SMOKE **ALARMS**
- ALL SMOKE ALARMS TO BE INTERCONNECTED
- INSTALL LOCATIONS:
  - 1. ON EACH LEVEL OF LIVING SPACE
  - OUTSIDE FACH BEDROOM AREA
  - 3. IN EVERY BEDROOM
- 2. THIS PLAN IS INDICATIVE ONLY AND IS TO BE USED ONLY AS AN EXAMPLE. OWNERS TO NOMINATE FINAL POSITIONS OF ELECTRICAL APPLIANCES, LIGHTING AND ELECTRICAL

# **ELEVATION NOTES:**

- WALL FINISHES AND WINDOW TYPES ARE INDICATIVE ONLY AND ARE NOT PRESCRIPTIVE. REFER TO BUILDERS SPECIFICATIONS FOR
- GROUND LINE SHOWN ON ELEVATIONS DOES NOT RELATE TO ACTUAL SLOPE OF SITE. FURNITURE AND FIXTURES ARE INDICATIVE ONLY

AND ARE NOT PRESCRIPTIVE.

ELEVATIONS ARE INTENDED TO BE A VISUAL AID ONLY, THEY ARE NOT PRESCRIPTIVE BUT INDICATIVE ONLY. THE IMAGES ARE NOT TO BE RELIED UPON IN ANY WAY FOR FINAL CONSTRUCTION FINISHES AND RESULTS.

- TRUSS DESIGN IS INDICATIVE ONLY AND IS NOT PRESCRIPTIVE. FINAL DESIGN TO TRUSS MANUFACTURER SPECIFICATIONS.
- ALL PINE TO BE JD4 MIN.
- ALL HWD. TO BE F14 MIN.
- GROUND LINE SHOWN DOES NOT RELATE TO ACTUAL SLOPE OF SITE.
- FURNITURE AND FIXTURES ARE INDICATIVE ONLY AND ARE NOT PRESCRIPTIVE.
- SECTIONS ARE INTENDED TO BE A VISUAL AID ONLY, THEY ARE NOT PRESCRIPTIVE BUT INDICATIVE ONLY. THE IMAGES ARE NOT TO BE RELIED UPON IN ANY WAY FOR FINAL CONSTRUCTION FINISHES AND RESULTS.

# **FOUNDATION NOTES:**

- THESE PLANS ARE TO BE READ IN CONJUNCTION WITH CONTRACT DOCUMENTS AND ENGINEERS DRAWINGS AND SPECIFICATIONS. RESPONSIBLE PARTIES ARE TO BE NOTIFIED OF ANY DISCREPANCIES, SITE CLASSIFICATION IS TO BE CONFIRMED BY INSPECTION OF FOOTING EXCAVATIONS.
- PLUMBER RESPONSIBLE TO LOCATE AND CONFIRM SEWER HOUSE CONNECTION LOCATION ACCURATELY PRIOR TO COMMENCEMENT PLUMBER IS TO VERIFY WITH SITE SUPERVISOR PRIOR TO SETTING OUT FIXTURE DRAINAGE POINTS. NO AMENDMENTS OR SPECIAL FIXTURES HAVE BEEN NOMINATED.
- WHERE SERVICES / PIPEWORK ARE LOCATED UNDER DRIVEWAYS AND SLABS CONTRACTORS ARE TO ENSURE ADEQUATE COMPACTION TO TRENCH BACKFILL ACHIEVED TO SUPPORT CONCRETE.
- REBATE GARAGE DOORS & SLIDING GLASS DOORS 20mm, AND SHOWER RECESSES 50mm IN LOCATIONS SHOWN.
- ACCORDING TO MANUF' SPEC. OR BUILDERS DIRECTIONS.
- MINIMUM COVER TO GROUND 50mm.
- TOP COVER TO SLAB REINFORCEMENT 30mm.
- GRADE FINISHED GROUND SURFACE TO DIVERT WATER AWAY FROM BUILDING.
- WATERPROOF MEMBRANE IS 0.2mm POLYETHYLENE. JOINTS ARE TO BE LAPPED 300mm AND TAPED.
- 10. REINFORCEMENT TO BE SUPPORTED ON PLASTIC CHAIRS AT 1000mm CRS.
- 11. ALL CONCRETE IS TO BE MECHANICALLY VIBRATED DURING PLACING. 12. FILL MATERIAL AND SAND UNDER SLABS IS TO BE
- COMPACTED TO 95% OF MAX. DRY DENSITY. 13. FLOORS TO ALL WET AREAS TO HAVE A FALL TO A FLOOR WASTE.

OT 299 CATHERINE ATHERTON DRIVE

- TERMITE CONTROL BARRIERS TO BE IN ACCORDANCE WITH AS 3660.1 AND NCC CLAUSE 3.1.3.
- ANY UNTREATED TIMBER POSTS, STAIRS AND THE LIKE SHALL BE SET 75MM MINIMUM CLEAR OF GROUND FOR VISUAL TERMITE CONTROL
- TWO APPROVED NOTICES SHALL BE AFFIXED TO THE DWELLING AS REQUIRED ADVISING OWNERS OF THE METHOD OF TERMITE RISK MANAGEMENT USED, AND THEIR ONGOING RESPONSIBILITY FOR THE MAINTENANCE OF THE SYSTEMS.
- BUILDER TO CONFIRM WITH OWNER THE CHOSEN METHOD OF TIMBER PROTECTION.
- OWNER REMAINS RESPONSIBLE FOR ONGOING INSPECTION OF STRUCTURAL TIMBER ELEMENTS, AND THAT BARRIERS ARE NOT COMPROMISED.
- WHERE CONCRETE SLAB FORMS BARRIER, SLAB TO BE CONSTRUCTED AS PER AS2870. SLAB & FOOTINGS TO BE "MONOLITHIC". TERMIMESH FLANGE TO BE CLAMPED TO PIPES AND SET IN SLAB. 75MM MIN OF EXPOSED SLAB EDGE TO REMAIN ABOVE FINISHED PERIMETER LEVEL. EXPOSED EDGE NOT TO BE COVERED BY SOIL RENDERED OR TILED, BUT MAY BE PAINTED. WHERE BRICKWORK CONCEALS EDGE OF SLAB, IN ADDITION TO ABOVE, PROVIDE TERMIMESH BARRIER BELOW D.P.C. FIXED TO SLAB EDGE.
- INSTALL ANT CAPPING TO ALL BRICK PIERS, TIMBER OR CONC STUMPS. KEEP TIMBER CLEAR OF GROUND WHEN ON STEEL ANCHORS. NON-TIMBER ITEMS (EG STEEL POSTS) NEED NO PROTECTION FROM TERMITES.
- ALL PRIMARY BUILDING ELEMENTS AS DEFINED BY THE BUILDING CODE OF AUSTRALIA INCLUDING THE OLD VARIATION ARE FITHER NATURALLY TERMITE RESISTANT AS PER APPENDIX 'C' OF AS3660.1 OR HAVE BEEN CHEMICALLY TREATED TO RESIST ATTACK FROM TERMITES IN ACCORDANCE WITH APPENDIX 'D" OF AS 3660.1-2000. IN ADDITION, ALL SLAB PENETRATIONS ARE ALSO PROTECTED WITH CHEMICAL SYSTEMS COMPLYING WITH AS3660.1-2000.

# FLOOR PLAN NOTES:

- SMOKE ALARMS TO BE INSTALLED IN ACCORDANCE WITH THE NCC PART 3.7.2 - SMOKE ALARMS. SMOKE ALARMS MUST COMPLY WITH
- ONLY USE PHOTOELECTRIC TYPE SMOKE ALARMS
- ALL SMOKE ALARMS TO BE INTERCONNECTED
- INSTALL LOCATIONS:
  - ON EACH LEVEL OF LIVING SPACE
  - OUTSIDE EACH BEDROOM AREA
  - IN EVERY BEDROOM
- 2. WALL FINISHES AND WINDOW TYPES ON 3D VIEWS ARE INDICATIVE ONLY AND ARE NOT PRESCRIPTIVE.
- 3. BUILDER TO CONFIRM ALL DIMENSIONS PRIOR TO CONSTRUCTION. DIMENSIONS ARE TO FRAME ONLY AND DO NOT INCLUDE CLADDING/LININGS
- S.S. BALUSTRADING TO COMPLY WITH CURRENT NCC VOLUME 2 SECTION 3.9.2.3 'WIRE BALUSTRADING CONSTRUCTION'
- DOORS TO W.C.'S TO HAVE LIFT OFF HINGES (ONLY IF THE DOORS SWING IN TOWARDS THE W.C). MASONRY CONSTRUCTION TO AS 3700.

REFER ENGINEERS DRAWINGS & SPECIFICATIONS

- FOR ALL STRUCTURAL DETAILS, FRAMING. BRACING, TIE DOWN AND SLAB/FOOTING DETAILS. SEAL WET AREAS IN ACCORDANCE WITH AS3740 & NCC REQUIREMENTS.
- PROVIDE FLOOR WASTE TO ALL WET AREAS, NOT INCLUDING LAUNDRY.

- **ROOF DRAINAGE NOTES:**
- 1. ALL GUTTER AND DOWNPIPE WORKS TO AS/NZS 3500.3 AND CURRENT NCC VOLUME 2 PART 3.5.2.
- DOWNPIPES (DP) TO BE 100mmØ UPVC. TEMPORARY DOWNPIPES TO BE PROVIDED AT DP
- LOCATIONS DURING CONSTRUCTION DRAINING ROOFWATER ONTO GROUND, 2M MIN AWAY FROM BUILDING. THE ROOF DRAINAGE SYSTEM MUST BE PROVIDED
- WITH AN OVERFLOW TO PREVENT THE BACKFLOW OF WATER INTO THE BUILDING.
- THE AREA SPECIFIC RAINFALL INTENSITY MUST BE SELECTED FROM NCC TABLE 3.5.2.1 OR FROM
- EAVES GUTTERS MUST BE INSTALLED AT A FALL NOT LESS THAN 1 IN 500 WITH SUPPORT BRACKETS AT 1.2m MAXIMUM CENTRES.
- DOWNPIPES MUST SERVE NOT MORE THAN 12 METERS OF GUTTER LENGTH FOR EACH DOWNPIPE WHICH MUST BE LOCATED AS CLOSE AS POSSIBLE TO VALLEY GUTTERS, EAVES GUTTERS MUST BE PROVIDED WITH AN OVERFLOW SYSTEM WHERE DOWNPIPES ARE LOCATED MORE THAN 1.2 METRES FROM A VALLEY GUTTER.
- 8. DOWNPIPES (DP) TO BE MAX. 12m LINEAL APART. GUTTER MAX ROOF AREA 100mm MIN. 7900mm<sup>2</sup> MIN

CROSS SECT. AREA

# **ENERGY EFFICIENCY NOTES:**

- ALL TAPWARE & SHOWERS TO BE 3 STAR MIN.
- ALL TOILETS TO BE 4 STAR MIN.
- ELECTRIC HOT WATER SYSTEM TO BE INSTALLED.
- BUILDING TO BE CONSTRUCTED IN ACCORDANCE WITH QUEENSLAND DEVELOPMENT CODE MP4.1-SUSTAINABLE BUILDINGS



M: 0419 786 578 M: 0403 508 705 E: plans@areidesigns.com.au W: areidesigns.com.au ABN: 31614195818 **OBCC LIC: 15040397** 

AREI PLAN CODE SERIES 10 ASH3

**CAPITAL HOMES NQ** 

| DRAWING NAME:

**COVER** 

PROJECT: **PROPOSED RESIDENCE FOR** LYN MOORE AT LOT 299 CATHERINE ATHERTON DR **MAREEBA** 

I PLAN NUMBER: 1173-18 DATE:

01 OF 08 23/04/18 SCALE@A3


DRAWN:

| PAGE NO:

I CHECKED

REV. REVISION DESCRIPTION APPROV. DATE PRELIMINARY ISSUE 09/04/18 CONSTRUCTION ISSUE 18/04/18 CONSTRUCTION ISSUE 19/04/18 CONSTRUCTION ISSUE 23/04/18

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# **APPROVED**

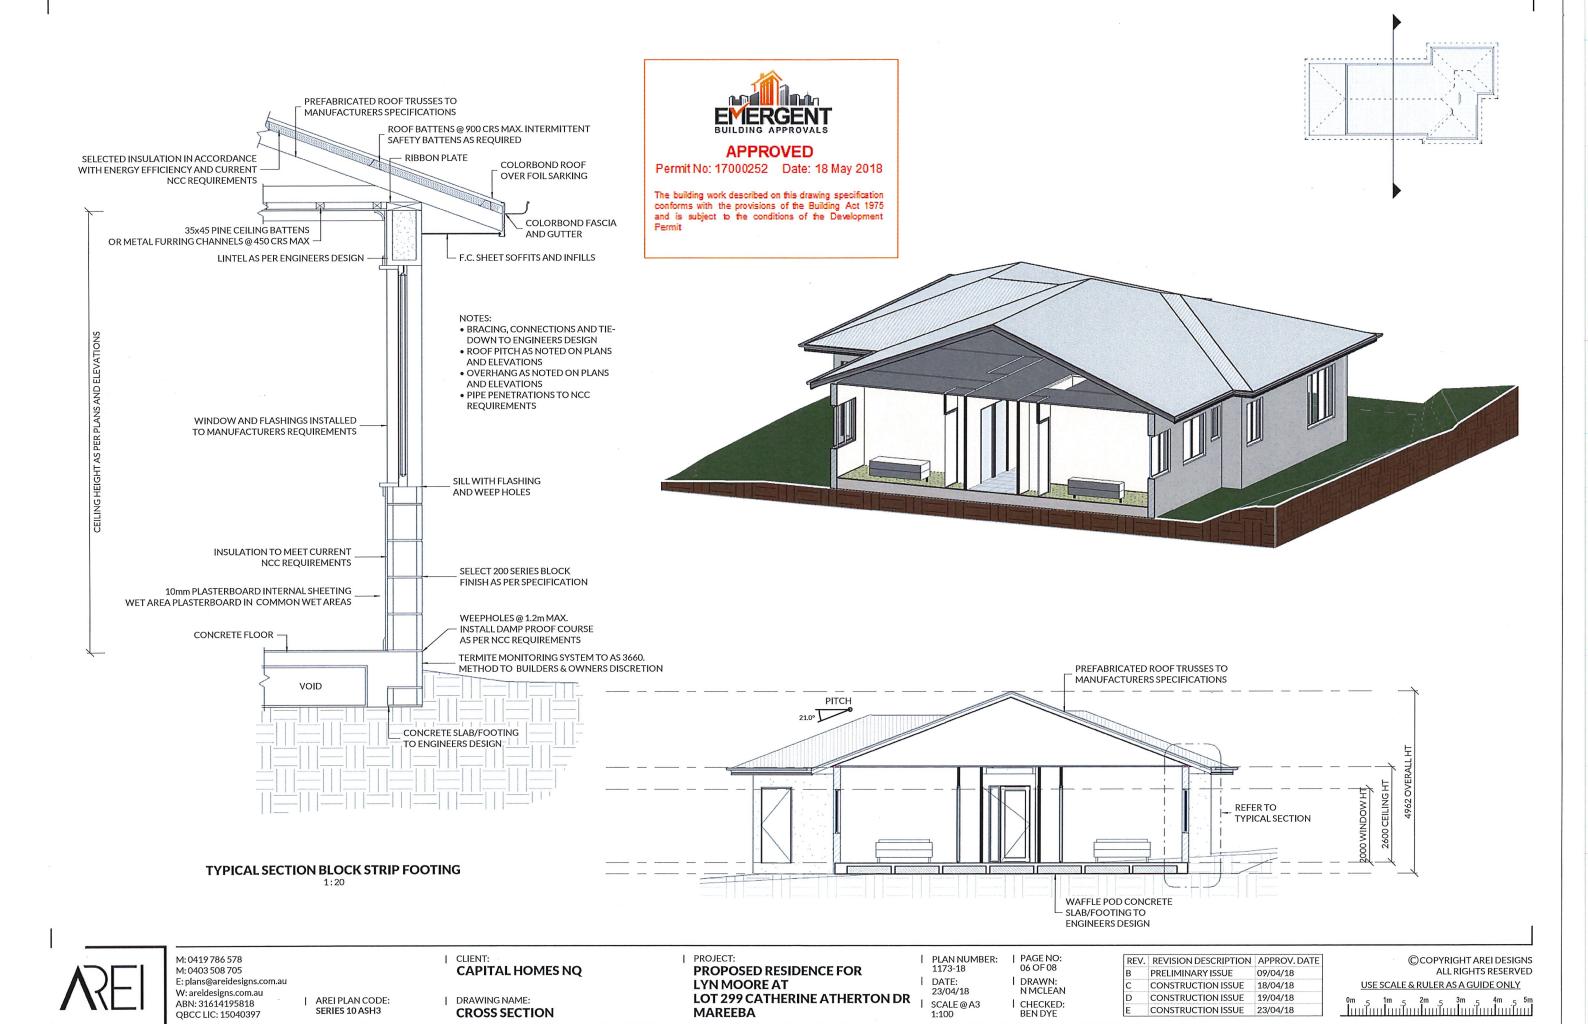Permit No: 17000252 Date: 18 May 2018

The building work described on this drawing specification conforms with the provisions of the Building Act 1975 and is subject to the conditions of the Development Permit


WINDOW SETOUT

1137

350

1 28



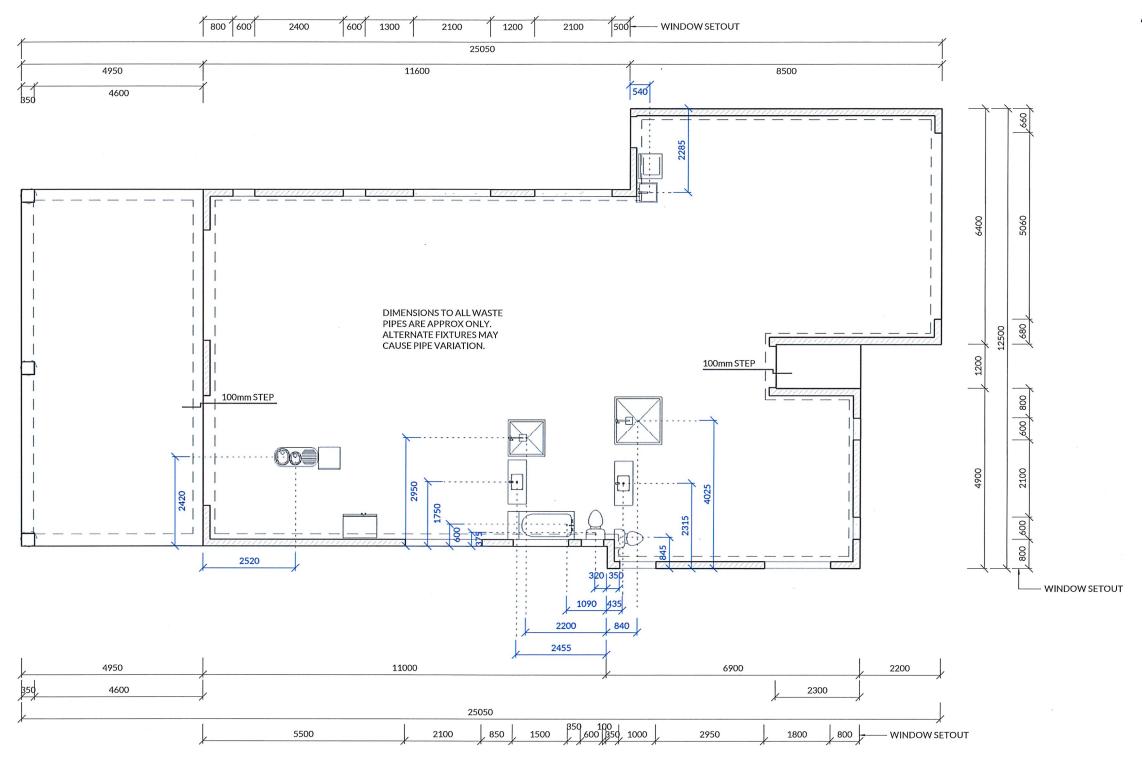

- NOTES:

  1. THIS PLAN IS INDICATIVE ONLY AND WILL DIFFER ON SITE. PLUMBER TO SUBMIT AS CONSTRUCTED PLAN TO COUNCIL.
- 2. INSPECTION OPENINGS AND VENTS ARE TO BE INSTALLED WHERE REQUIRED.
- 3. ALL PLUMBING WORKS AS PER RELEVANT AUSTRALIAN STANDARDS.



M: 0419 786 578 M: 0403 508 705 E: plans@areidesigns.com.au W: areidesigns.com.au ABN: 31614195818 QBCC LIC: 15040397

AREI PLAN CODE: SERIES 10 ASH3

| CLIENT: **CAPITAL HOMES NQ** 

| DRAWING NAME: **FOUNDATION PLAN**  PROJECT:
PROPOSED RESIDENCE FOR LYN MOORE AT LOT 299 CATHERINE ATHERTON DR MAREEBA

PLAN NUMBER: 1173-18 DATE: 23/04/18

SCALE @ A3 1:100

PAGE NO: 07 OF 08 l drawn: N MCLEAN

REV. REVISION DESCRIPTION | APPROV. DATE PRELIMINARY ISSUE 09/04/18 CONSTRUCTION ISSUE 18/04/18 CONSTRUCTION ISSUE 19/04/18 CONSTRUCTION ISSUE 23/04/18

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# ELECTRICAL & FIXTURES LEGEND

SYMBOL DESCRIPTION

DOWN LIGHT RECESSED

→ FLUORO SINGLE 900mm

FLUORO DOUBLE 900mm

0 OYSTER FLUORO LIGHT

UP/DOWN LIGHT

EXTERIOR SENSOR LIGHT K

FLOOD LIGHT EXTERNAL K

FLOOD LIGHT EXTERNAL (2)

0 f o HEAT LAMP LIGHT

**GPO SINGLE GPO DOUBLE** 

GPO SINGLE WATERPROOF

GPO DOUBLE WATERPROOF

 $\overline{\Box}$ **TELEVISION POINT** 

PHONE/DATA POINT 83

**DISTRIBUTION BOX** 

€### **ANTENNA** 

METER BOX

• SMOKE DETECTOR

> AIR CON HEAD (SPLIT) AIR CON UNIT (SPLIT)

HOT WATER SYSTEM

FLOOR WASTE  $\odot$ **GAS BOTTLES** 

**HOSE COCK** 

EXHAUST CEILING FAN

EXHAUST WALL FAN

**CEILING FAN** 



# **ENERGY EFFICIENCY NOTES:**


- 1. ALL TAPWARE & SHOWERS TO BE 3 STAR MIN.
- 2. ALL TOILETS TO BE 4 STAR MIN.
- 3. ELECTRIC HOT WATER SYSTEM TO BE INSTALLED.
- 4. THIS LAYOUT HAS BEEN DESIGNED TO SHOW 100% ENERGY EFFICIENT LIGHTING, (INTERNAL, INCLUDING GARAGE). 5. F - INDICATES LIGHT FITTINGS TO HAVE ENERGY EFFICIENT
- FLOURESCENT GLOBES INSTALLED.

# POWER POINT HEIGHTS AFL

LIGHT SWITCHES 1150mm AFL WALL MOUNTED LIGHTS 2000mm AFL POWER OUTLETS (STANDARD) 300mm AFL

POWER OUTLETS OTHER M/WAVE OVEN ROWER 1800mm AFL M/WAVE UNDER BENCH 300mm AFL KITCHEN BENCH 1000mm AFL REFRIGERATOR 1500mm AFL **RANGEHOOD** 1800mm AFL D/WASH 300mm AFL 950mm AFL **VANITY BASINS** 1000mm AFL LAUNDRY BENCH 1500mm AFL W/MACHINE

**ELECTRICAL LINE** 

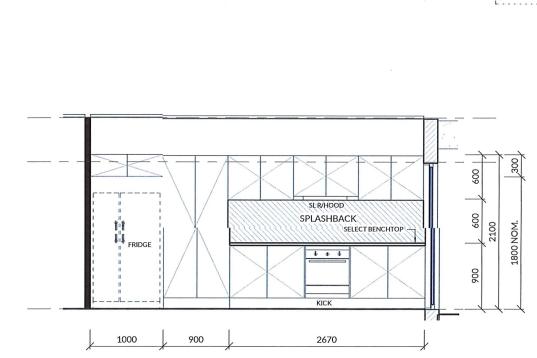



DRAWING NAME:

PROPOSED RESIDENCE FOR LYN MOORE AT LOT 299 CATHERINE ATHERTON DR | SCALE @ A3 1:100

PAGE NO: 08 OF 08 NMCLEAN 1010

PRELIMINARY ISSUE 09/04/18 CONSTRUCTION ISSUE 18/04/18 CONSTRUCTION ISSUE 19/04/18 CONSTRUCTION ISSUE 23/04/18

1930

**ELEVATION K2 - KITCHEN SOUTH** 

1:50

SELECT BENCHTOP

600 NOM.20

1010


DP

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**APPROVED** Permit No: 17000252 Date: 18 May 2018

The building work described on this drawing specification conforms with the provisions of the Building Act 1975 and is subject to the conditions of the Development

DP 0 (0) DP



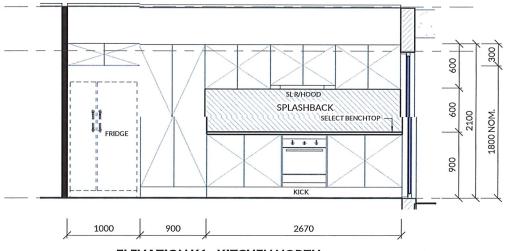

| CLIENT:

**CAPITAL HOMES NQ** 

| PLAN NUMBER: I DATE:

I DRAWN: I CHECKED: REV. REVISION DESCRIPTION APPROV. DATE



M: 0419 786 578 M: 0403 508 705 E: plans@areidesigns.com.au W: areidesigns.com.au ABN: 31614195818

AREI PLAN CODE:

**ELECTRICAL & FIXTURES PLAN** 



PO Box 154 MAREEBA QLD 4880 65 Rankin Street

**...** ≶ www.msc.qld.gov.au

Council Ref: DEV-APP-GEN:RP: krp

info@msc.qld.gov.au

Your Ref: PD/18/0060

17 May 2018

# **Compliance Permit**

Plumbing and Drainage Act 2002 s. 85(5)(a)

PO Box 937 MAREEBA QLD 4880 F Vittori

Dear Sir/Madam

PERMIT NO: PD/18/0060 SITUATED AT: Catherine Atherton Drive MAREEBA QLD 4880 LAND DESCRIBED AS: Lot 299 SP 250068

drainage work) under section 85 of the Plumbing and Drainage Act 2002 was decided on 17th May 2018 by the Mareeba Shire Council. Your application for the compliance assessment of plans for regulated work (that is plumbing and

Council has decided to issue you with a Compliance Permit subject to the following conditions:

- <u>(1)</u> All work to be in accordance with the requirements of the Plumbing and Drainage Act
- (2) and Drainage Regulation 2003. 48 hours notice must be given prior to all inspections. Inspection and Testing shall be in accordance with Section 20 of the Standard Plumbing

The following inspections are required:-

- Before plumbing or drainage under a floor slab are covered;
- e d c b Sanitary drainage below ground before backfill is placed;
  - Plumbing in the building before it is covered;
  - Once plumbing and drainage work is completed; and
- At other stages stated in the conditions on the compliance permit.

inspection) within seven days of completing the work. responsible person must make the request for the inspection under (d) (ie the final

- (3) The issue of this permit does not:-
- Indicate the effluent disposal will be satisfactory, OR
- Prejudice Council's right to require additional or remedial works
- **(**4**)** An as constructed plan of all plumbing and drainage works (drawn to scale) must be provided to Council prior to the issue of a Compliance Certificate.



5 Floor Level:

"lowest plumbing drainage fixture" includes shower waste, floor waste and wash-down must be at least 250mm above the finished ground level adjacent to the building (the term Height above overflow relief gully: The floor level of the lowest plumbing/drainage fixture

3500.2:2003 are complied with. The purpose of this condition is to ensure that the following requirements of AS/NZS

4.6.6.6 Height Below Lowest Fixture

A minimum height of 150mm shall be maintained between the top of the overflow gully riser and the lowest fixture connected to the drain.

3500.2.2003). the invert level of the overflow pipe, to the appropriate point given in Table 4.3 (in AS/NZS This height shall be measured vertically from the overflow level of the fully riser, or from

4.6.6.7 Height Above Surrounding Ground

gully riser is located in a path or a paved area, where it shall be finished at a level so as to overflow pipe, and the surrounding ground surface level shall be 75mm, except where the The minimum height between the top of the overflow gully riser, or the invert of the prevent the ponding and ingress of water.

(6) area and associated works which have note been visually inspected prior to the issue of a A Form 3 (Verification of Covered Works) must be provided to Council for the land disposal Compliance Certificate,

Drainage Regulation 2003 (SPDR). The following plans and documents were assessed for compliance with the Standard Plumbing

be rigorously enforced during the compliance assessment of the work. The plans and documents were not assessed for the use of certified items (s.30 SPDR) but this will

infrastructure Council notes that the proposed work may or may not involve connecting to sewerage and water

Services on 1300 308 461. Enquiries about this permit can be made to the Mareeba Shire Council's Building and Plumbing

Yours faithfully

ROBERT PRIZMIC

Licence No: 25630

ACTING SUPERVISOR OF BUILDING AND PLUMBING SERVICES

L C Moore

Unit 9 78-82 Trinity Beach Road TRINITY BEACH QLD 4879

PO Box 2784 **Emergent Building Approvals** 

MAREEBA QLD 4880



PO Box 154 MAREEBA QLD 4880 65 Rankin Street

בי ה 1300 308 461

**..** ≶ 07 4092 3323 www.msc.qld.gov.au

Council Ref: DEV-APP-GEN:RP: krp

info@msc.qld.gov.au

Your Ref: HSP/18/0002

17 May 2018

# **Compliance Permit**

Plumbing and Drainage Act 2002 s. 85(5)(a)

ATHERTON QLD 4883 PO Box 354 Roy Walker Plumbing

Dear Sir/Madam

RE: Catherine Atherton Drive MAREEBA QLD 4880

Permit Number: HSP/18/0002

drainage work) under section 85 of the Plumbing and Drainage Act 2002 was decided on 17th May 2018 by the Mareeba Shire Council. Your application for the compliance assessment of plans for regulated work (that is plumbing and

Council has decided to issue you with a Compliance Permit subject to the following conditions:

- **(1)** All work to be in accordance with the requirements of the Plumbing and Drainage Act
- (2) Plumbing and Drainage Regulation 2003 (48 hours notice must be given prior to all Inspection and Testing shall be in accordance with Section 20 of the Standard
- The issue of this permit does not:-
- Indicate the effluent disposal will be satisfactory, OR
- Prejudice Council's right to require additional or remedial works.
- be provided along with the Commissioning Certificate. An as constructed plan of the AWTS and Land Application Area, drawn to scale, must
- (5) provided to Council along with the Commissioning Certificate. Approval for On-site Sewage Treatment Plants. A copy of this service policy must be the number of inspection/service visits over the 12 months as required under the month initial service policy to the owner. The initial policy must contain provisions for The manufacturer, facility builder or the authorised representative, must furnish a 12

# CERTIFICATION

that the facility conforms to the design requirements and specifications and, that such equipment All on-site sewerage facilities must, following installation, be certified by the designer, certifying of this certificate must be supplied to the local government. conditions applied by Council. The owner should hold the certification documentation and a copy has been installed and commissioned in accordance with the manufacturer's instructions and, any

authority if required. This installation record should include: occupier of the facility being serviced by the on-site system and with the relevant regulatory Prepare a set of "as-built" or "work-as-executed" plans/details to be lodged with the owner or

- $\equiv$ A Detailed sketch showing the location of all parts of the wastewater system, site facilities (building, driveways, etc.) and property boundaries;
- (ii) Details of setback, irrigation areas, reserve areas;
- $\equiv$ sizes and capacities of any equipment, such as a pump and the wastewater-
- (iv) The equipment supplier's repair or maintenance agency;
- (v) The servicing schedule and duties.

# **OPERATION AND MAINTENANCE**

sewerage facilities require a high degree of user dedication in maintenance, to ensure that the design performance of the facility is achieved for the expected On-site sewerage facilities are prone to failure if operated and maintained incorrectly. All on-site terms of operation and

Operation and maintenance procedures are to be set out for all aspects of the on-site sewerage should ensure that: facility by the designer, manufacturer and/or facility builder. The administration procedures

- (a) Operation and maintenance guidelines are available to all owners and users of an on-site sewerage facility;
- **b** appropriate to the nature and type of treatment and land application facility and, in accordance with the manufacturer's/facility builder's instructions; and and maintenance procedures are undertaken to മ regular schedule
- (c)occupier and/or use or development of the site. Continuity of operation and maintenance is achieved throughout changes of ownership,

# MAINTENANCE

Sewage Treatment Plant and include with the rates notice or other regular communication, a current maintenance contract where applicable under the Conditions of Approval of the On-site The local government must ensure that owners of on-site sewerage facilities are in possession of reminder of their maintenance obligations.

Drainage Regulation 2003 (SPDR). The following plans and documents were assessed for compliance with the Standard Plumbing

be rigorously enforced during the compliance assessment of the work. The plans and documents were not assessed for the use of certified items (s.30 SPDR) but this will

Council notes that the proposed work may or may not involve connecting to sewerage and water infrastructure.

Services on 1300 308 461. Enquiries about this permit can be made to the Mareeba Shire Council's Building and Plumbing

Yours faithfully

IIIIM '

ROBERT PRIZMIC

Licence No: 25630

ACTING SUPERVISOR OF BUILDING AND PLUMBING SERVICES

CC To:

Emergent Building Approvals P Box 2784

MAREEBA QLD 4880

CC To:

Unit 9 78-82 Trinity Beach Road TRINITY BEACH QLD 4879